

CITY OF KIRKLAND CIP NUMBER 132ND SQUARE PARK STORMWATER RETROFIT

TACOMA · SEATTLE · SPOKANE · TRI-CITIES

1200 6th Avenue, Suite 1620 Seattle, WA 98101

FUNDED IN PART BY THE
WASHINGTON STATE
DEPARTMENT OF ECOLOGY

DECEMBER 2020

JOB NO. XX-XX-PW

CITY OFFICIALS

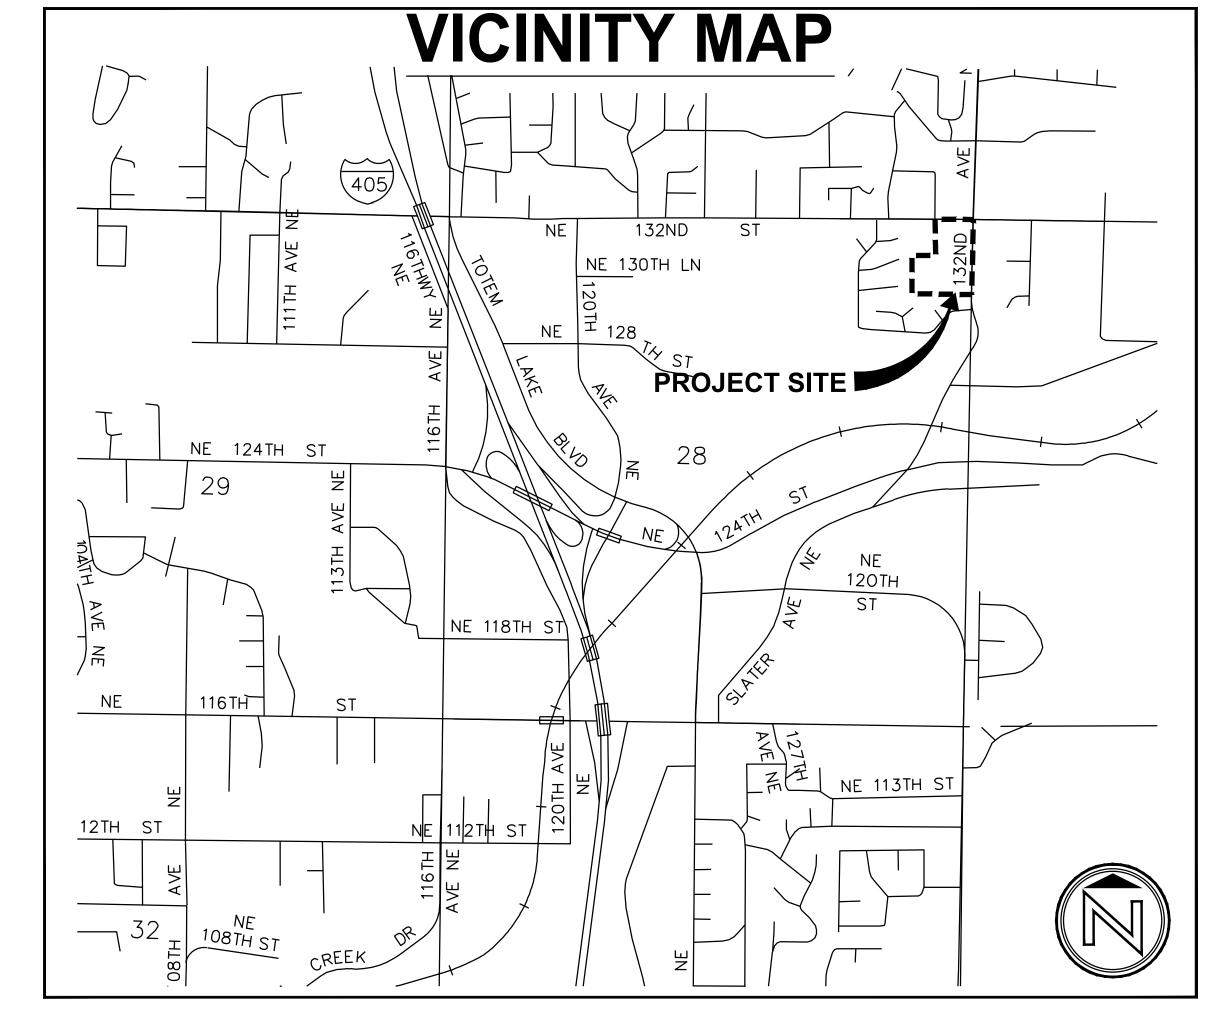
PENNY SWEET JAY ARNOLD **DEPUTY MAYOR** TOM NEIR **COUNCIL MEMBER TOBY NIXON COUNCIL MEMBER KELLI CURTIS COUNCIL MEMBER** DAVE ASHER COUNCIL MEMBER JON PASCAL **COUNCIL MEMBER KURT TRIPLETT** CITY MANAGER KATHY BROWN PUBLIC WORKS DIRECTOR **ROD STEITZER** CAPITAL PROJECTS MANAGER

CONTACT PERSONNEL

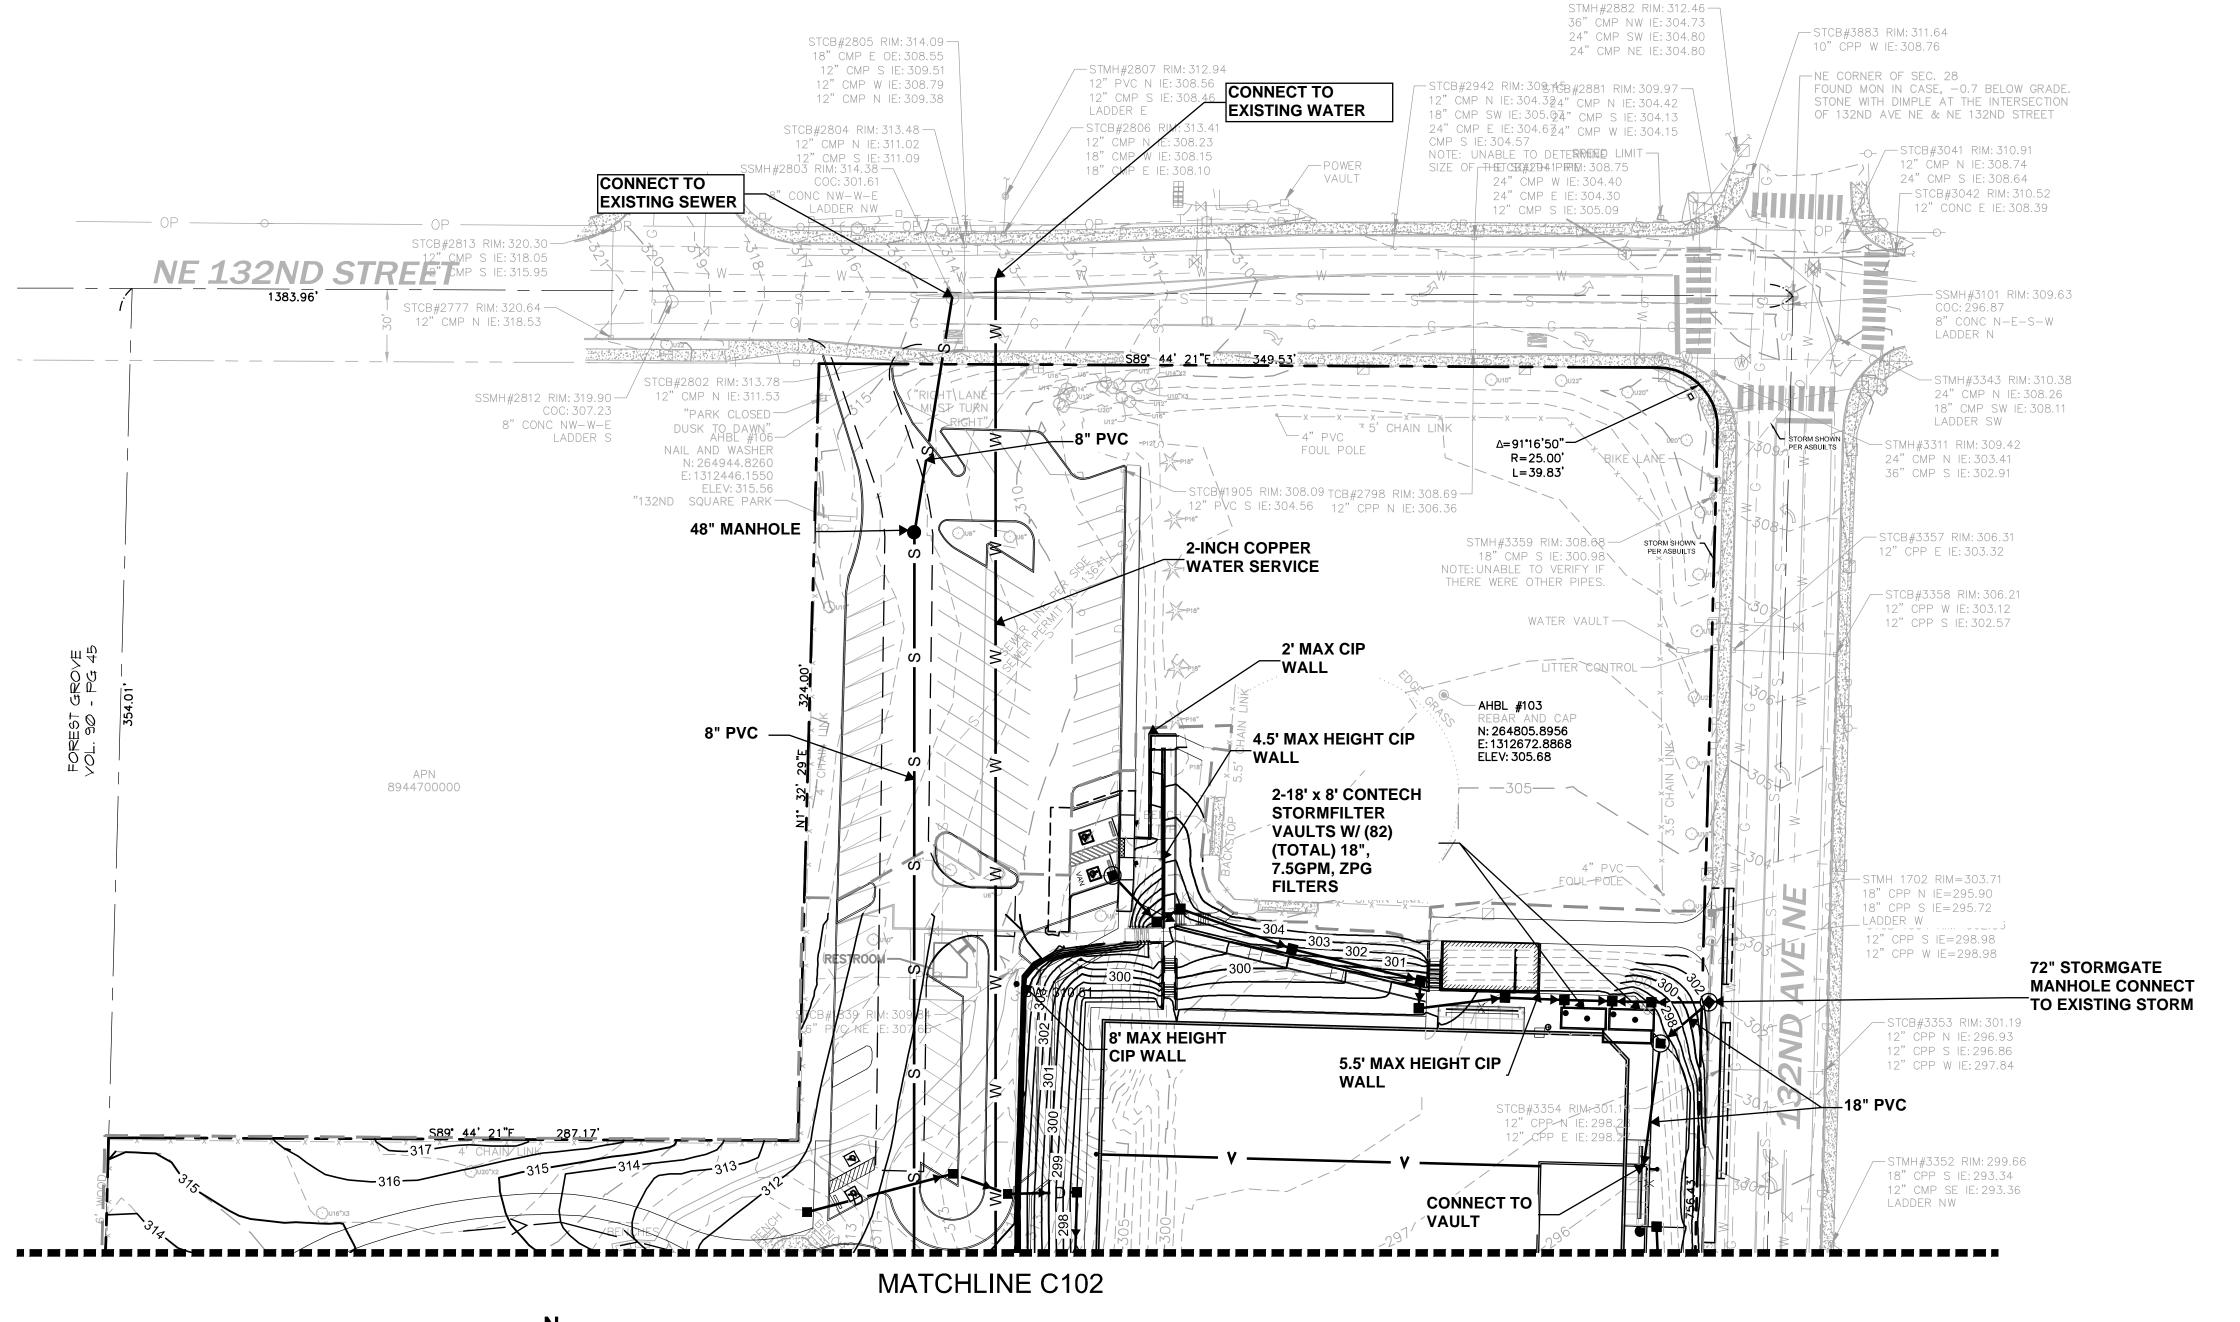
NAME	
DOREEN GAVIN, P.E.	AHE
BRIAN BAKER	COŁ
LEE WINSTON, P.E.	COŁ
NATHEN HOWER	COŁ
DENNIS BOOTH	PSE
JEANNE COLEMAN	PSE
GEORGE MATOTE	NOF
JOE FORDON	CON
TOM CHRIEST	WA
JASON OSBORN	STC
JAY SCHWAB	FRC
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30% DESIGN SUBMITTAL
PRELIMINARY
NOT FOR CONSTRUCTION

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AGENCY	PHONE
AHBL, INC. COK PROJECT ENGINEER COK STORM/SEWER COK PW STREETS PSE (ELECTRIC) PSE (GAS) NORTHSHORE UTILILTY DISTRICT COMCAST WATER/SEWER STORM FRONTIER COMMUNICATIONS COK POLICE COK FIRE COK SPILL RESPONSE HOTLINE EMERGENCY ONE CALL LOCATES	253-383-2422 425-587-3874 425-587-3916 425-587-3904 425-587-6550 425-398-4400 425-263-5348 425-587-3910 425-587-3901 425-587-3435 425-587-3722 425-587-3900 911 1-800-424-5555



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ARCHITECTURE DRAWINGS				
ARCHITECTURAL PLANS				
ARCHITECTURAL PLANS				
ARCHITECTURAL ELEVATIONS				
ARCHITECTURAL ELEVATIONS				
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CAL DRAWINGS				
MECHANICAL NOTES				
MECHANICAL SCHEDULES				
MECHANICAL PLAN				
MECHANICAL PLAN				
DWG. NO.				
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SHEET				



NOTE
ALL STORM PIPE UNLESS
OTHERWISE STATED SHALL BE
12-INCH PVC.

LEGEND

CATCH BASIN - TYPE II

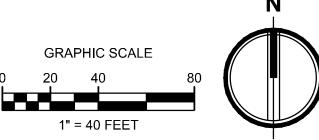
CATCH BASIN - TYPE I

D STORM DRAINAGE PIPING
SANITARY SEWER
WATER PIPING
SANITARY SEWER MANHOLE

CLEANOUT

PROPOSED MINOR CONTOUR

PROPOSED MAJOR CONTOUR



DWG. NO. C101



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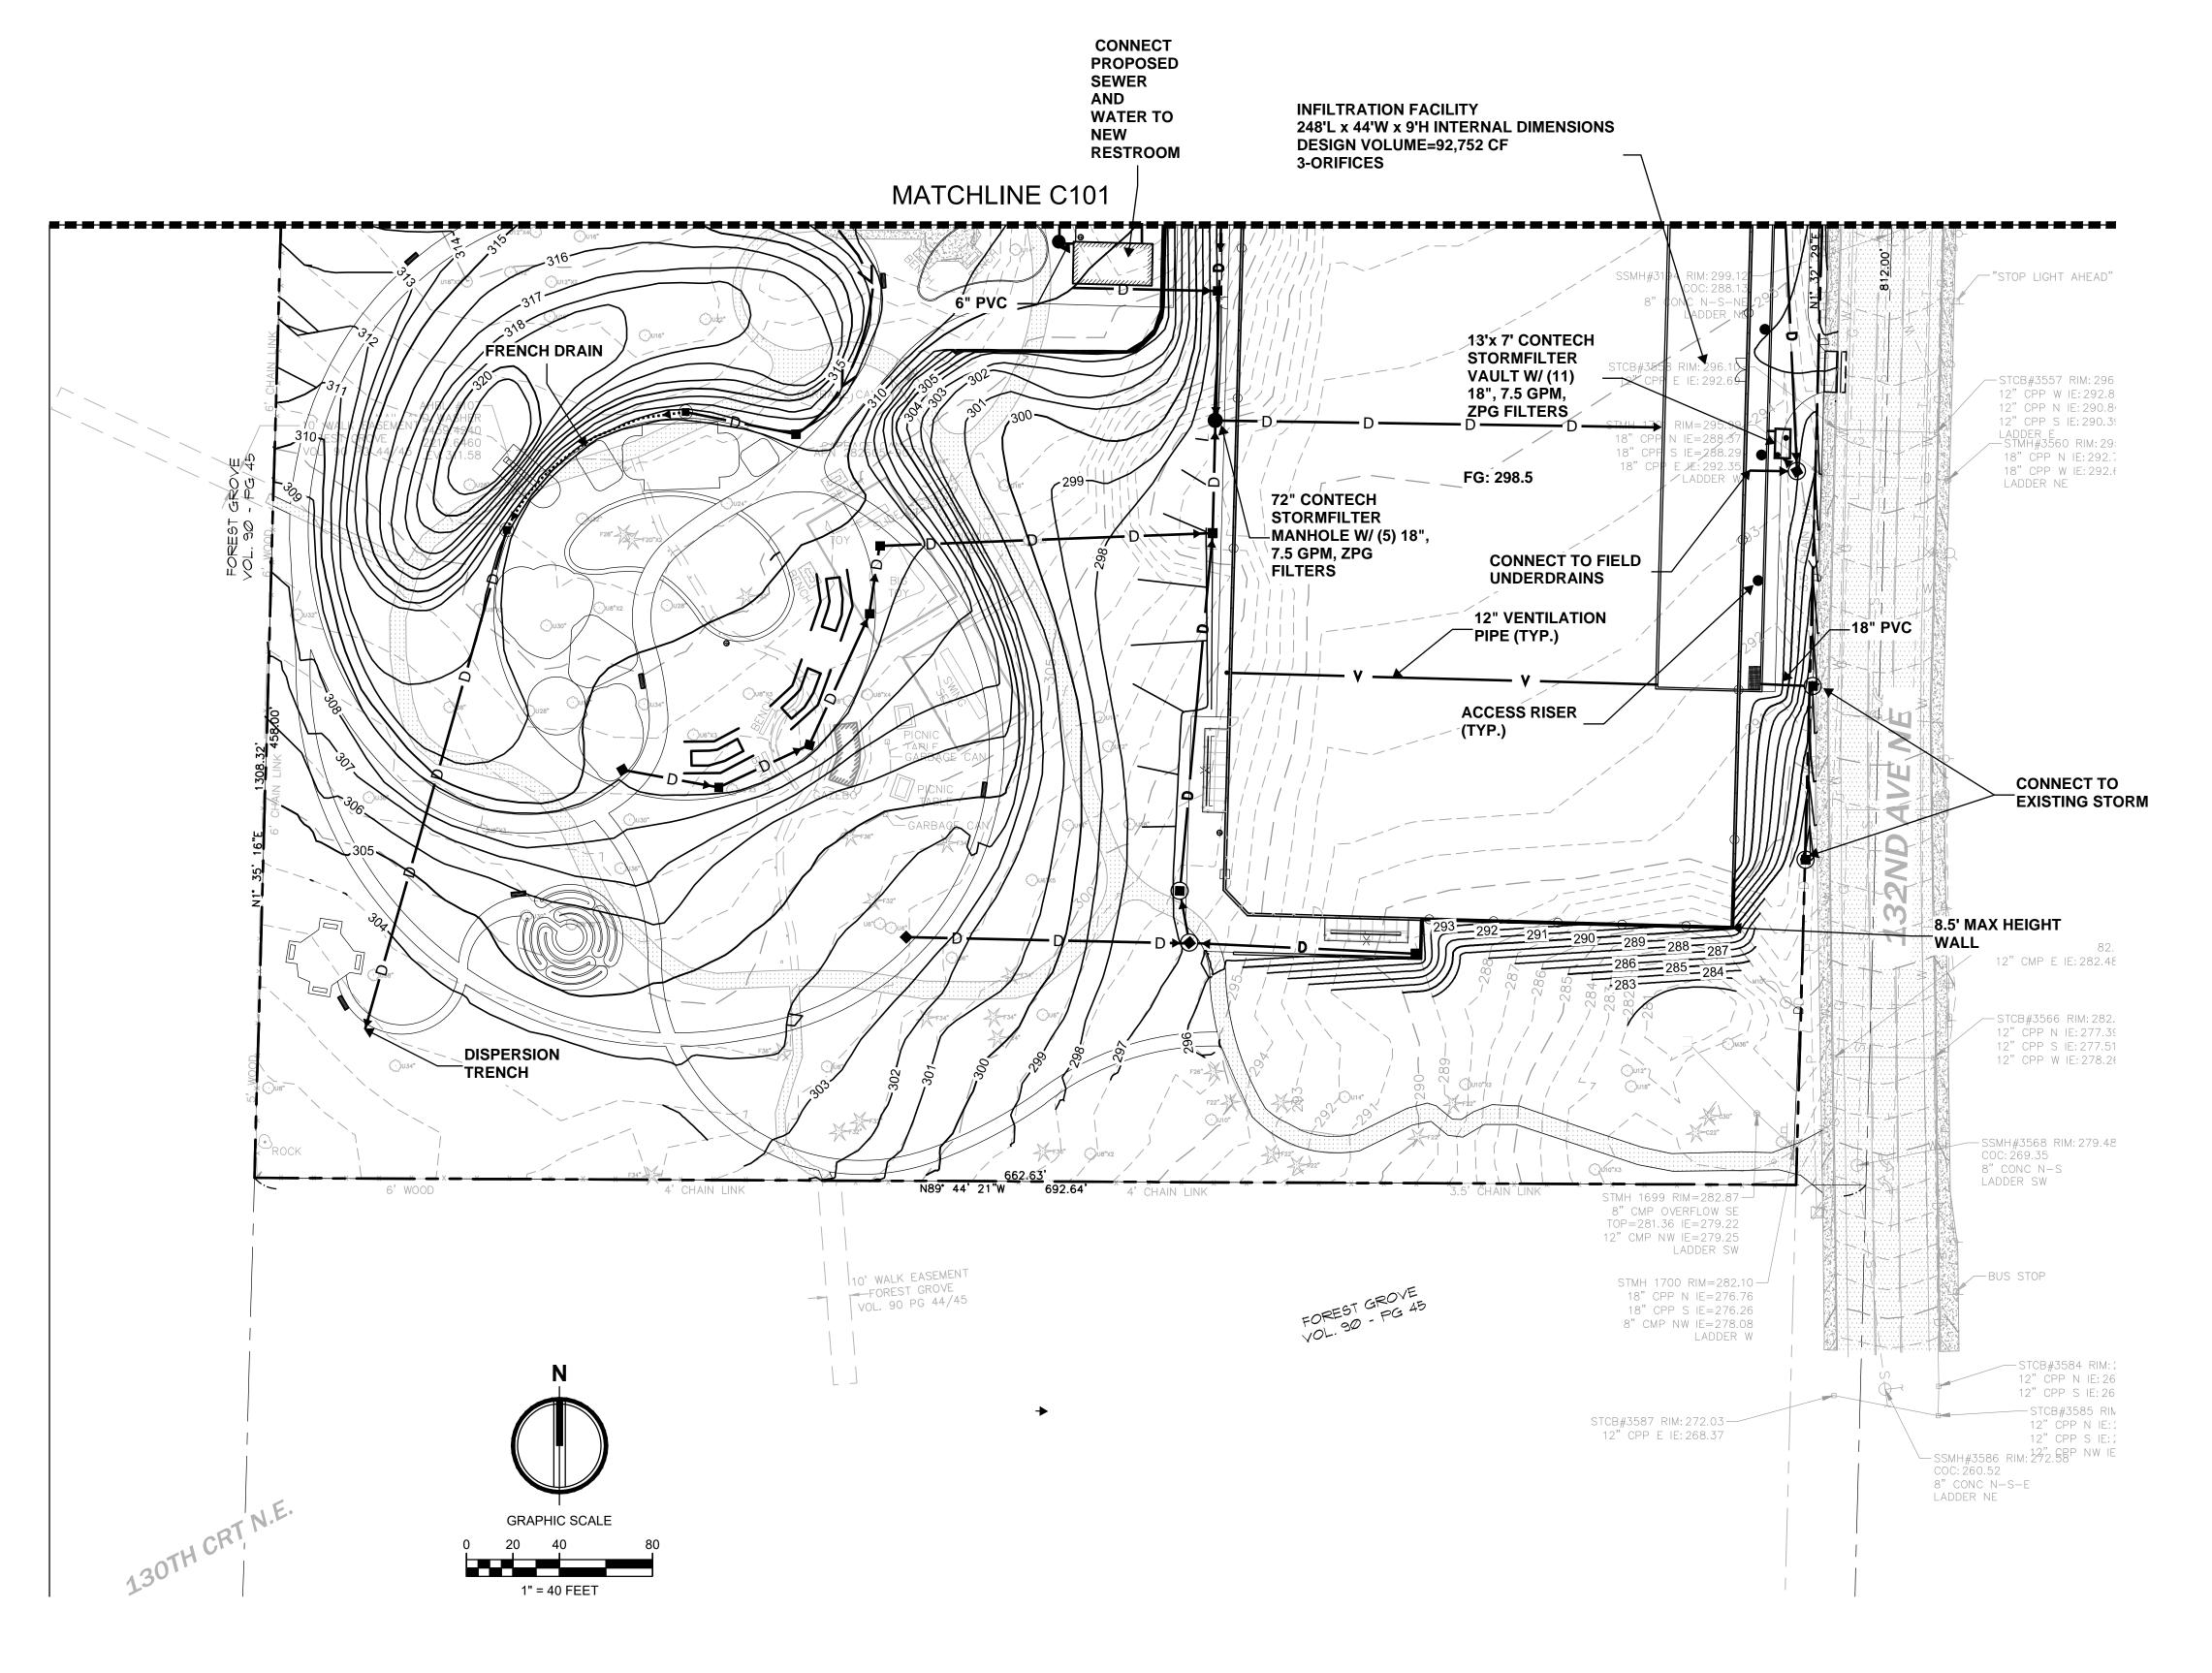


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132ND SQUARE PARK STORMWATER RETROFIT 30% DESIGN



NOTE
UNLESS OTHERWISE STATED ALL
STORM PIPE SHALL BE 12-INCH

LEGEND

PVC.

CATCH BASIN - TYPE II

CATCH BASIN - TYPE I

D STORM DRAINAGE PIPING

SANITARY SEWER

WATER PIPING

SANITARY SEWER MANHOLE

CLEANOUT

PROPOSED MINOR CONTOUR

PROPOSED MAJOR CONTOUR

DWG. NO. C102



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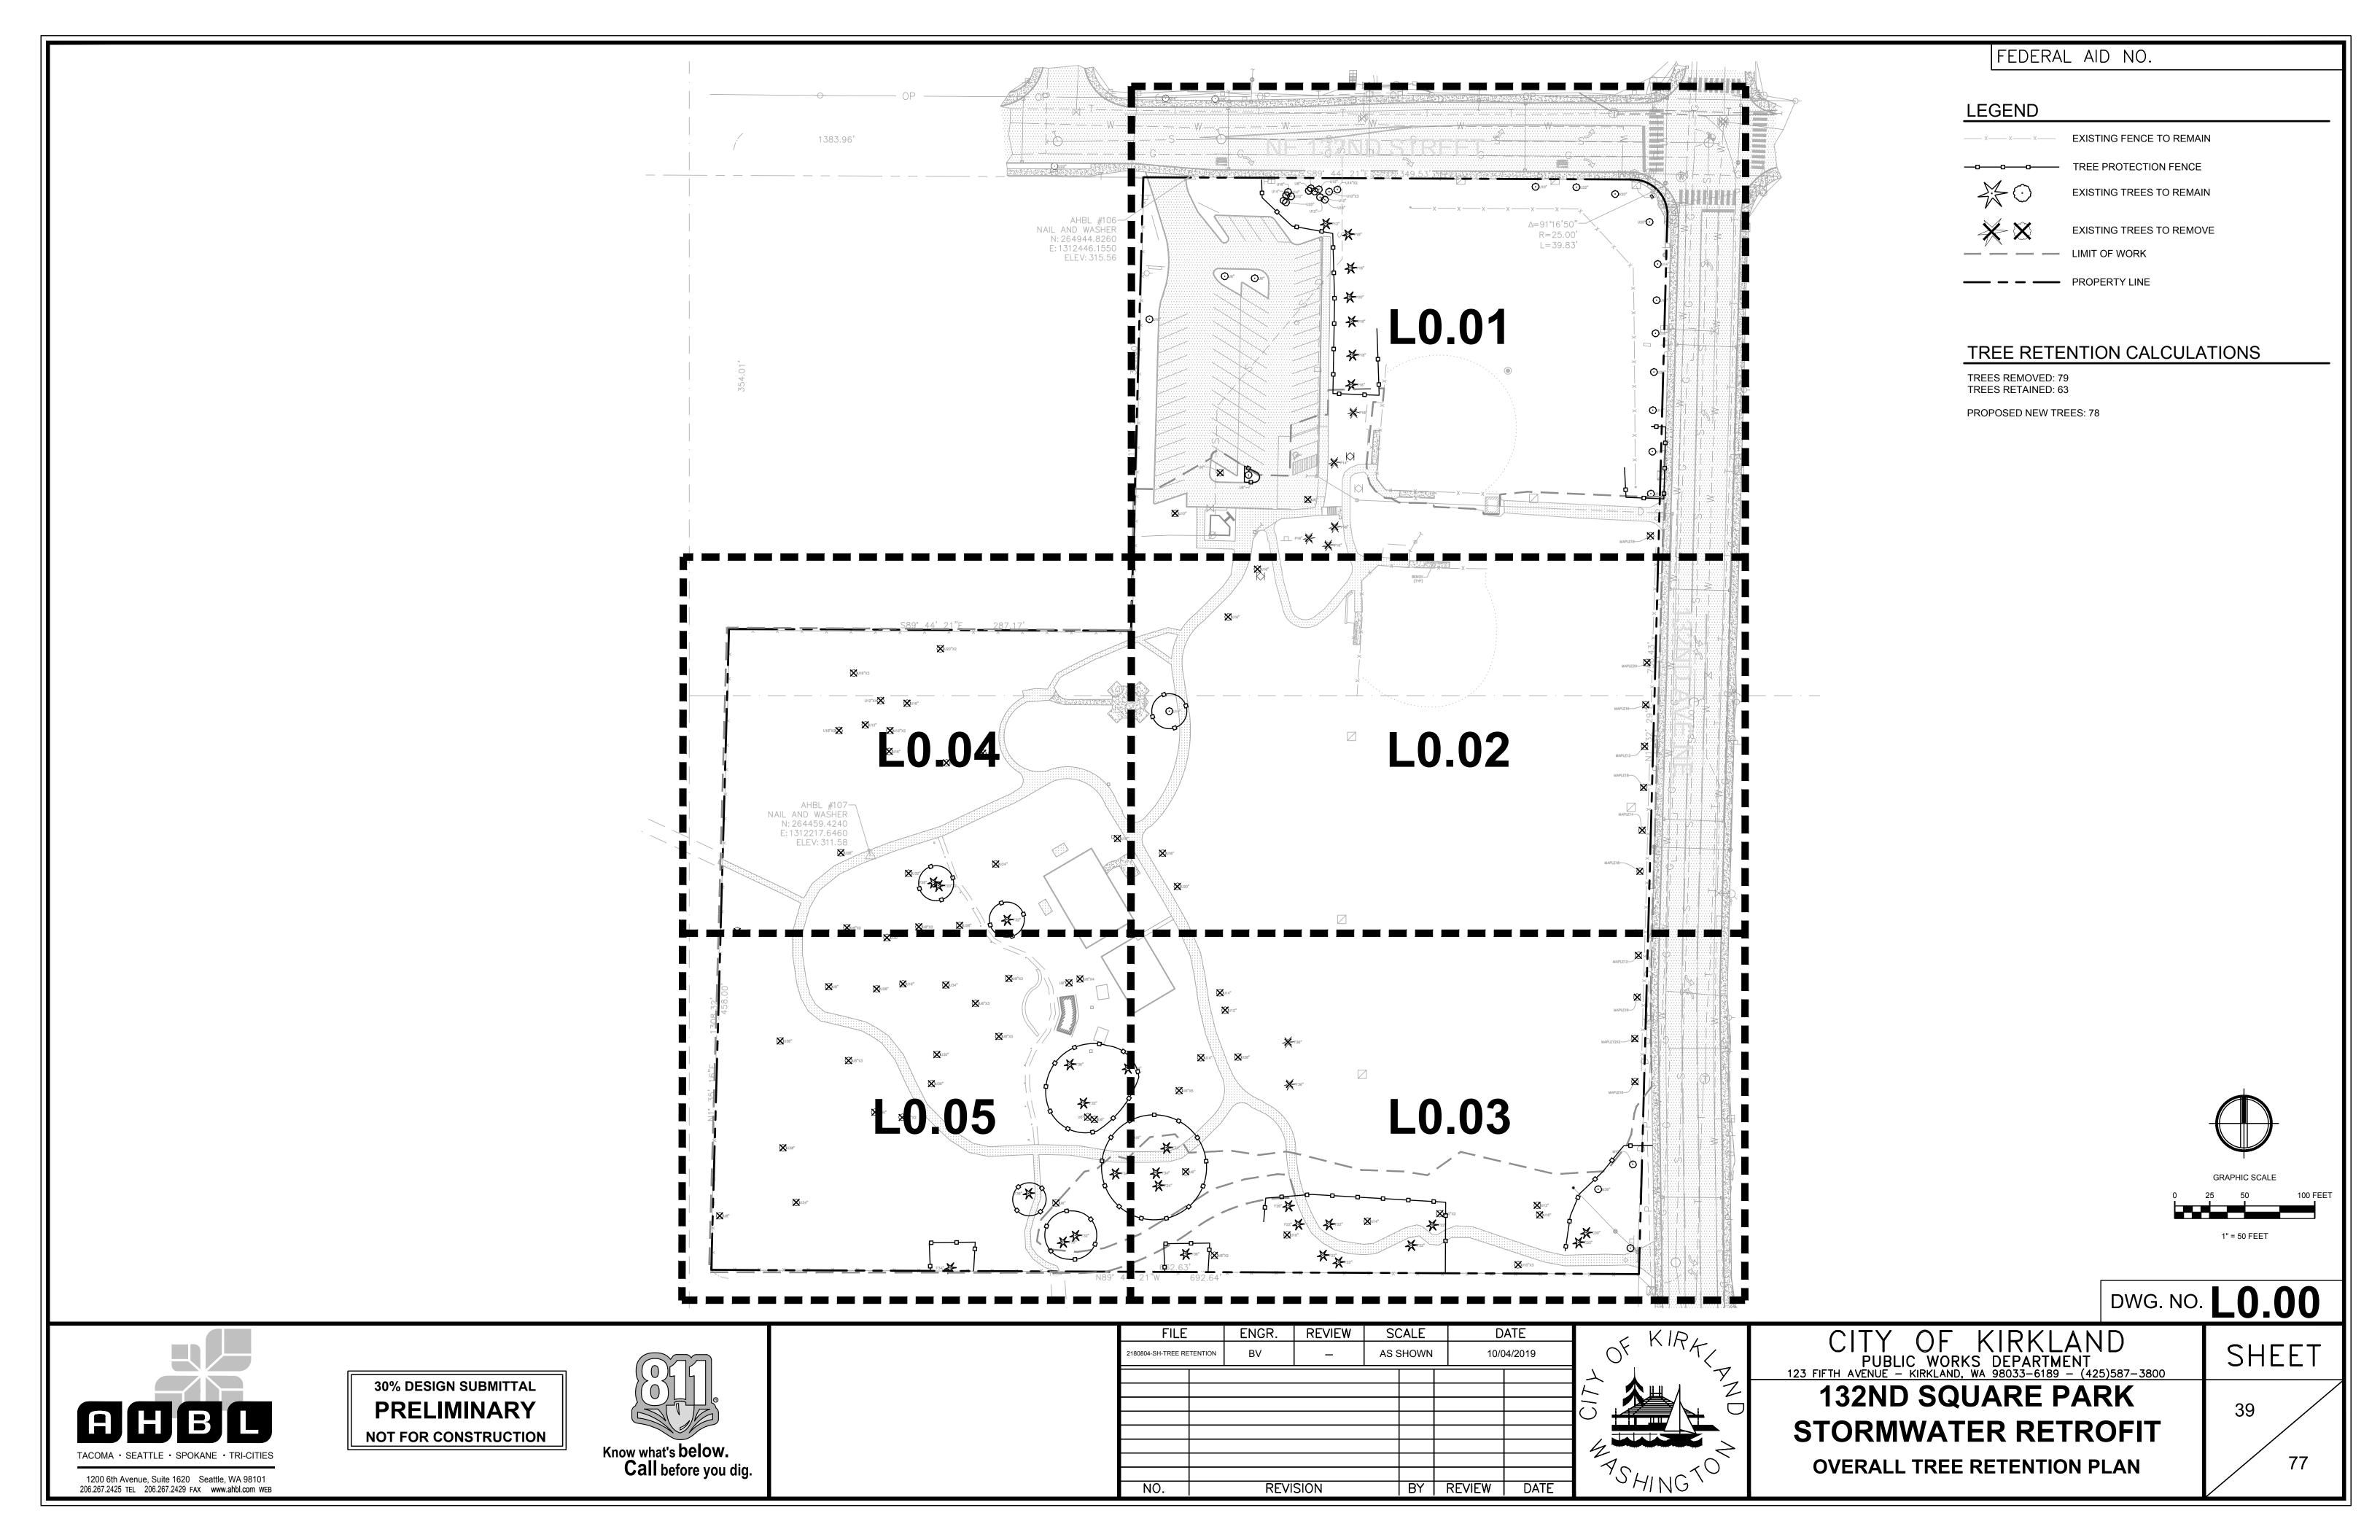
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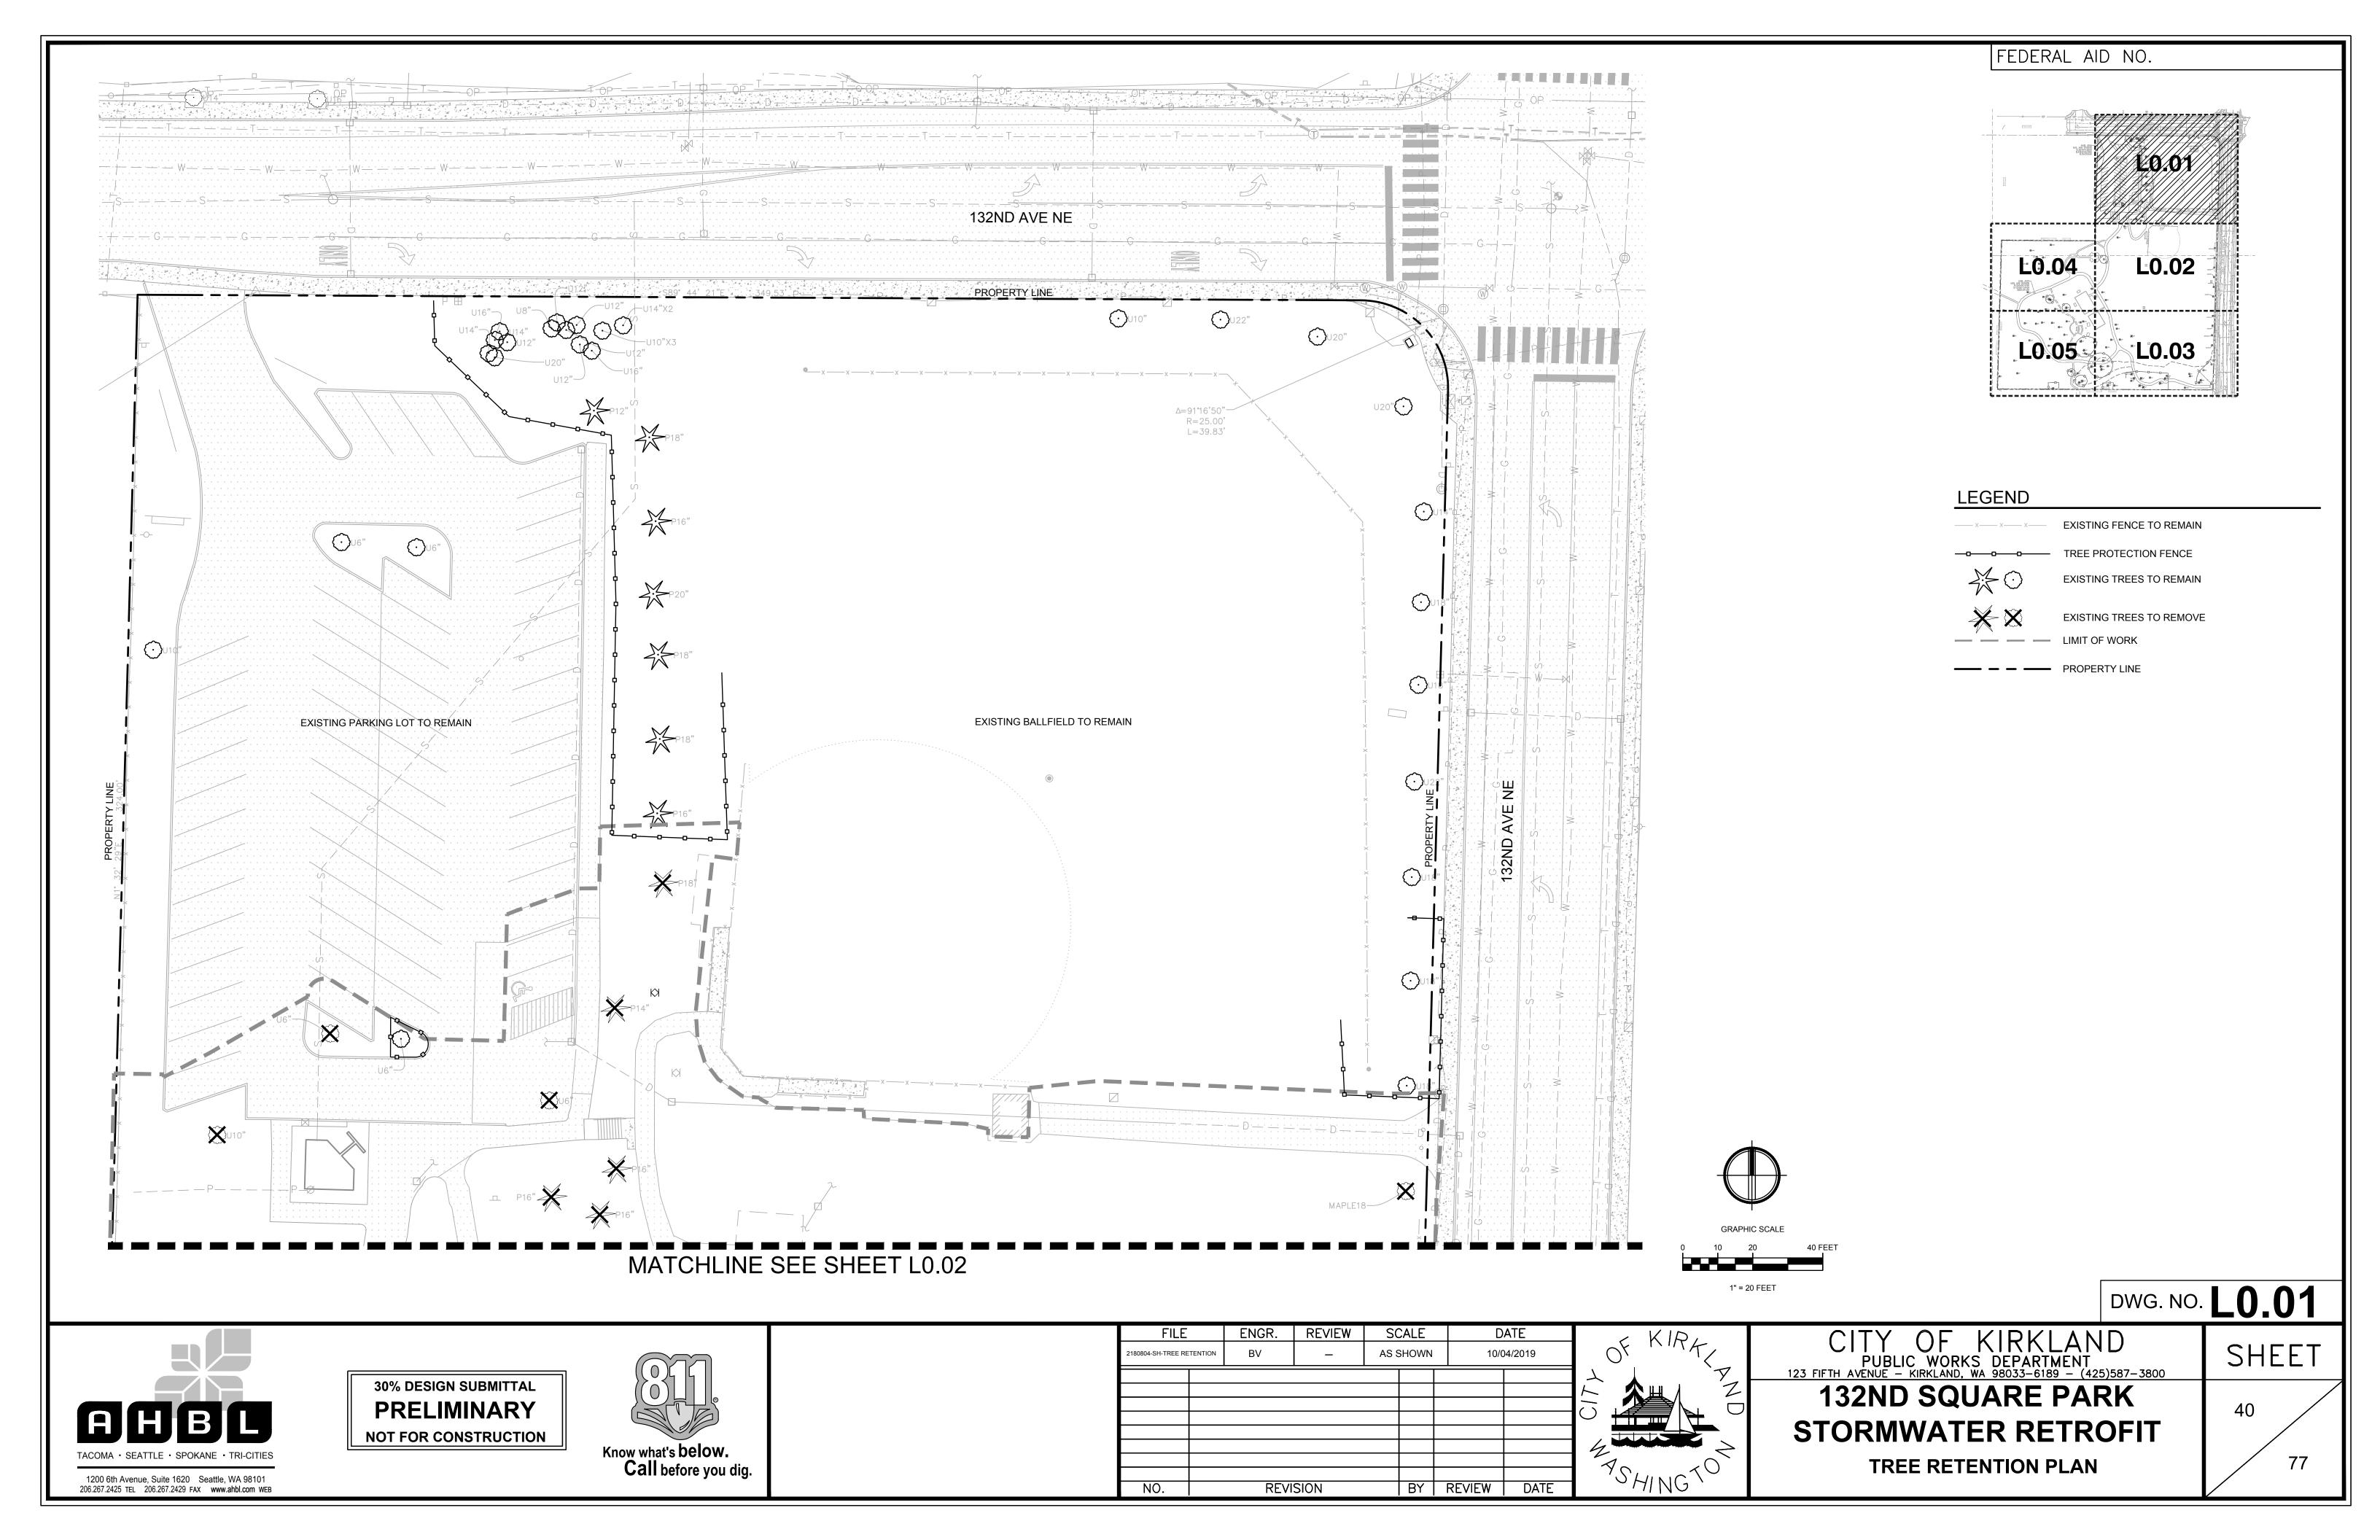
132ND SQUARE PARK STORMWATER RETROFIT 30% DESIGN

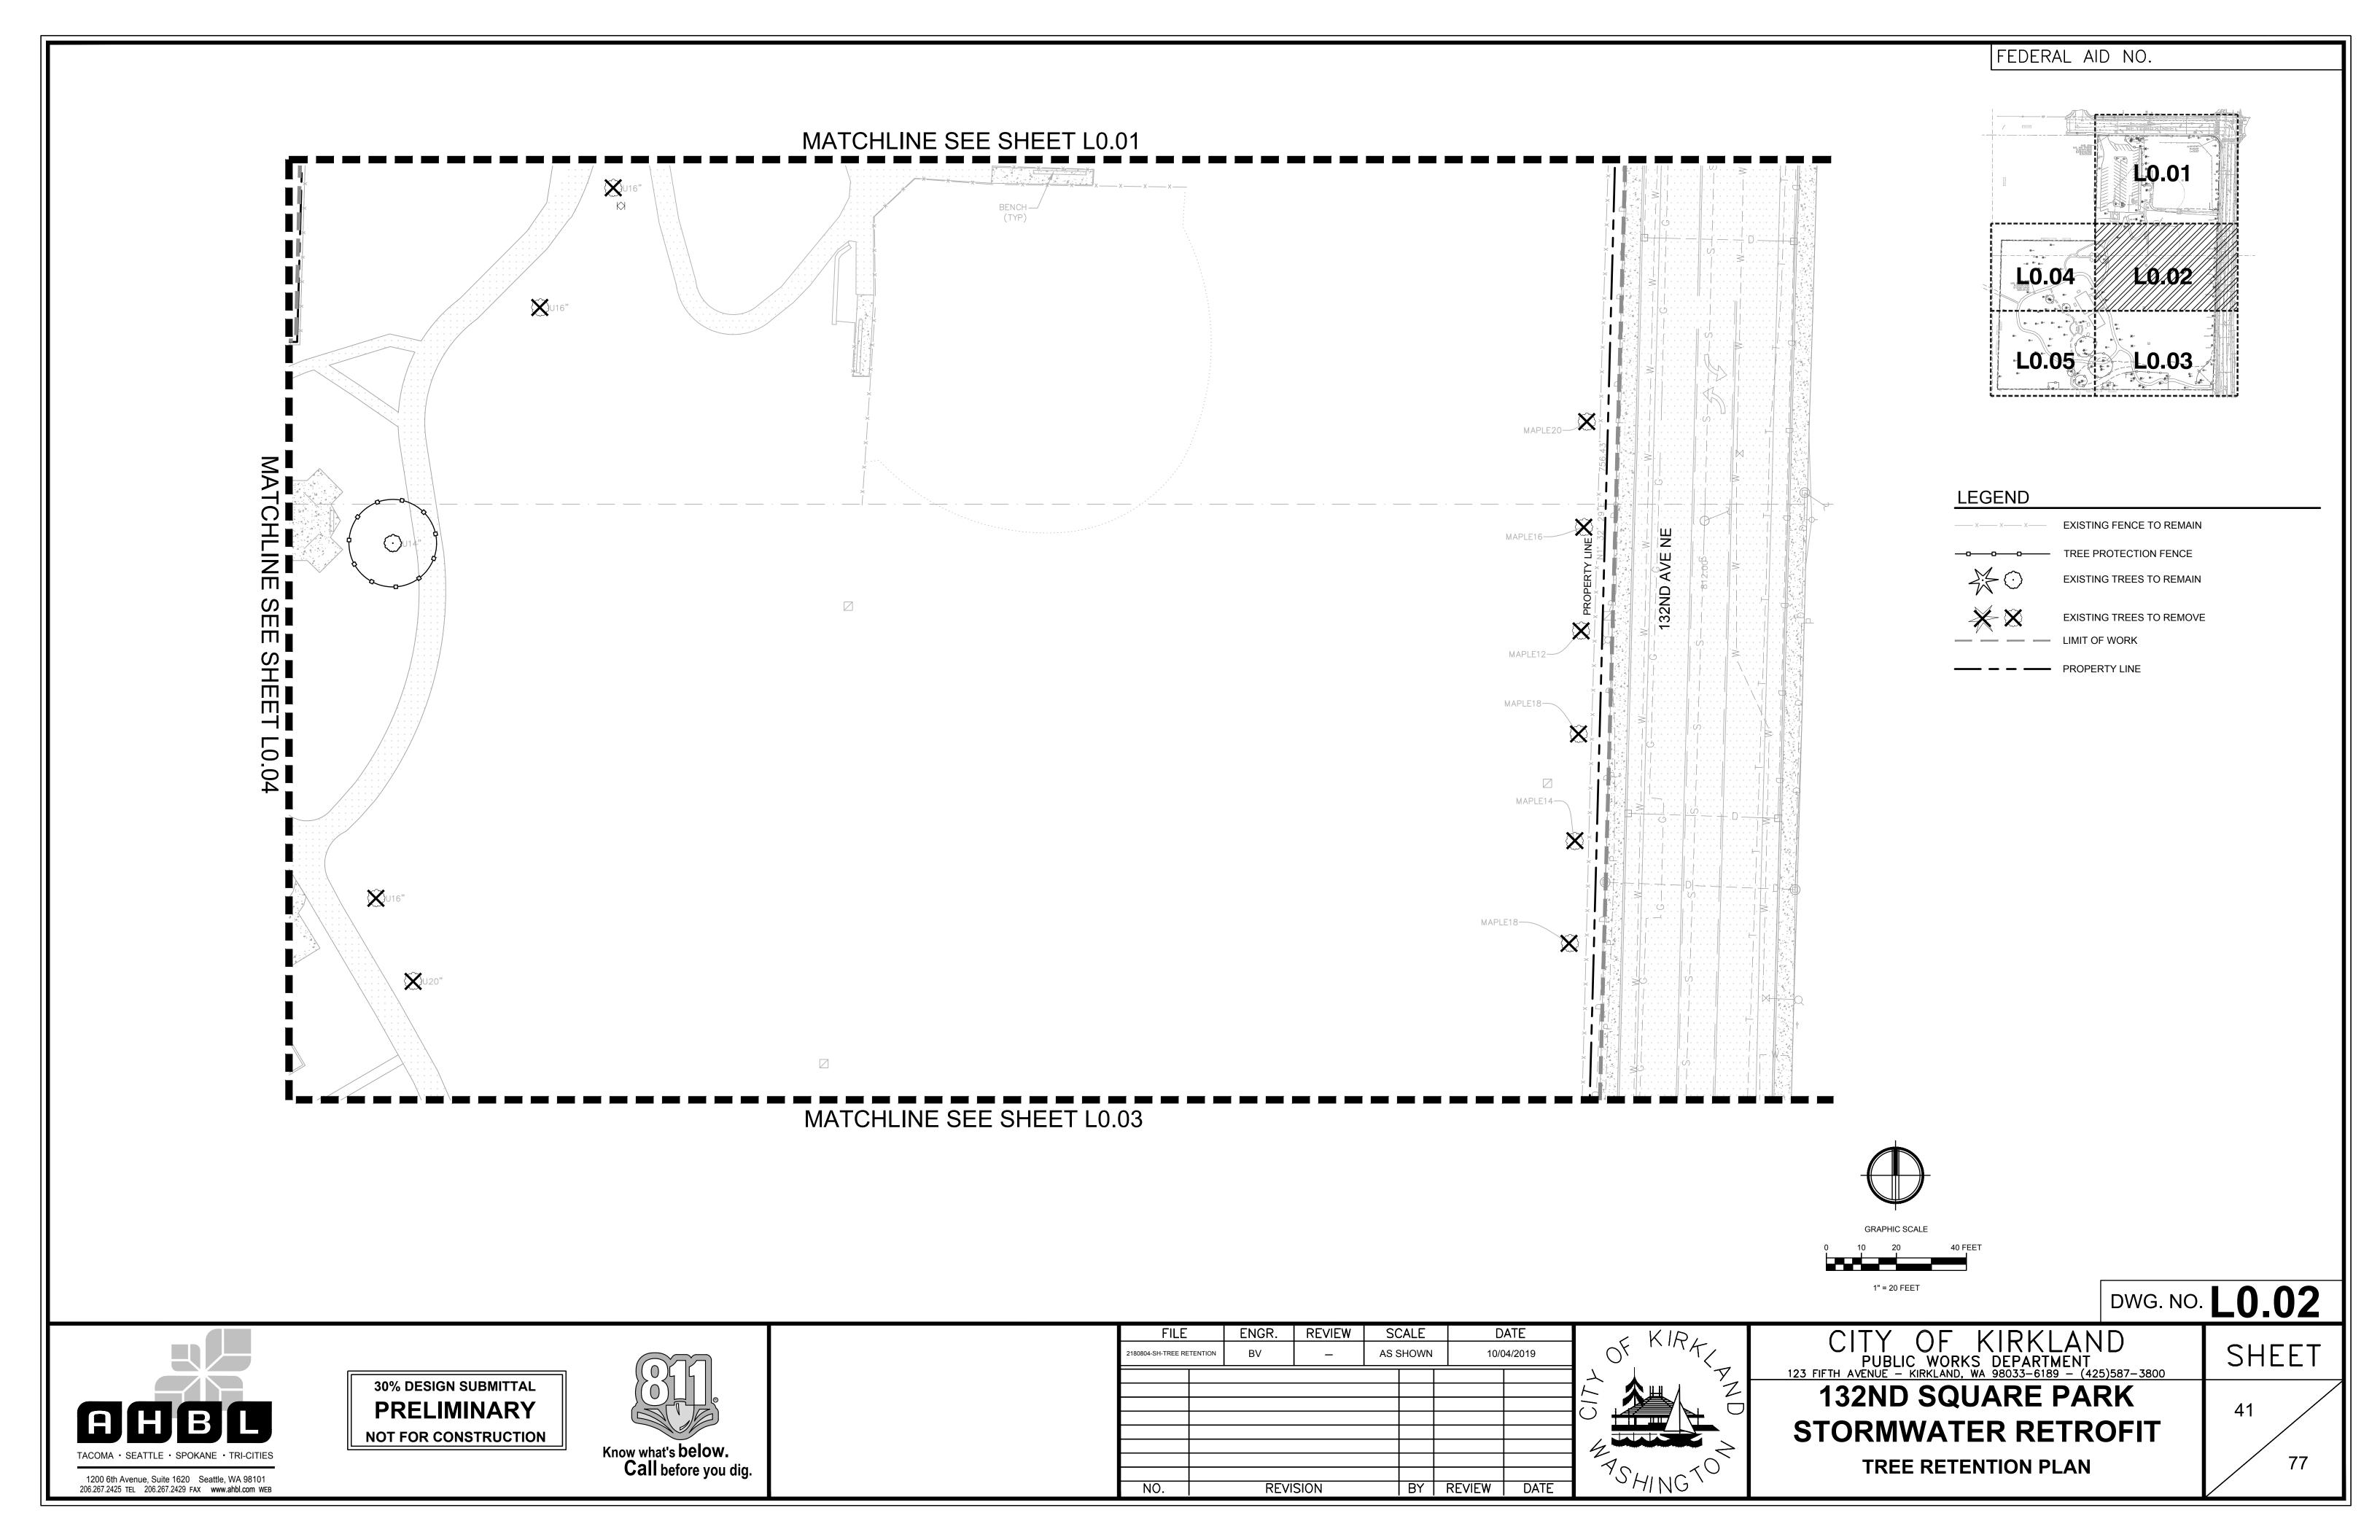
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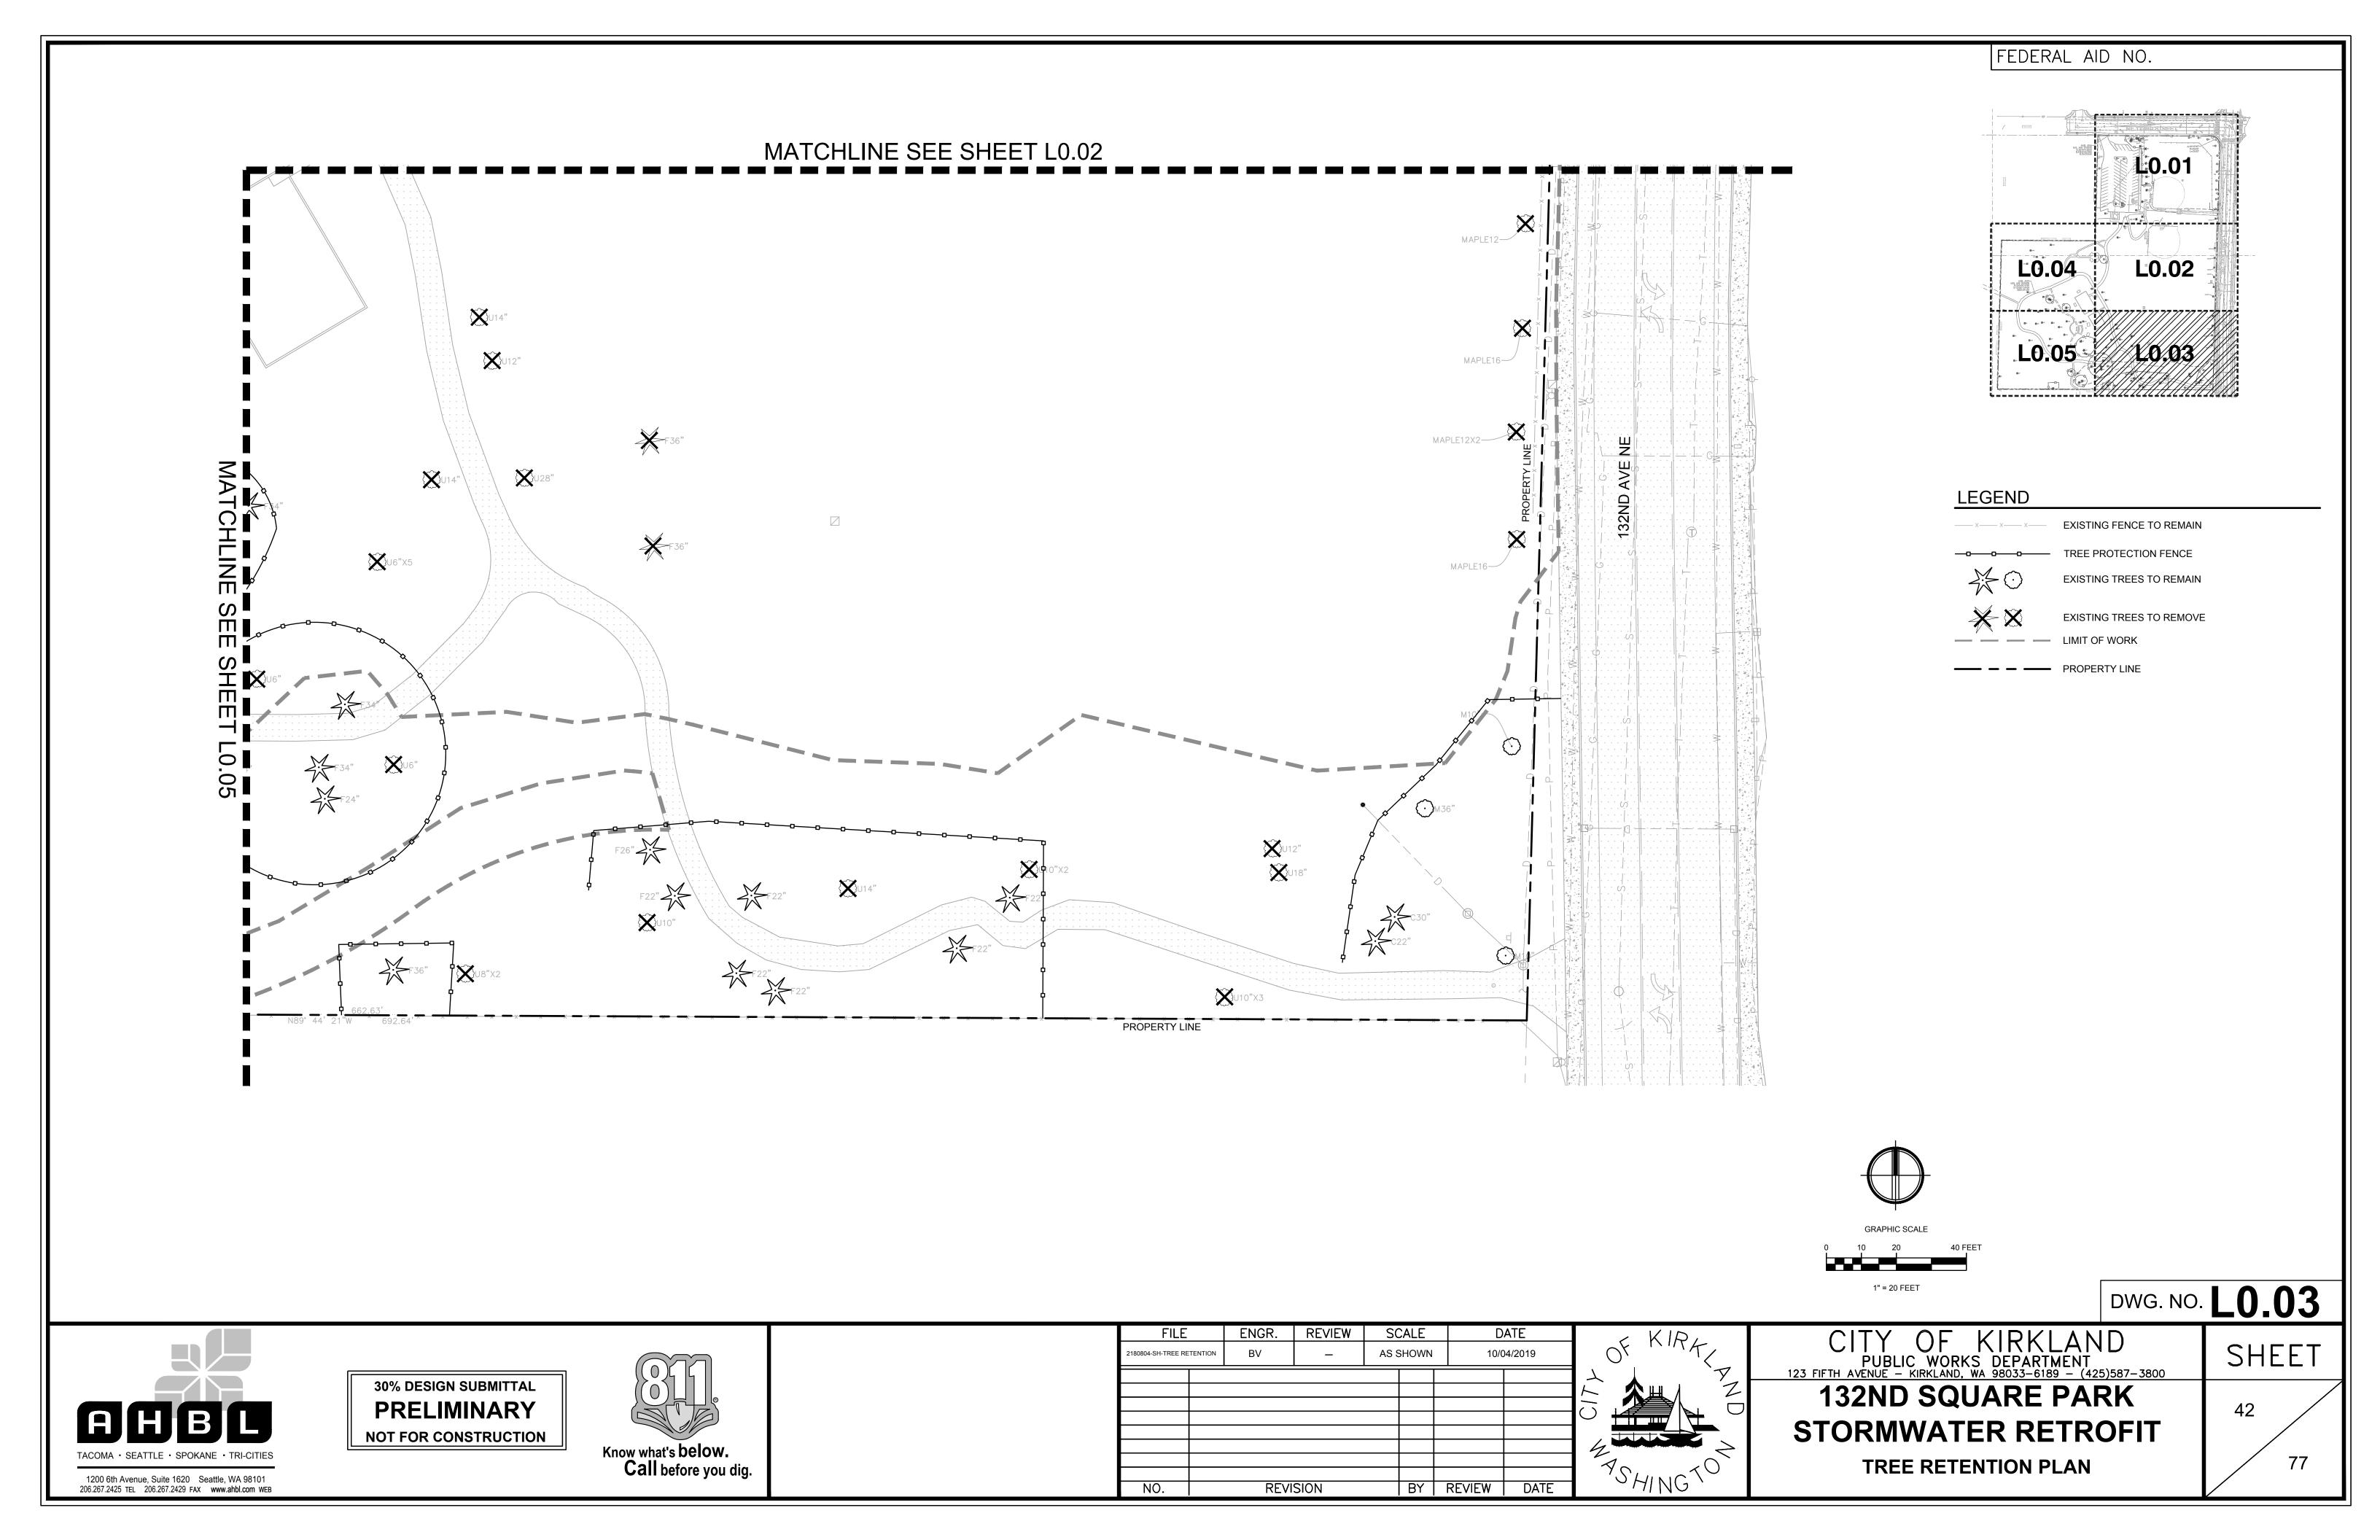
ND. WA 98033-6189 - (425)587-3800

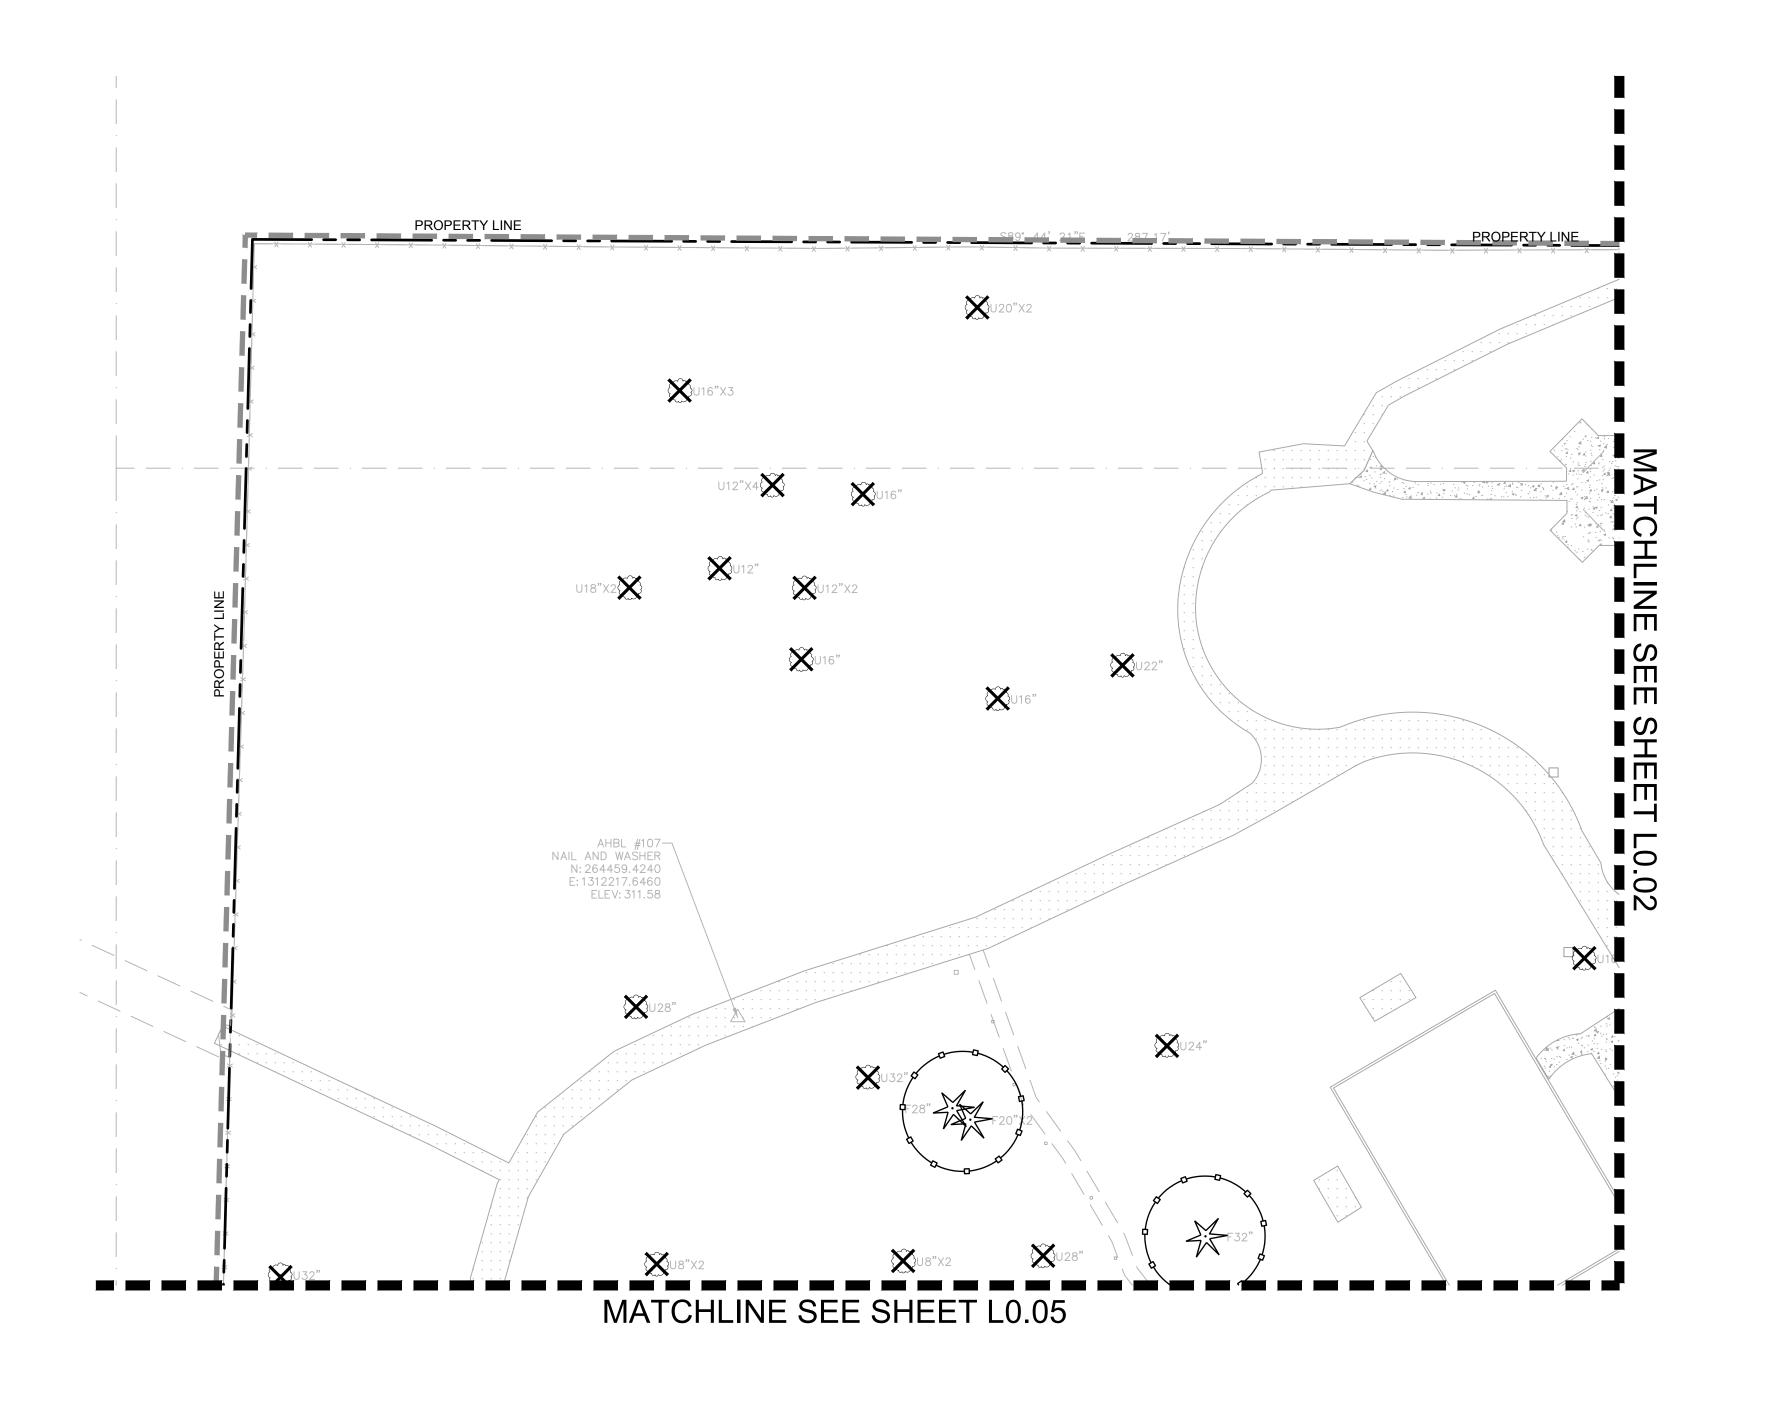
QUARE PARK

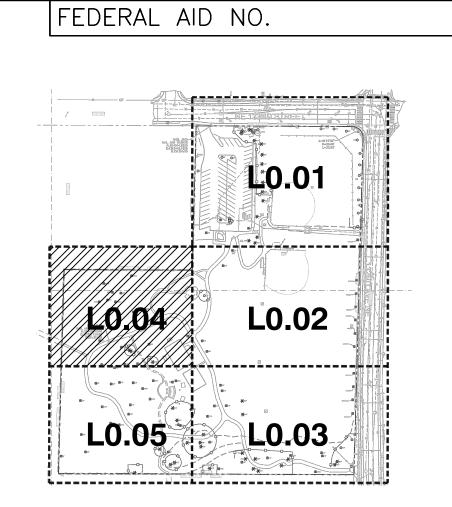












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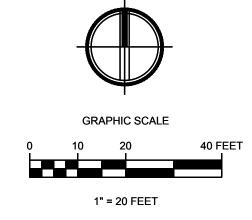
TREE PROTECTION FENCE

EXISTING TREES TO REMAIN

EXISTING TREES TO REMOVE

LIMIT OF WORK

PROPERTY LINE



DWG. NO. **L0.04**



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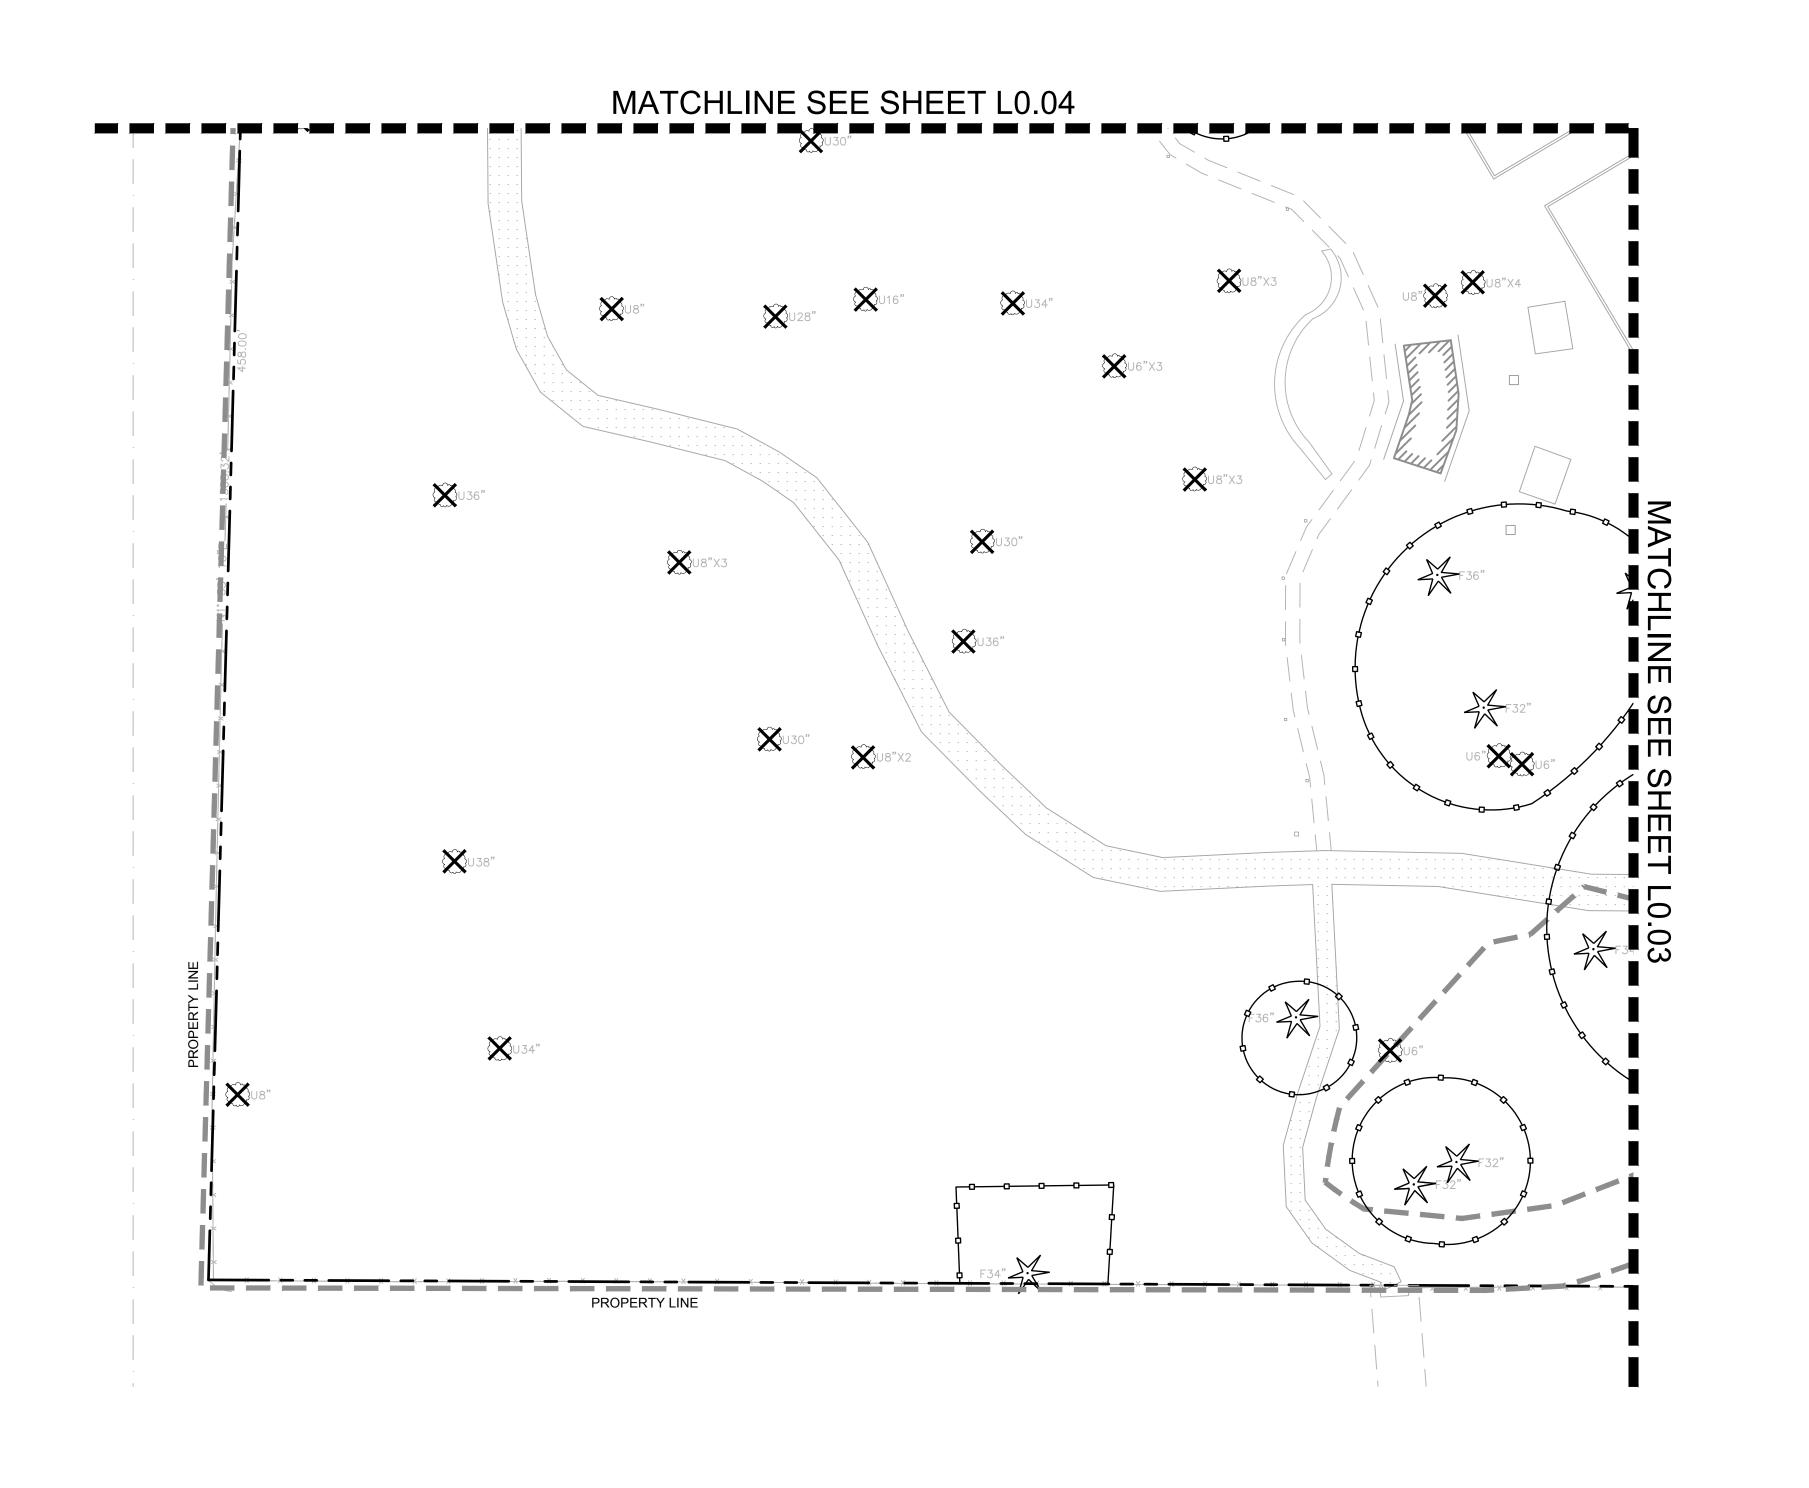
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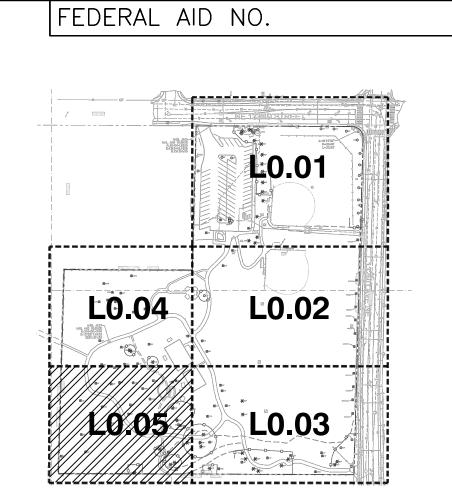


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132ND SQUARE PARK

132ND SQUARE PARK
STORMWATER RETROFIT
TREE RETENTION PLAN

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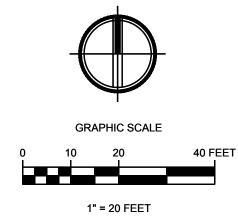
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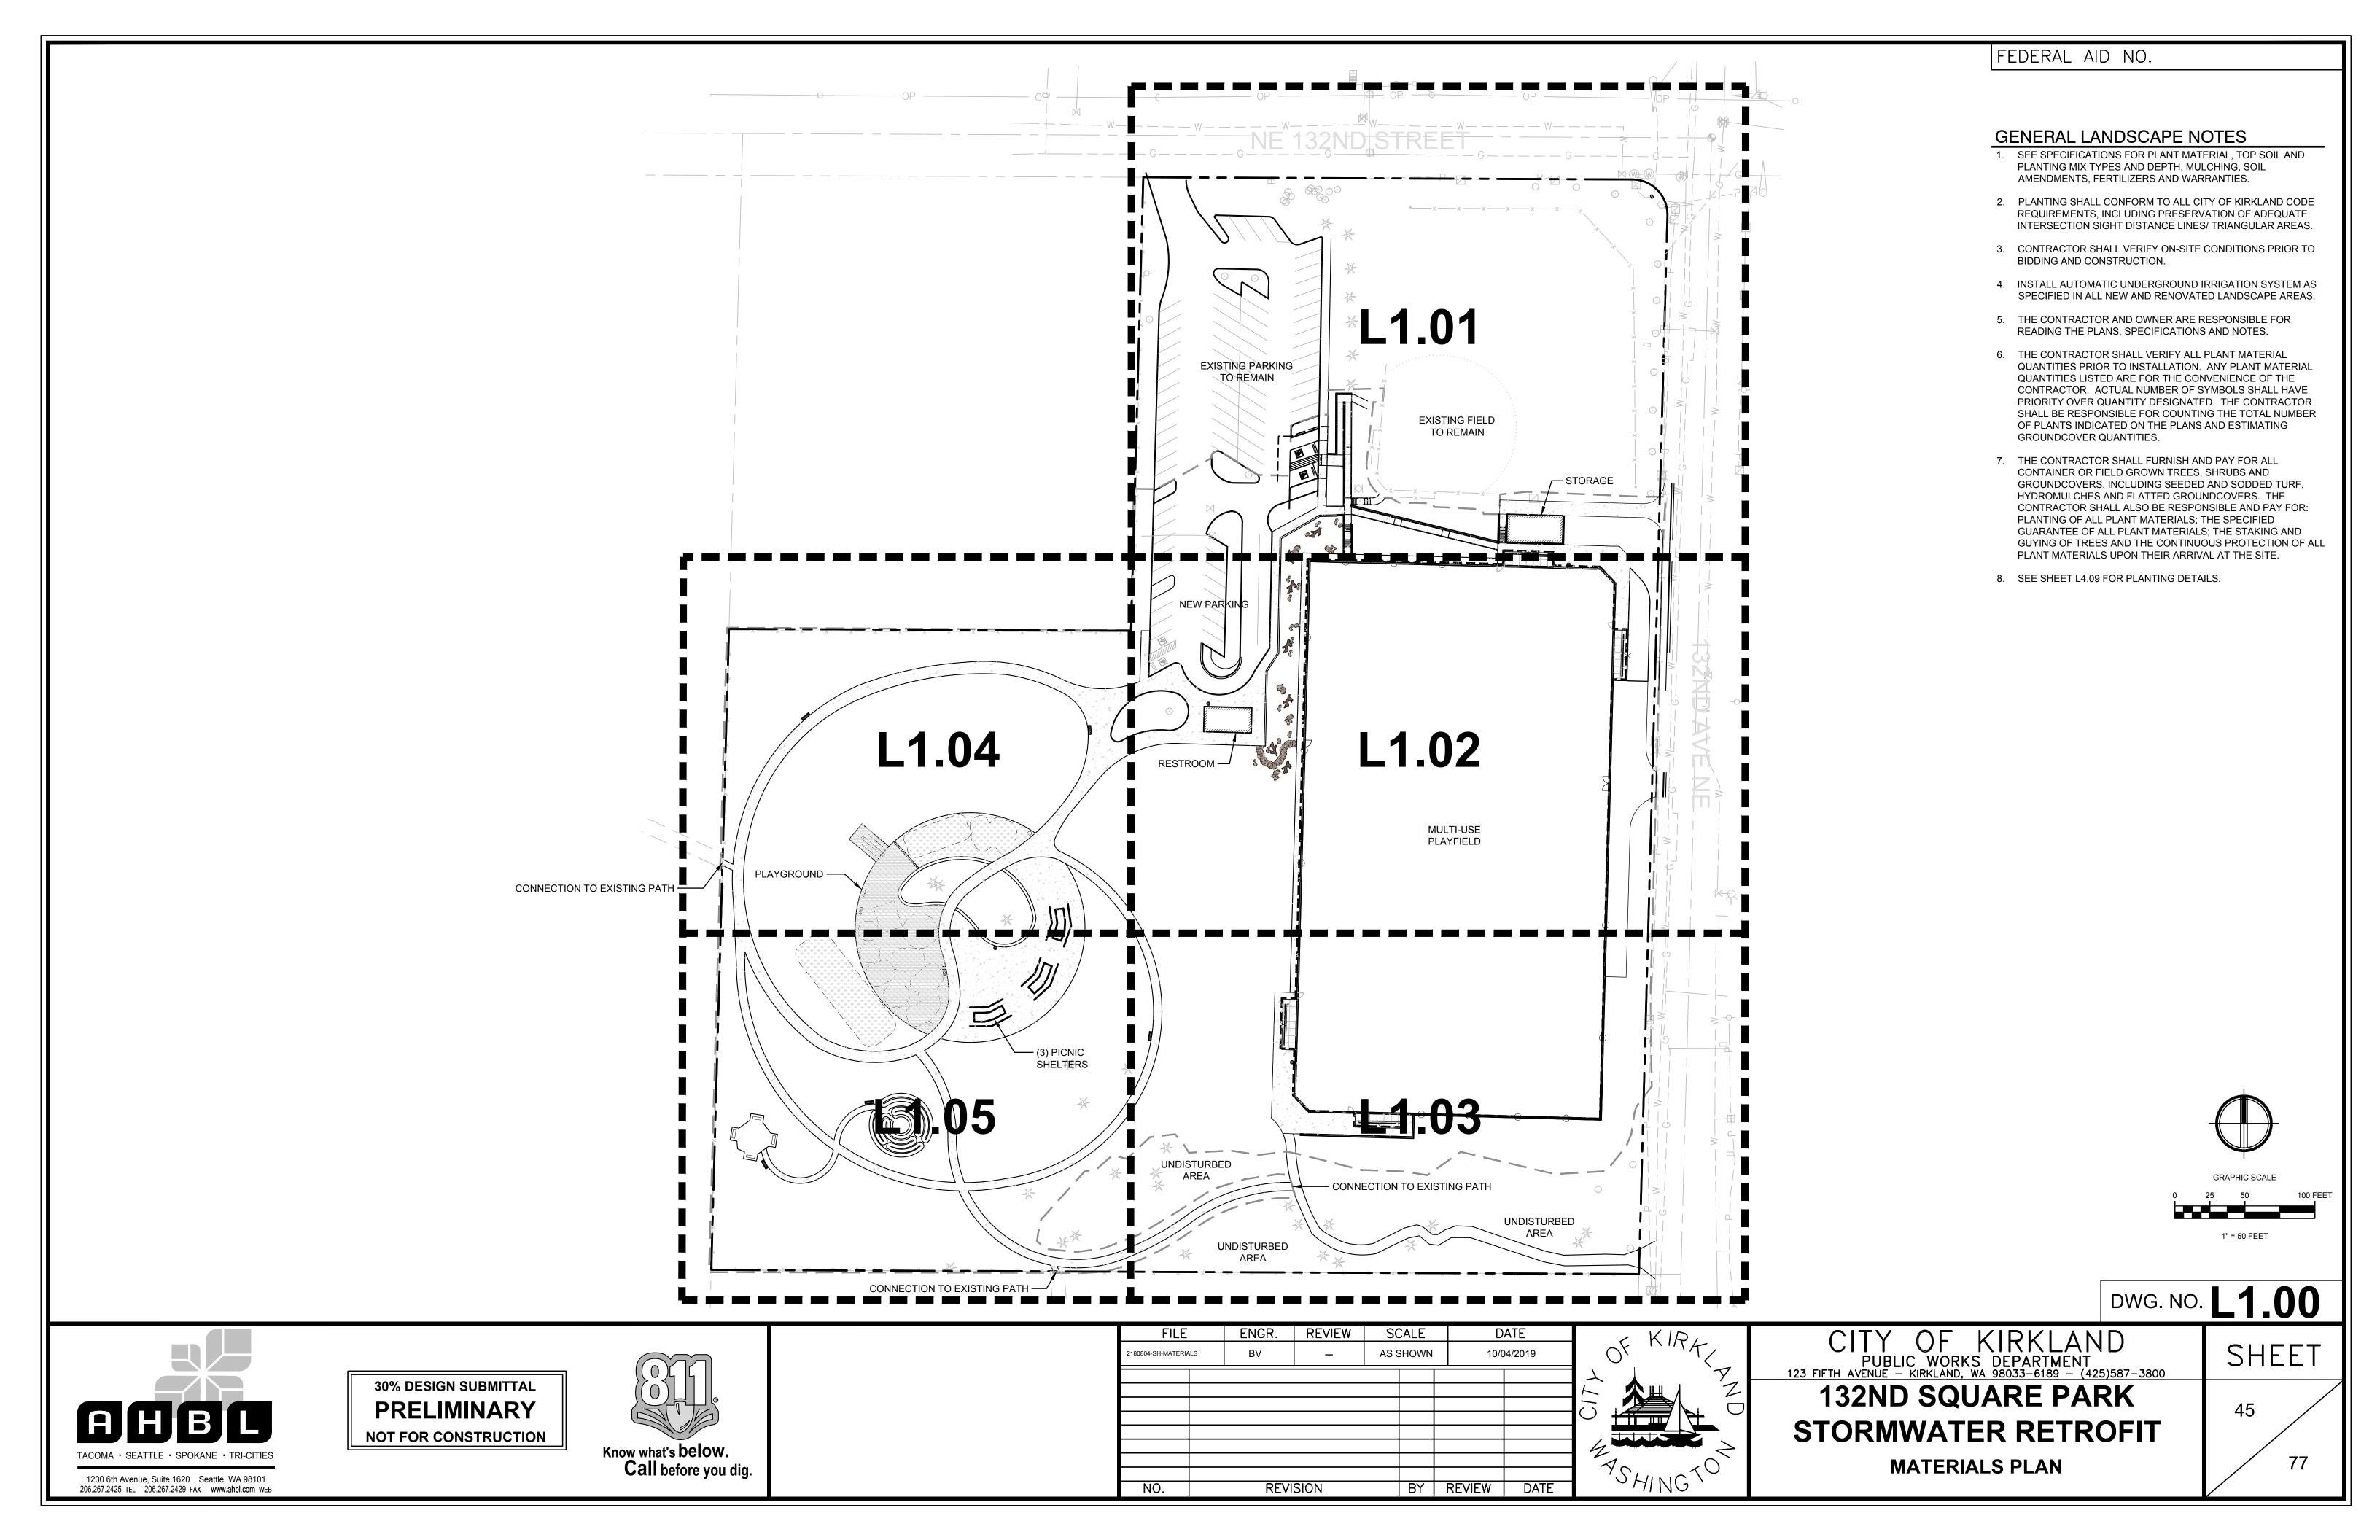


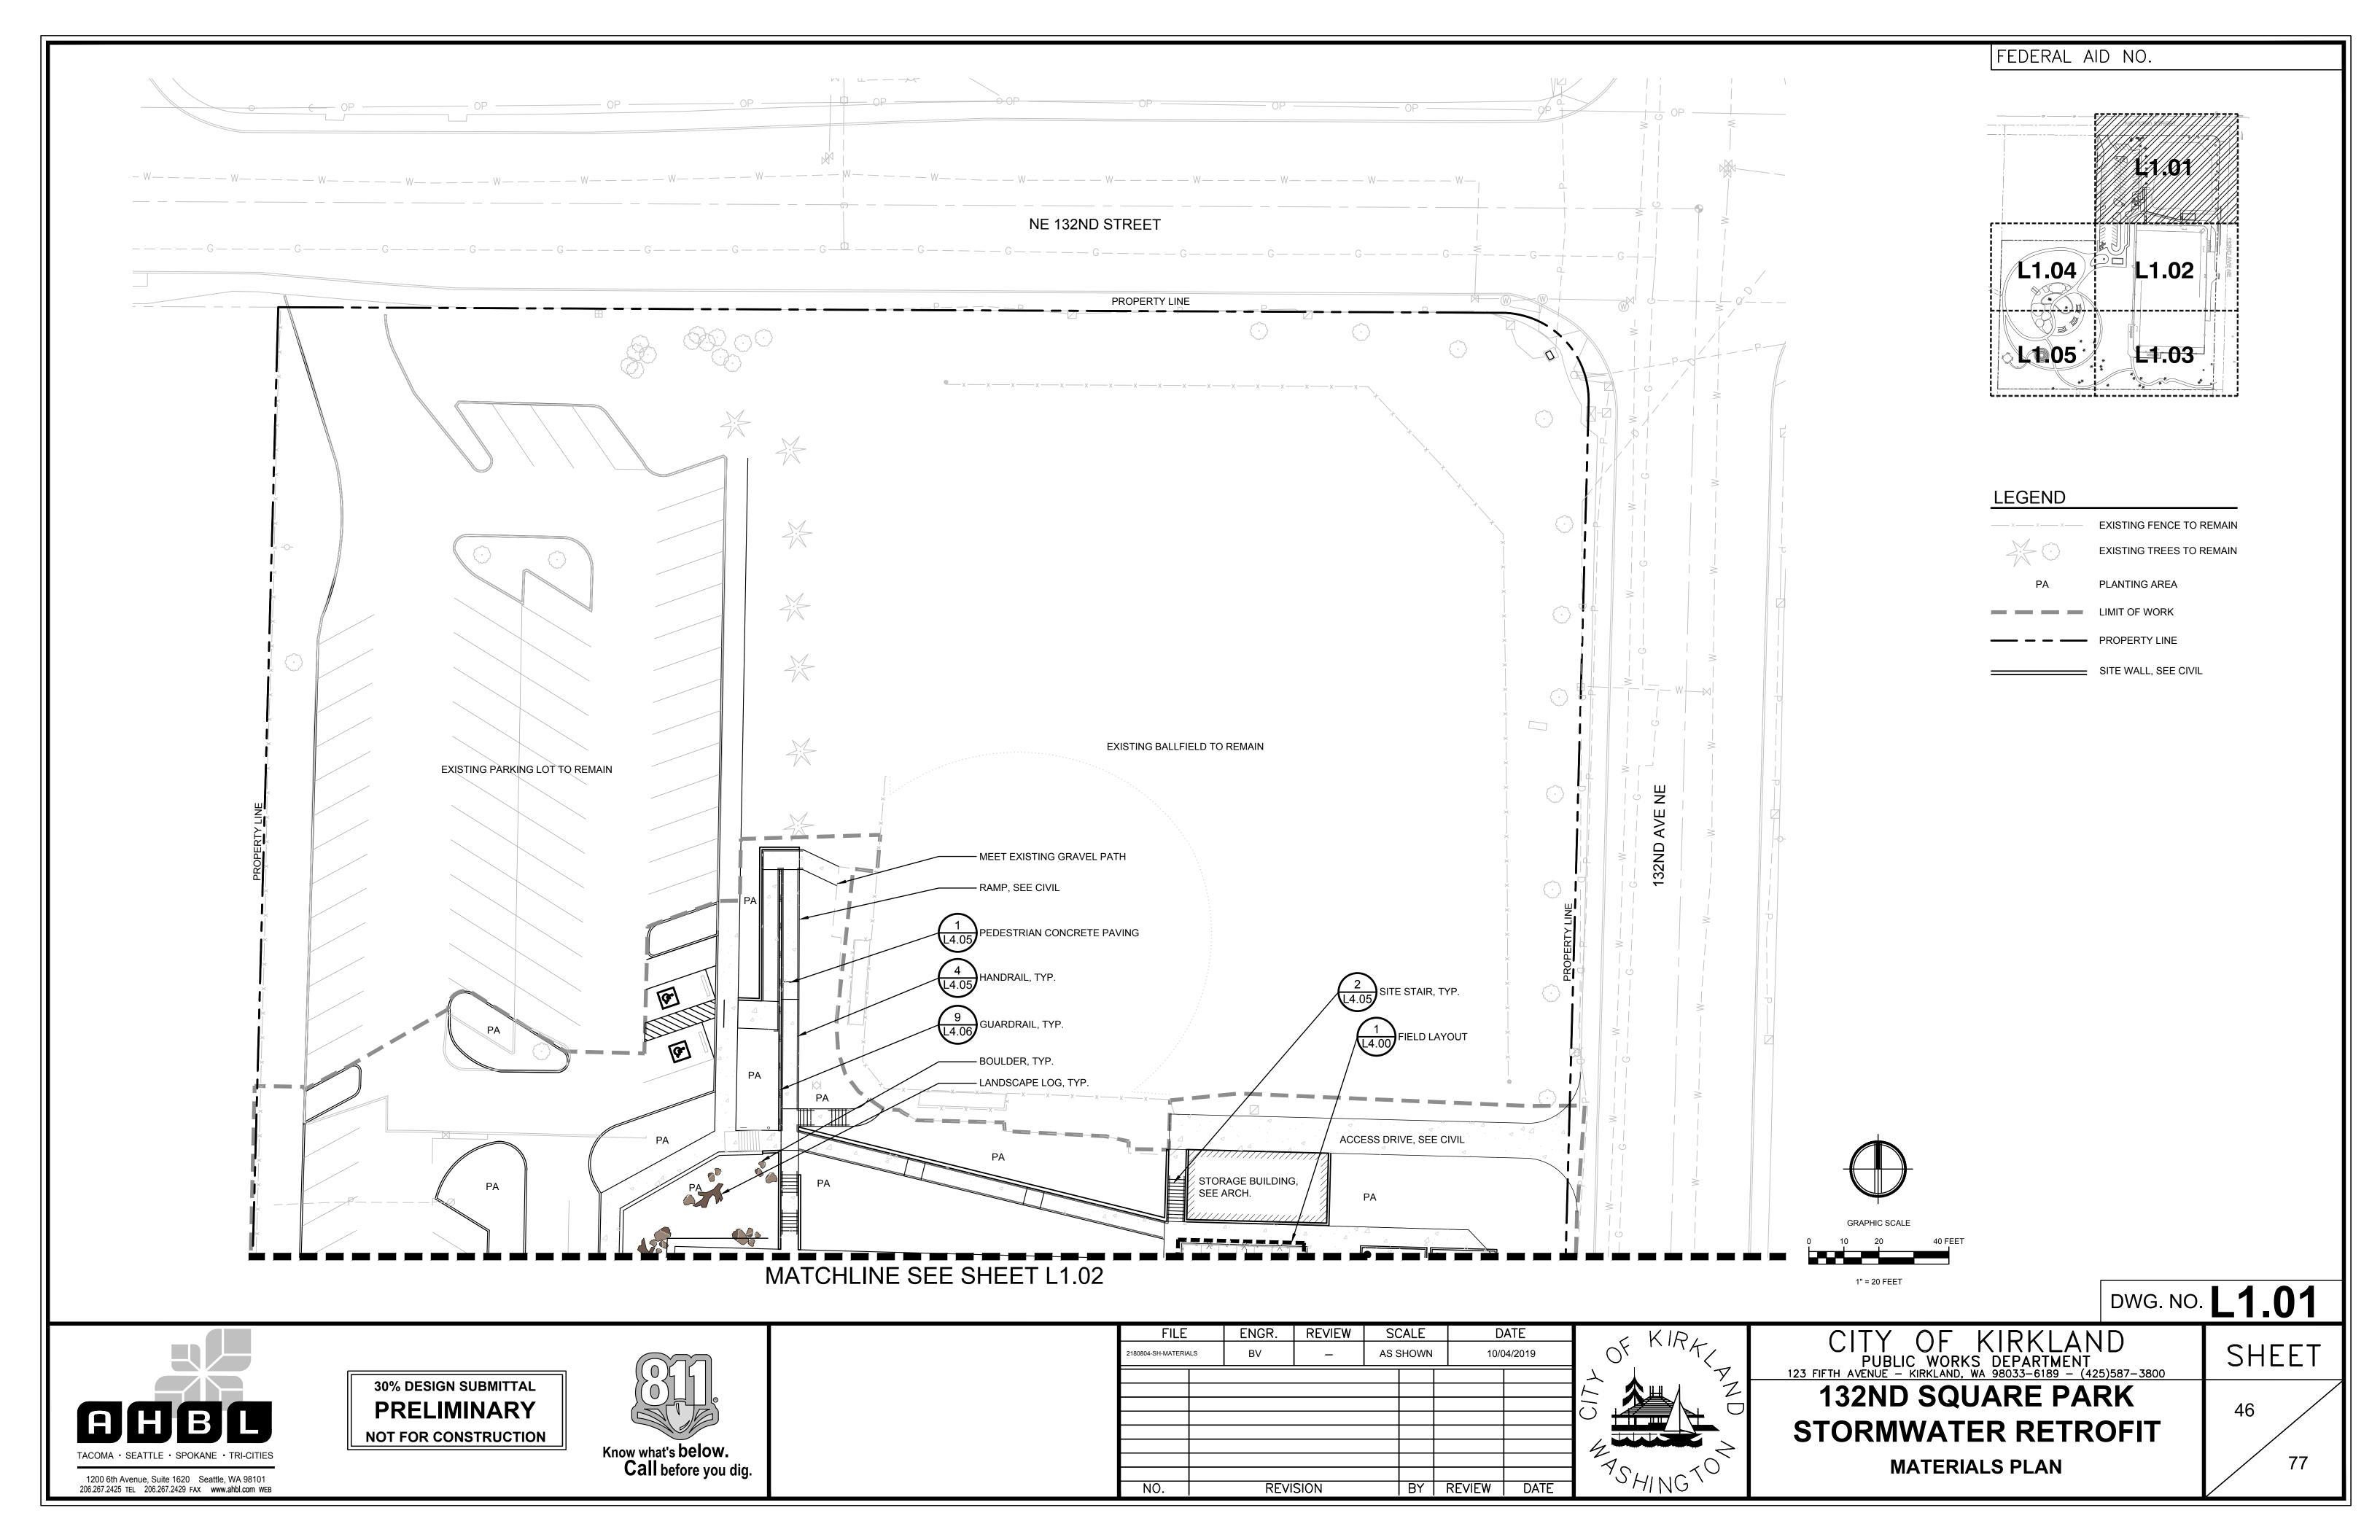
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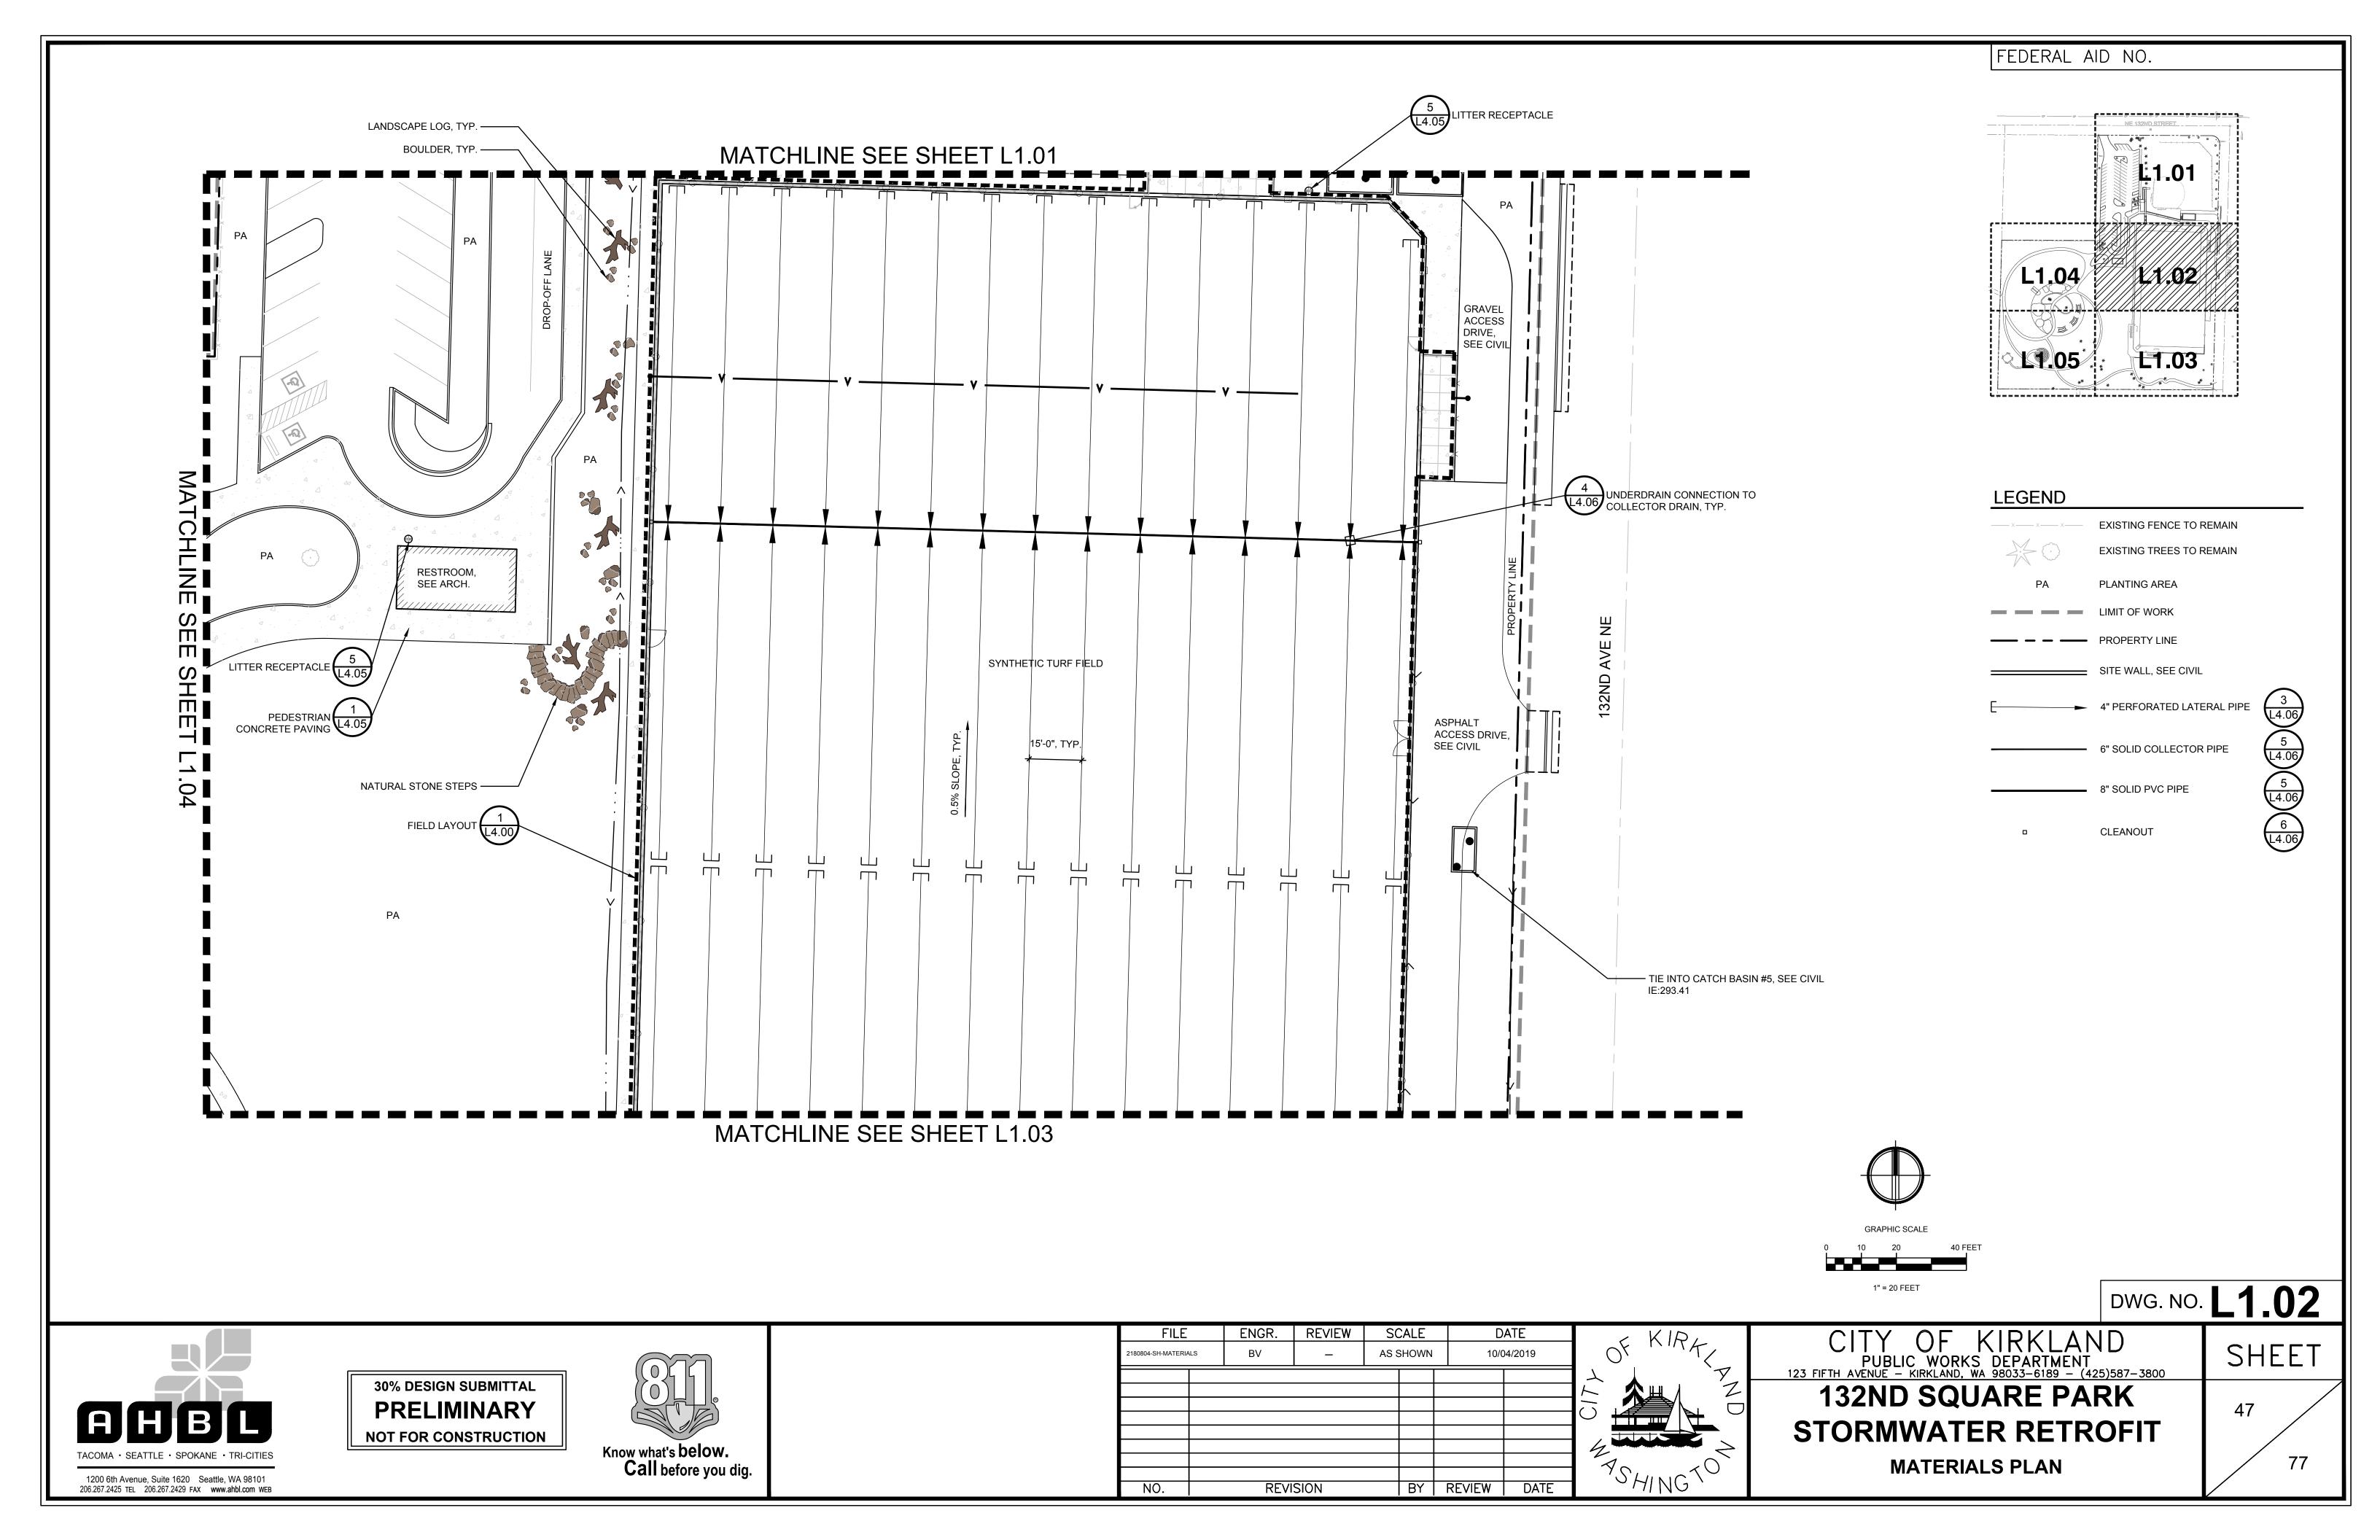
132ND SQUARE PARK
STORMWATER RETROFIT

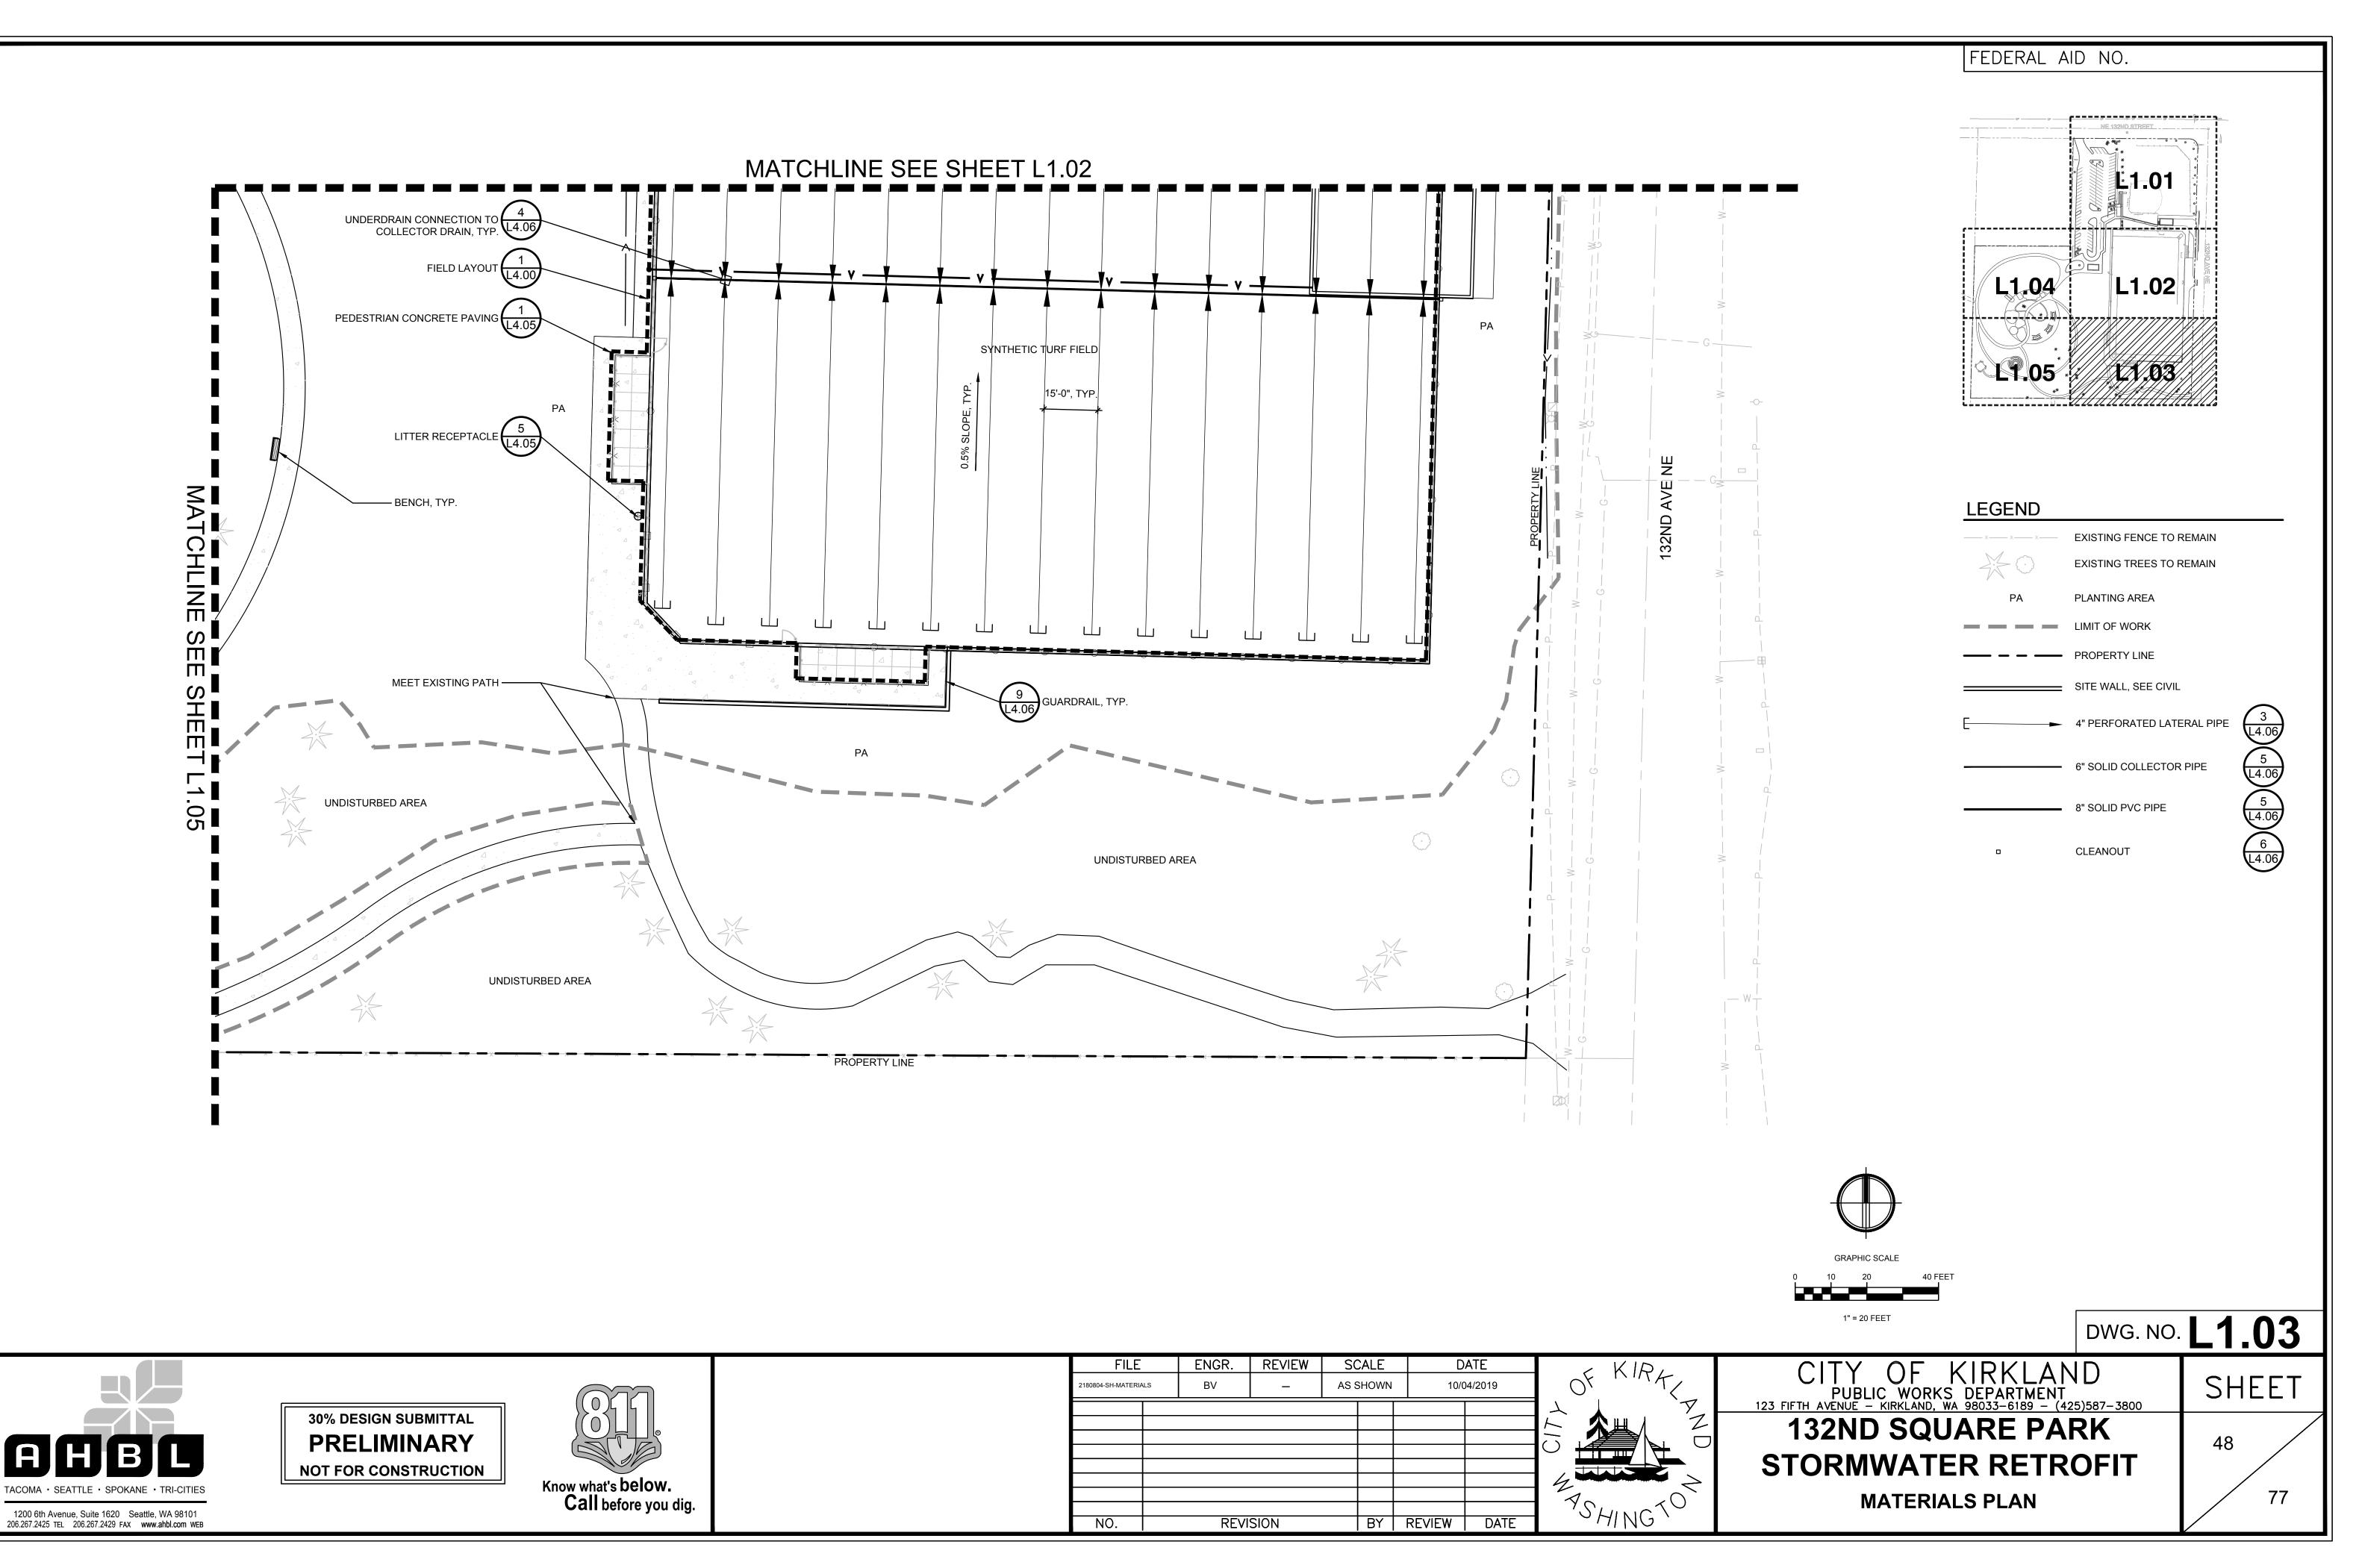
TREE RETENTION PLAN

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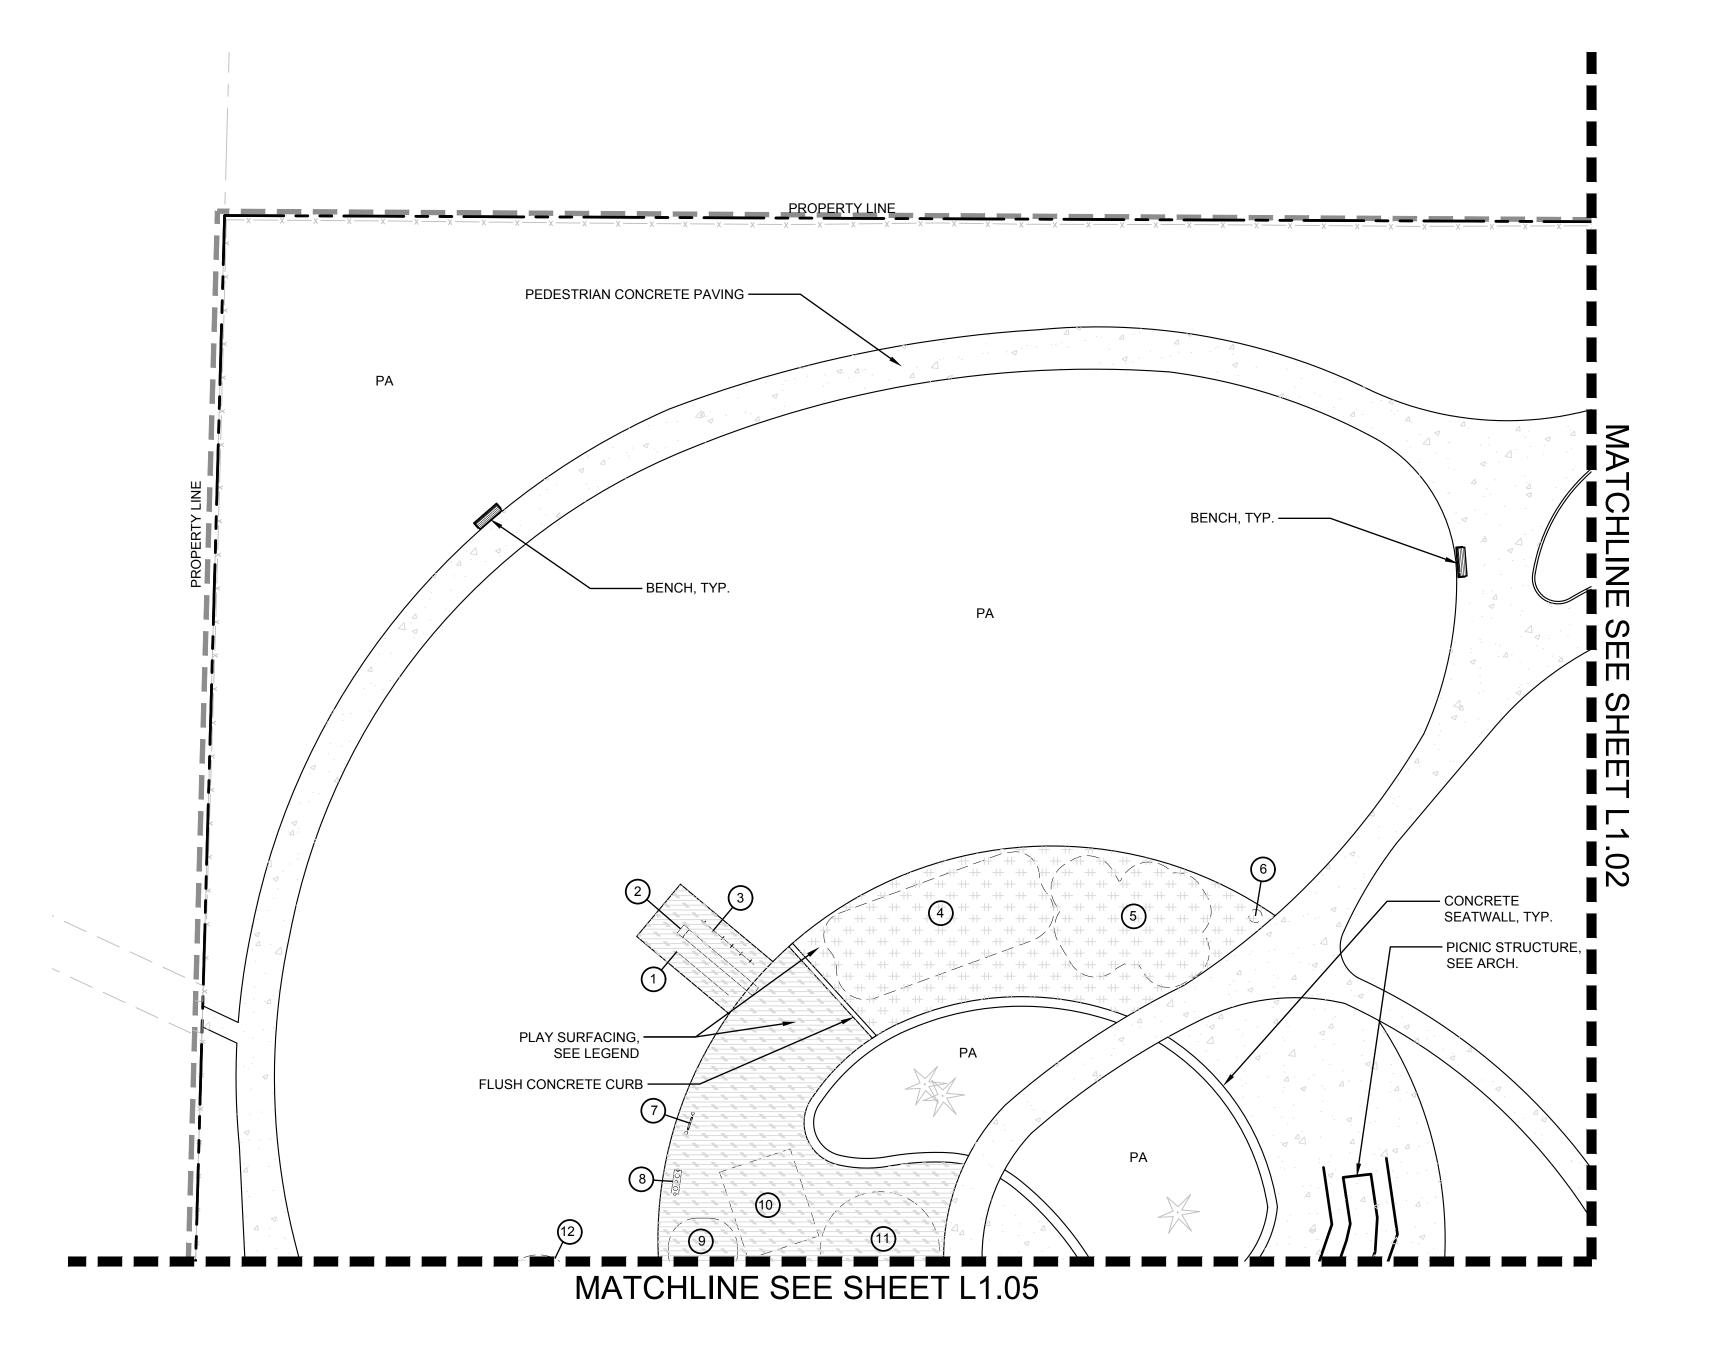


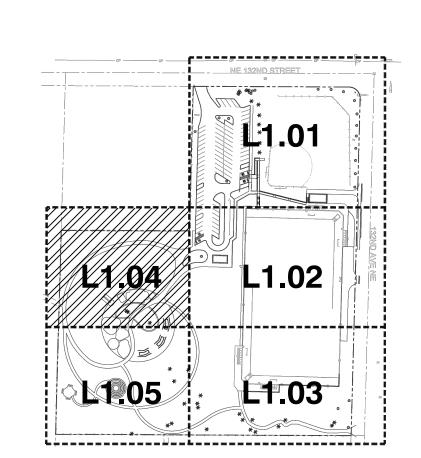




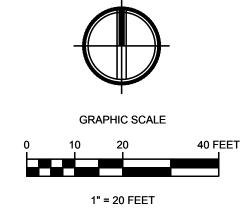


PI	PLAY EQUIPMENT SCHEDULE						
EQUIP.#	MANUFACTURER	DESCRIPTION					
1	KOMPAN	HILL CLIMBER					
2	KOMPAN	METAL EMBANKMENT SLIDE					
3	KOMPAN	HILL CLIMBER WITH EPDM					
4	KOMPAN	ROBINIA SWING SET (2 STANDARD, 2 BABY, 1 SHELL NEST)					
5	KOMPAN	DOUBLE TOWER DOUBLE SLIDE					
6	KOMPAN	GAS PUMP					
7	KOMPAN	XLYOPHONE PANEL					
8	KOMPAN	PERCUSSION PANEL					
9	KOMPAN	FOREST BUG SPRINGER					
10	KOMPAN	WATER LILY BALANCE					
11	KOMPAN	WHEELCHAIR CAROUSEL					
12	KOMPAN	ZIPLINE					
13	KOMPAN	SNAIL SPRING RIDER					
14	KOMPAN	STILTS					
15	ID SCULPTURE	HOME TREE					
16	KOMPAN	UP AND OVER					
17	KOMPAN	PARKOUR 4					
18	KOMPAN	GAS PUMP					





LEGEND EXISTING FENCE TO REMAIN EXISTING TREES TO REMAIN PLANTING AREA LIMIT OF WORK PROPERTY LINE _____ SITE WALL, SEE CIVIL ENGINEERED WOOD FIBER SYNTHETIC PLAY TURF



DWG. NO. **L1.04**

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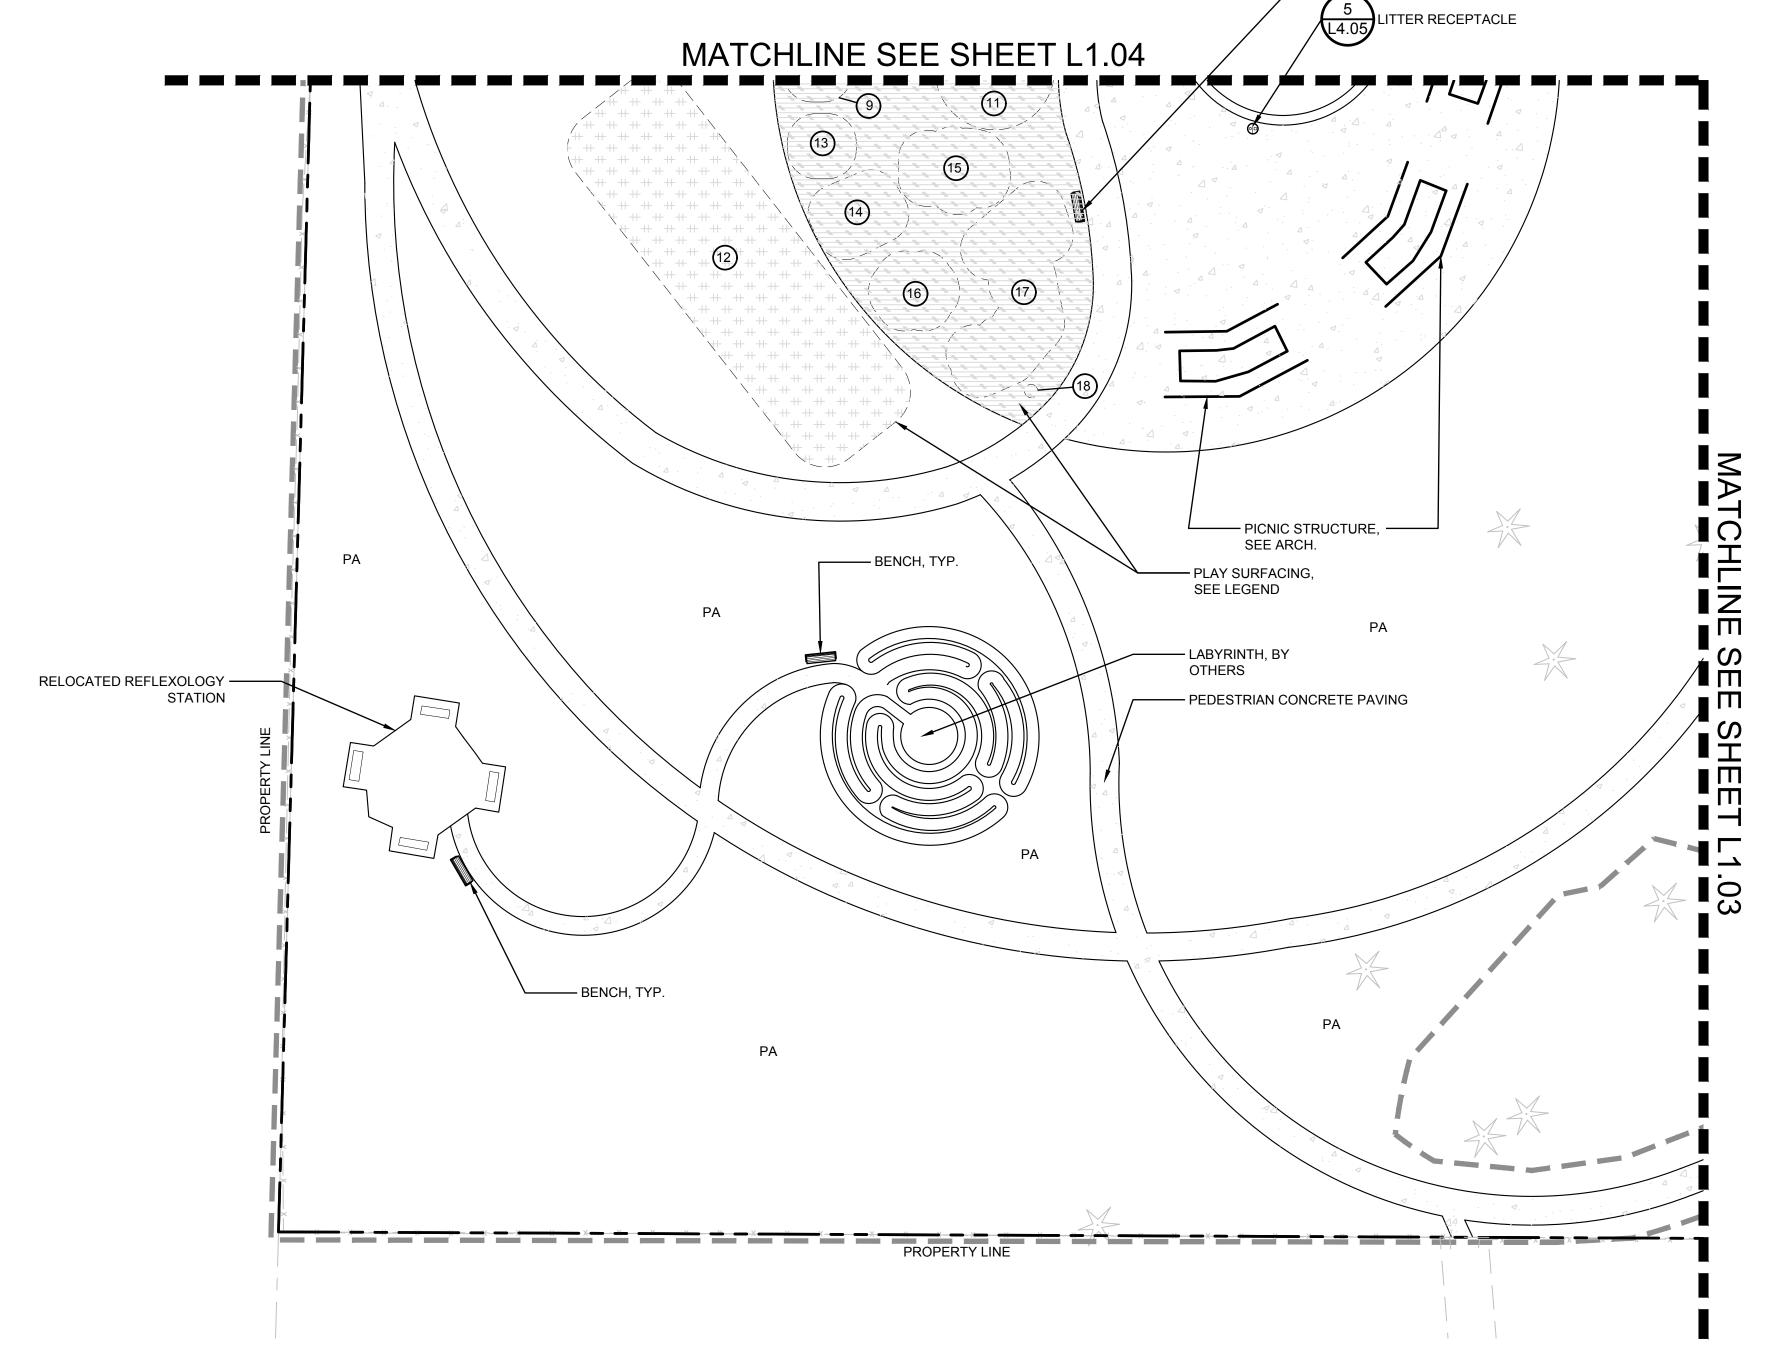
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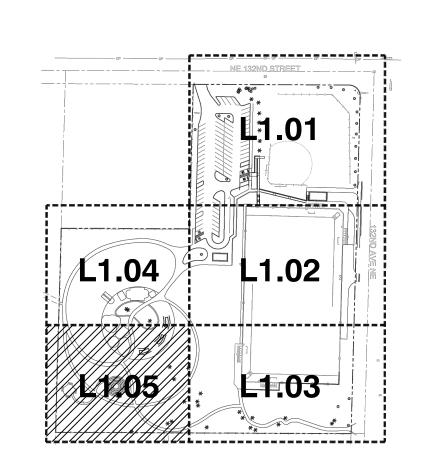


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132ND SQUARE PARK STORMWATER RETROFIT **MATERIALS PLAN**







EXISTING FENCE TO REMAIN

EXISTING TREES TO REMAIN

PA PLANTING AREA

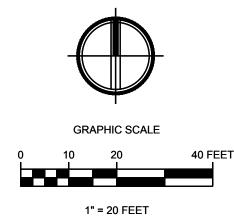
LIMIT OF WORK

PROPERTY LINE

SITE WALL, SEE CIVIL

ENGINEERED WOOD FIBER

SYNTHETIC PLAY TURF



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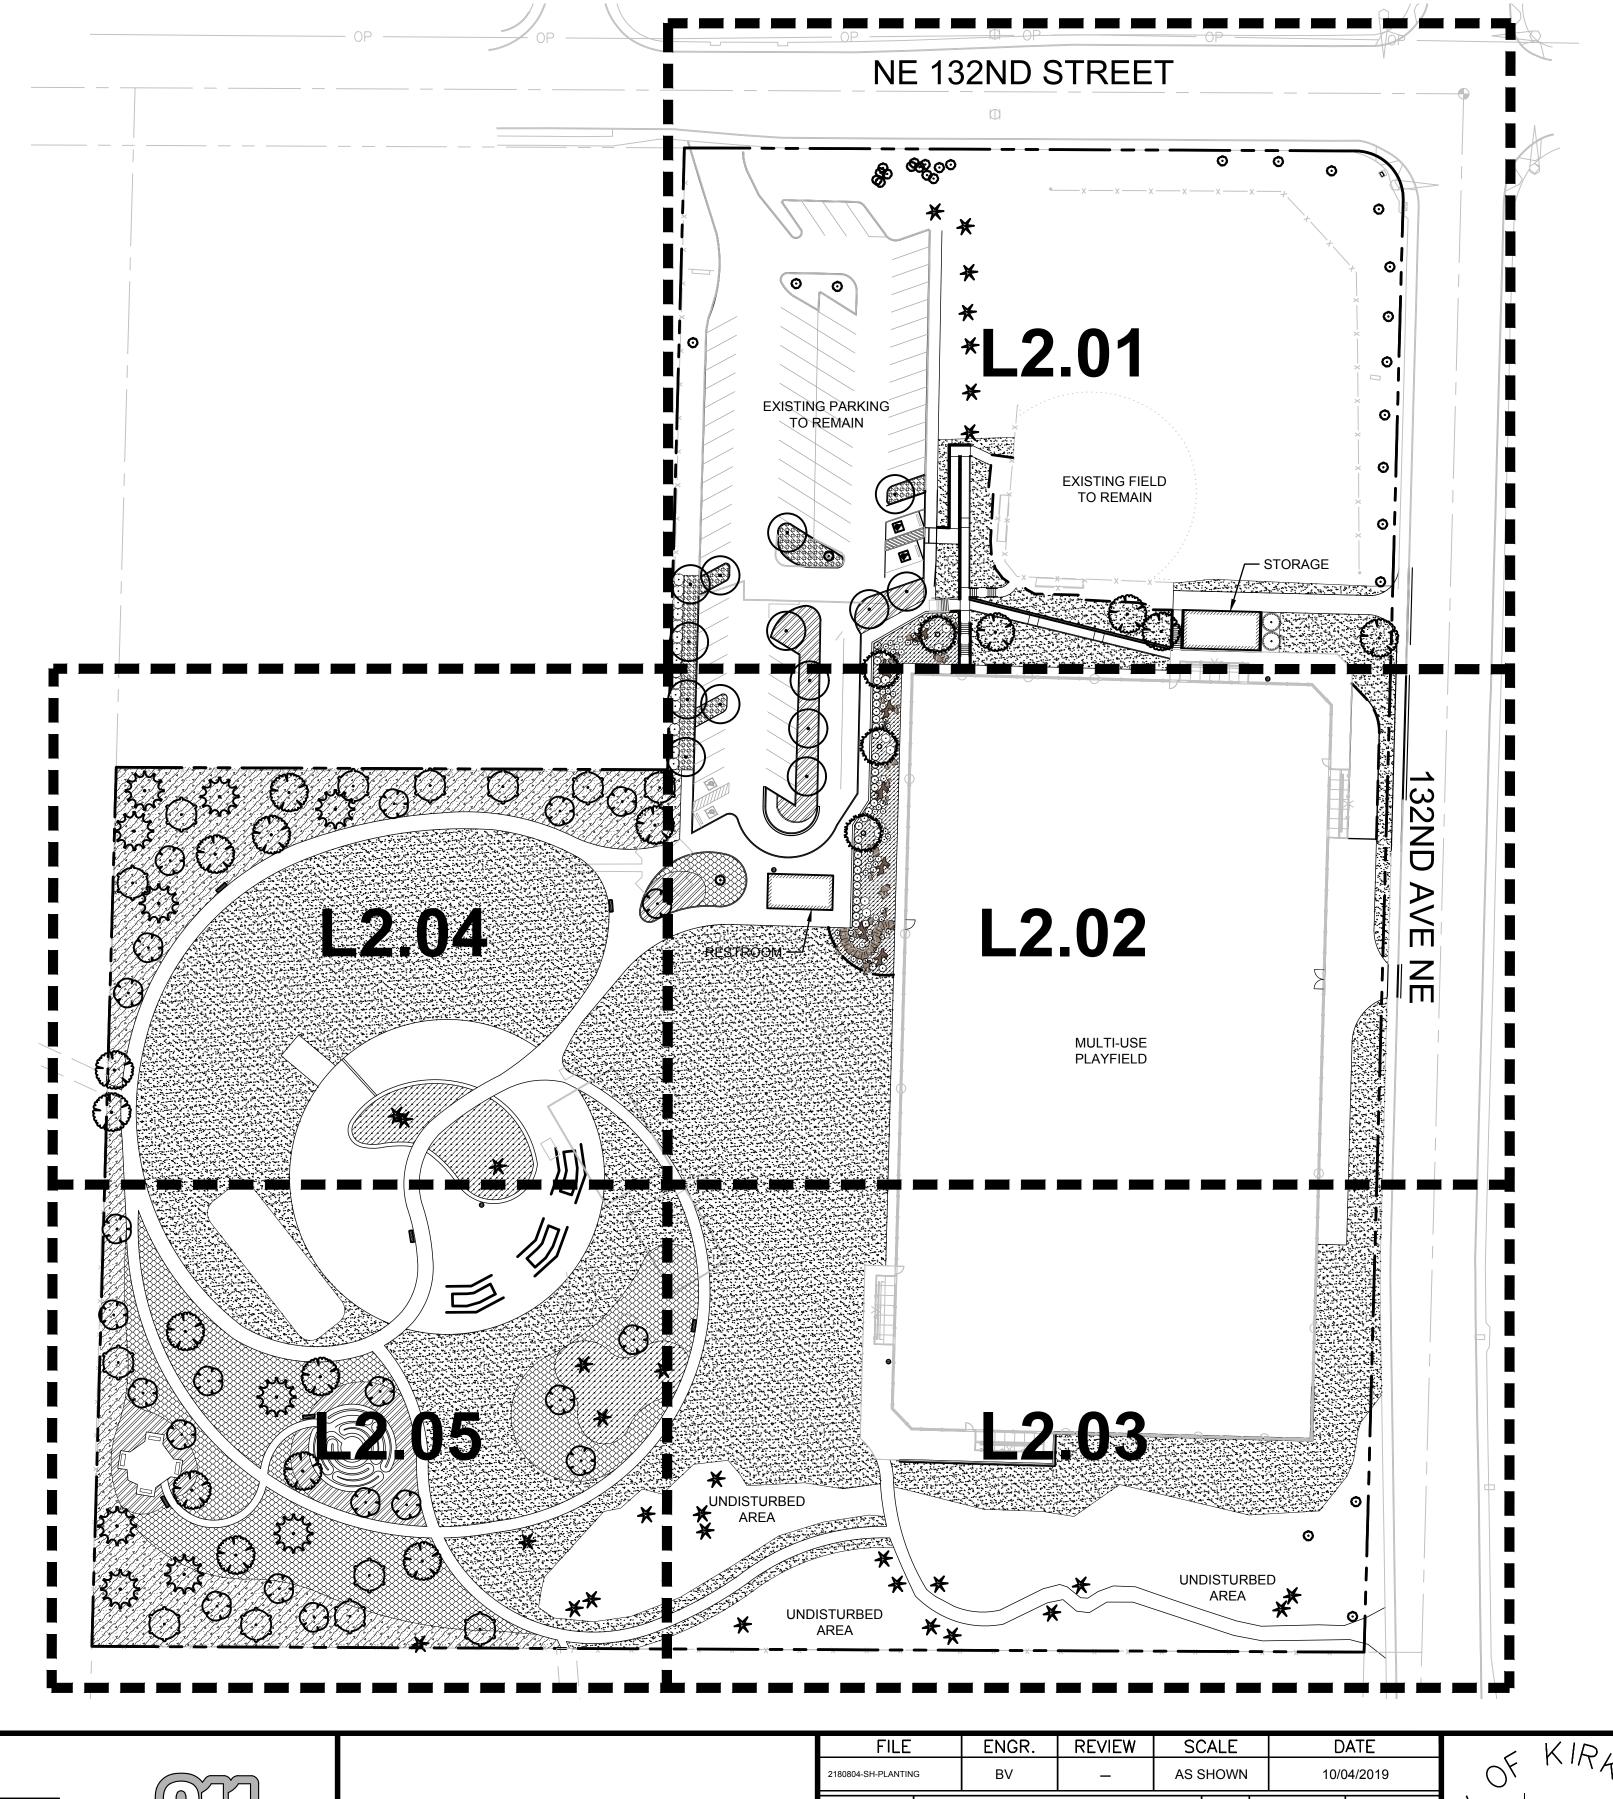
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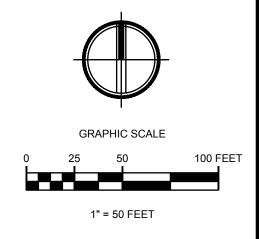
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132ND SQUARE PARK
STORMWATER RETROFIT

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MATERIALS PLAN





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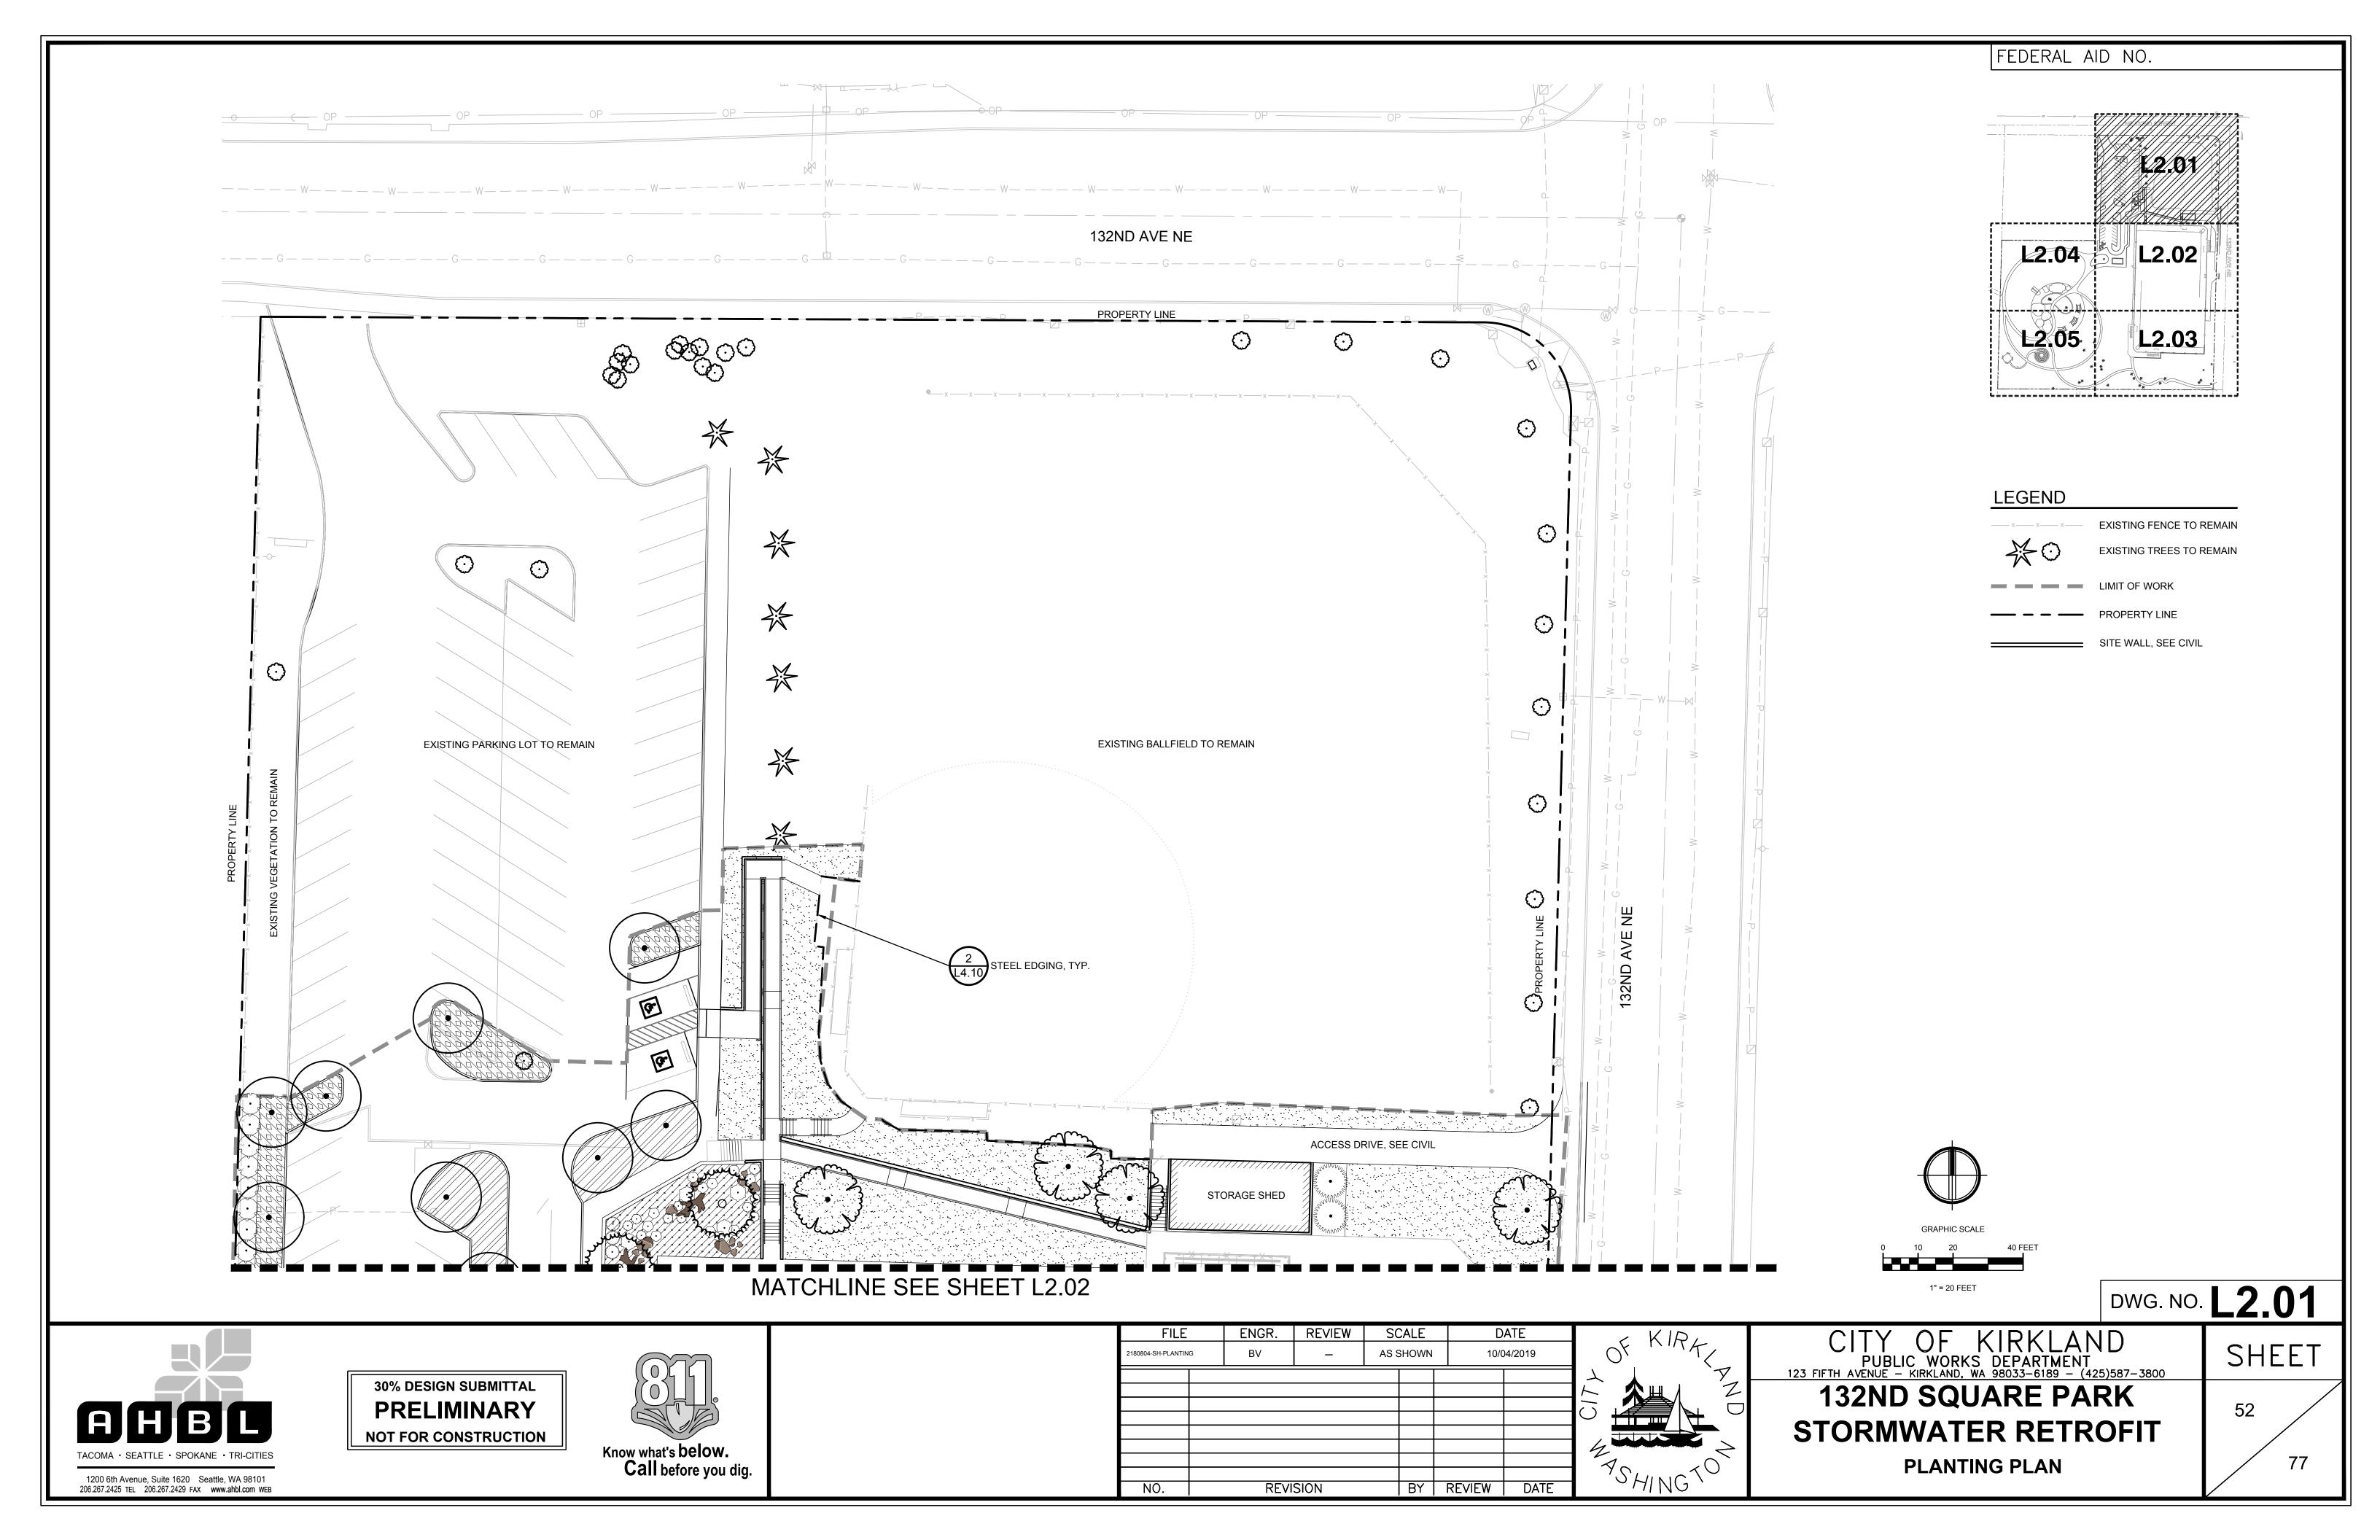
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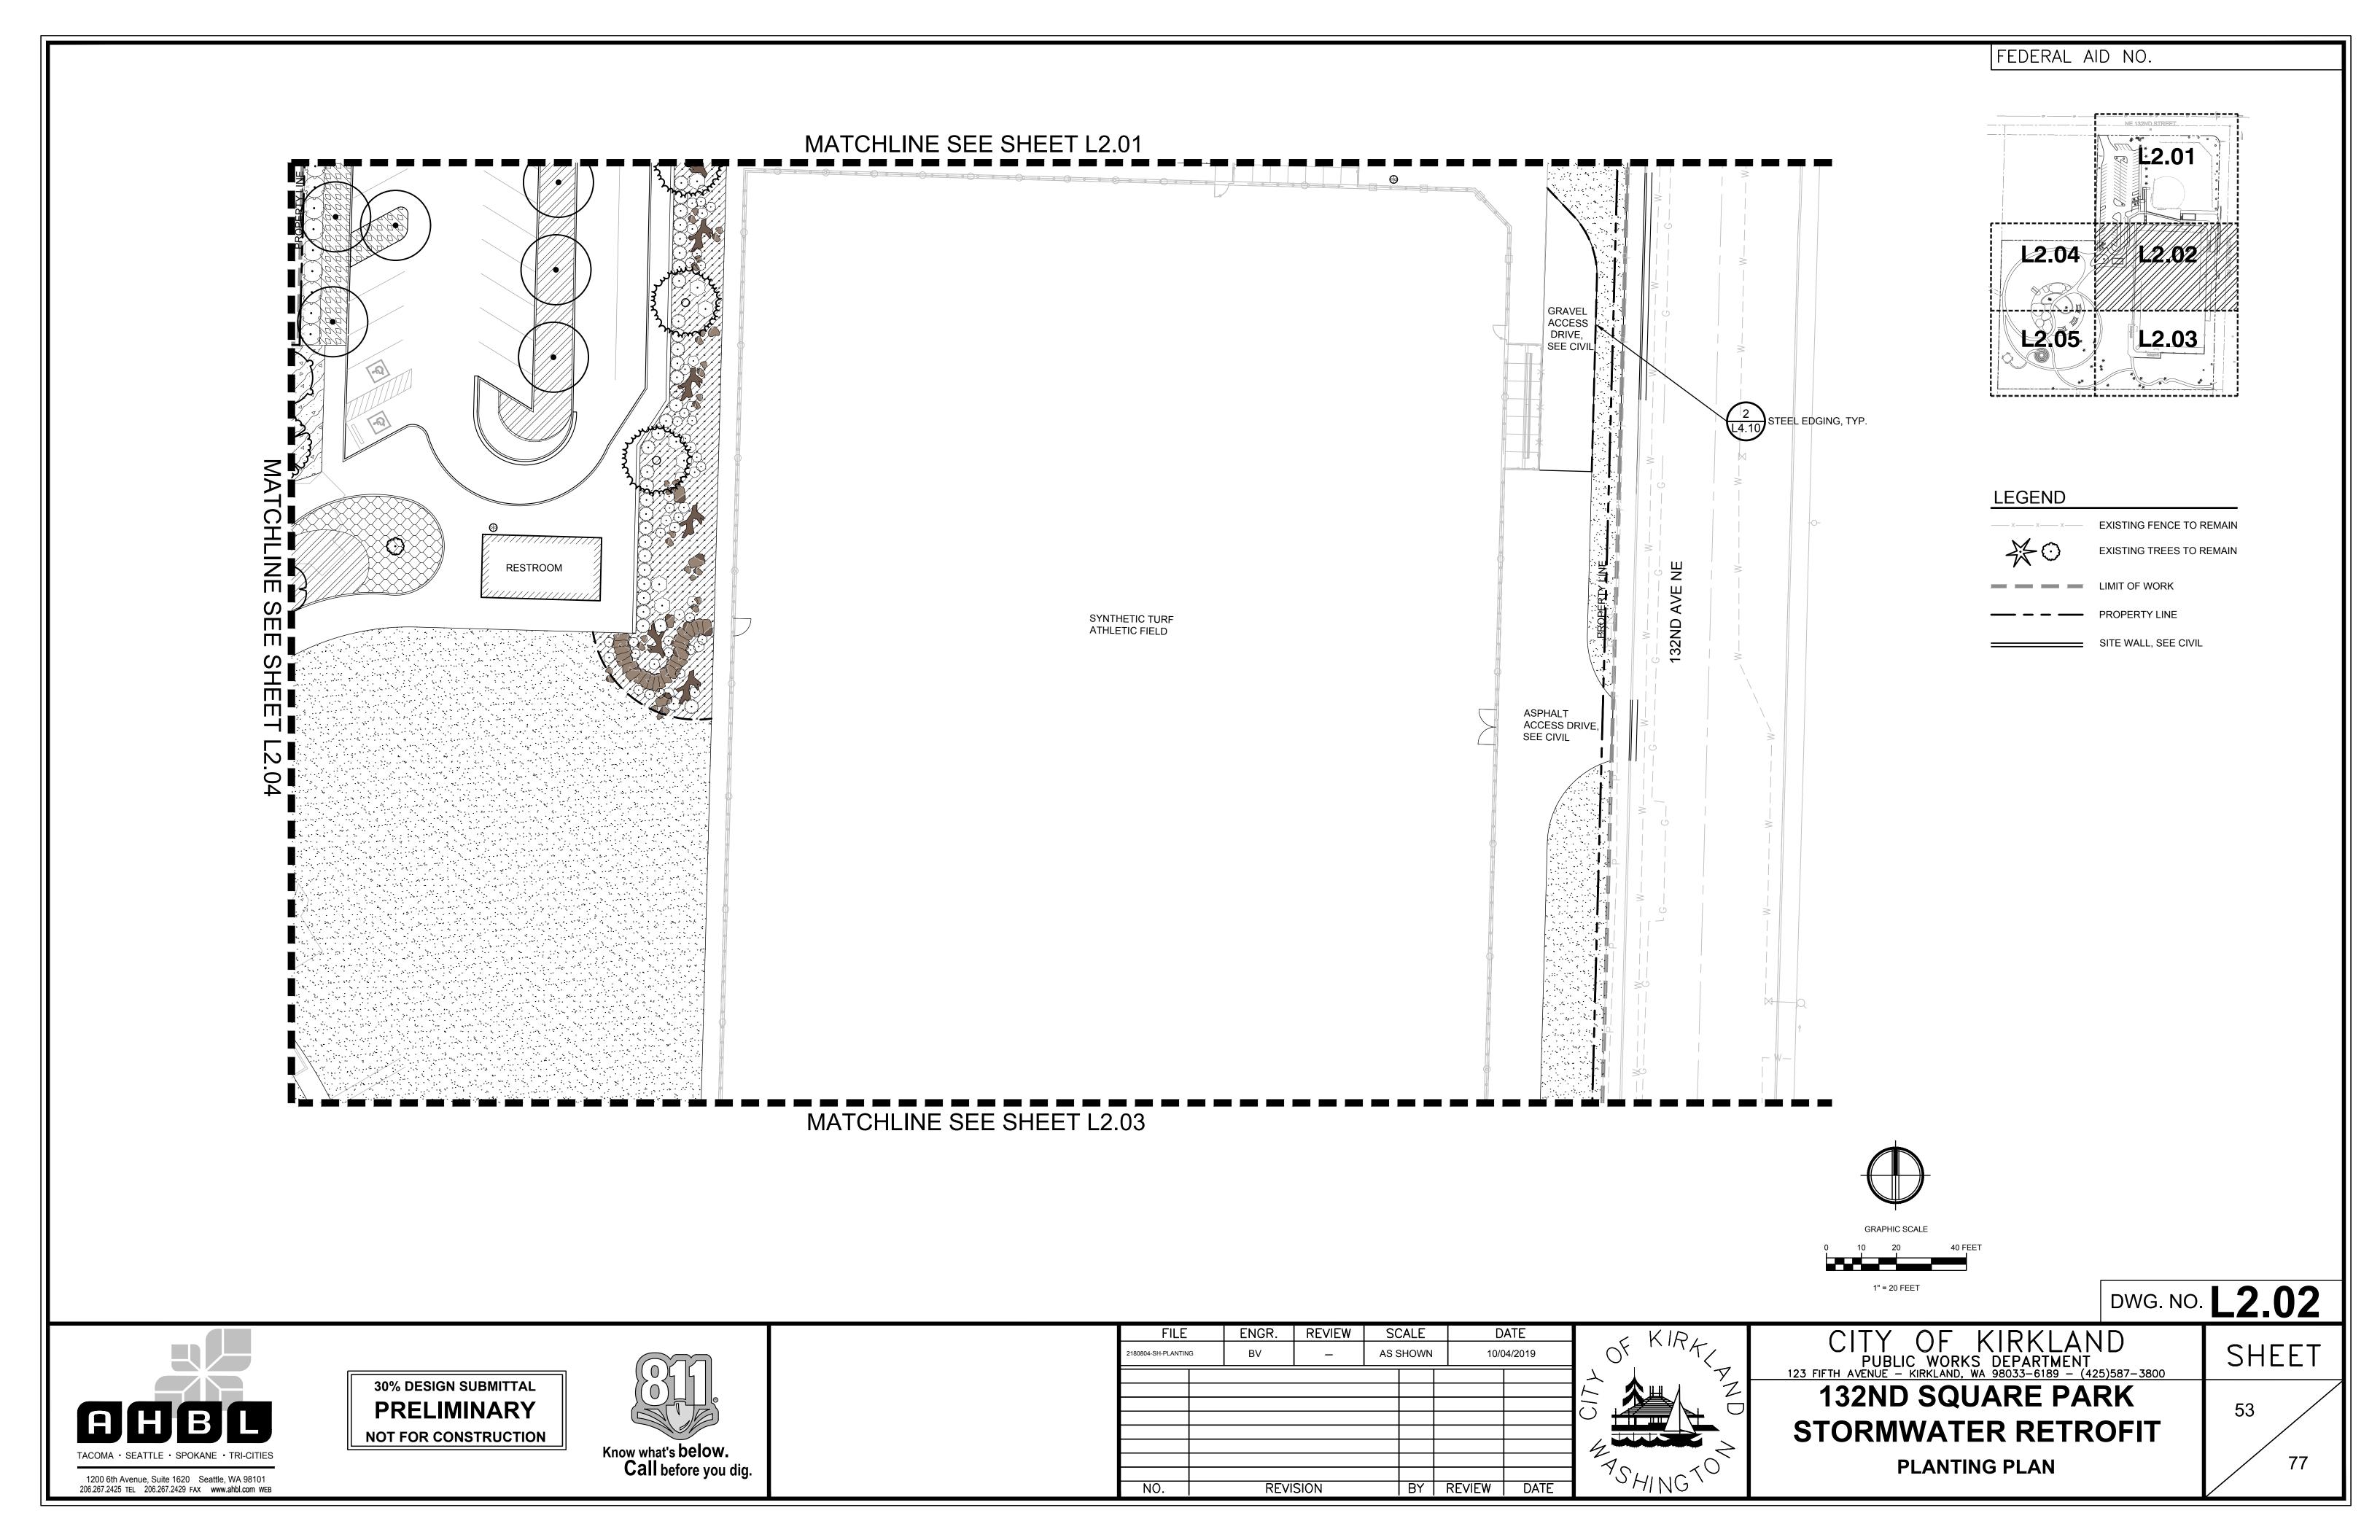


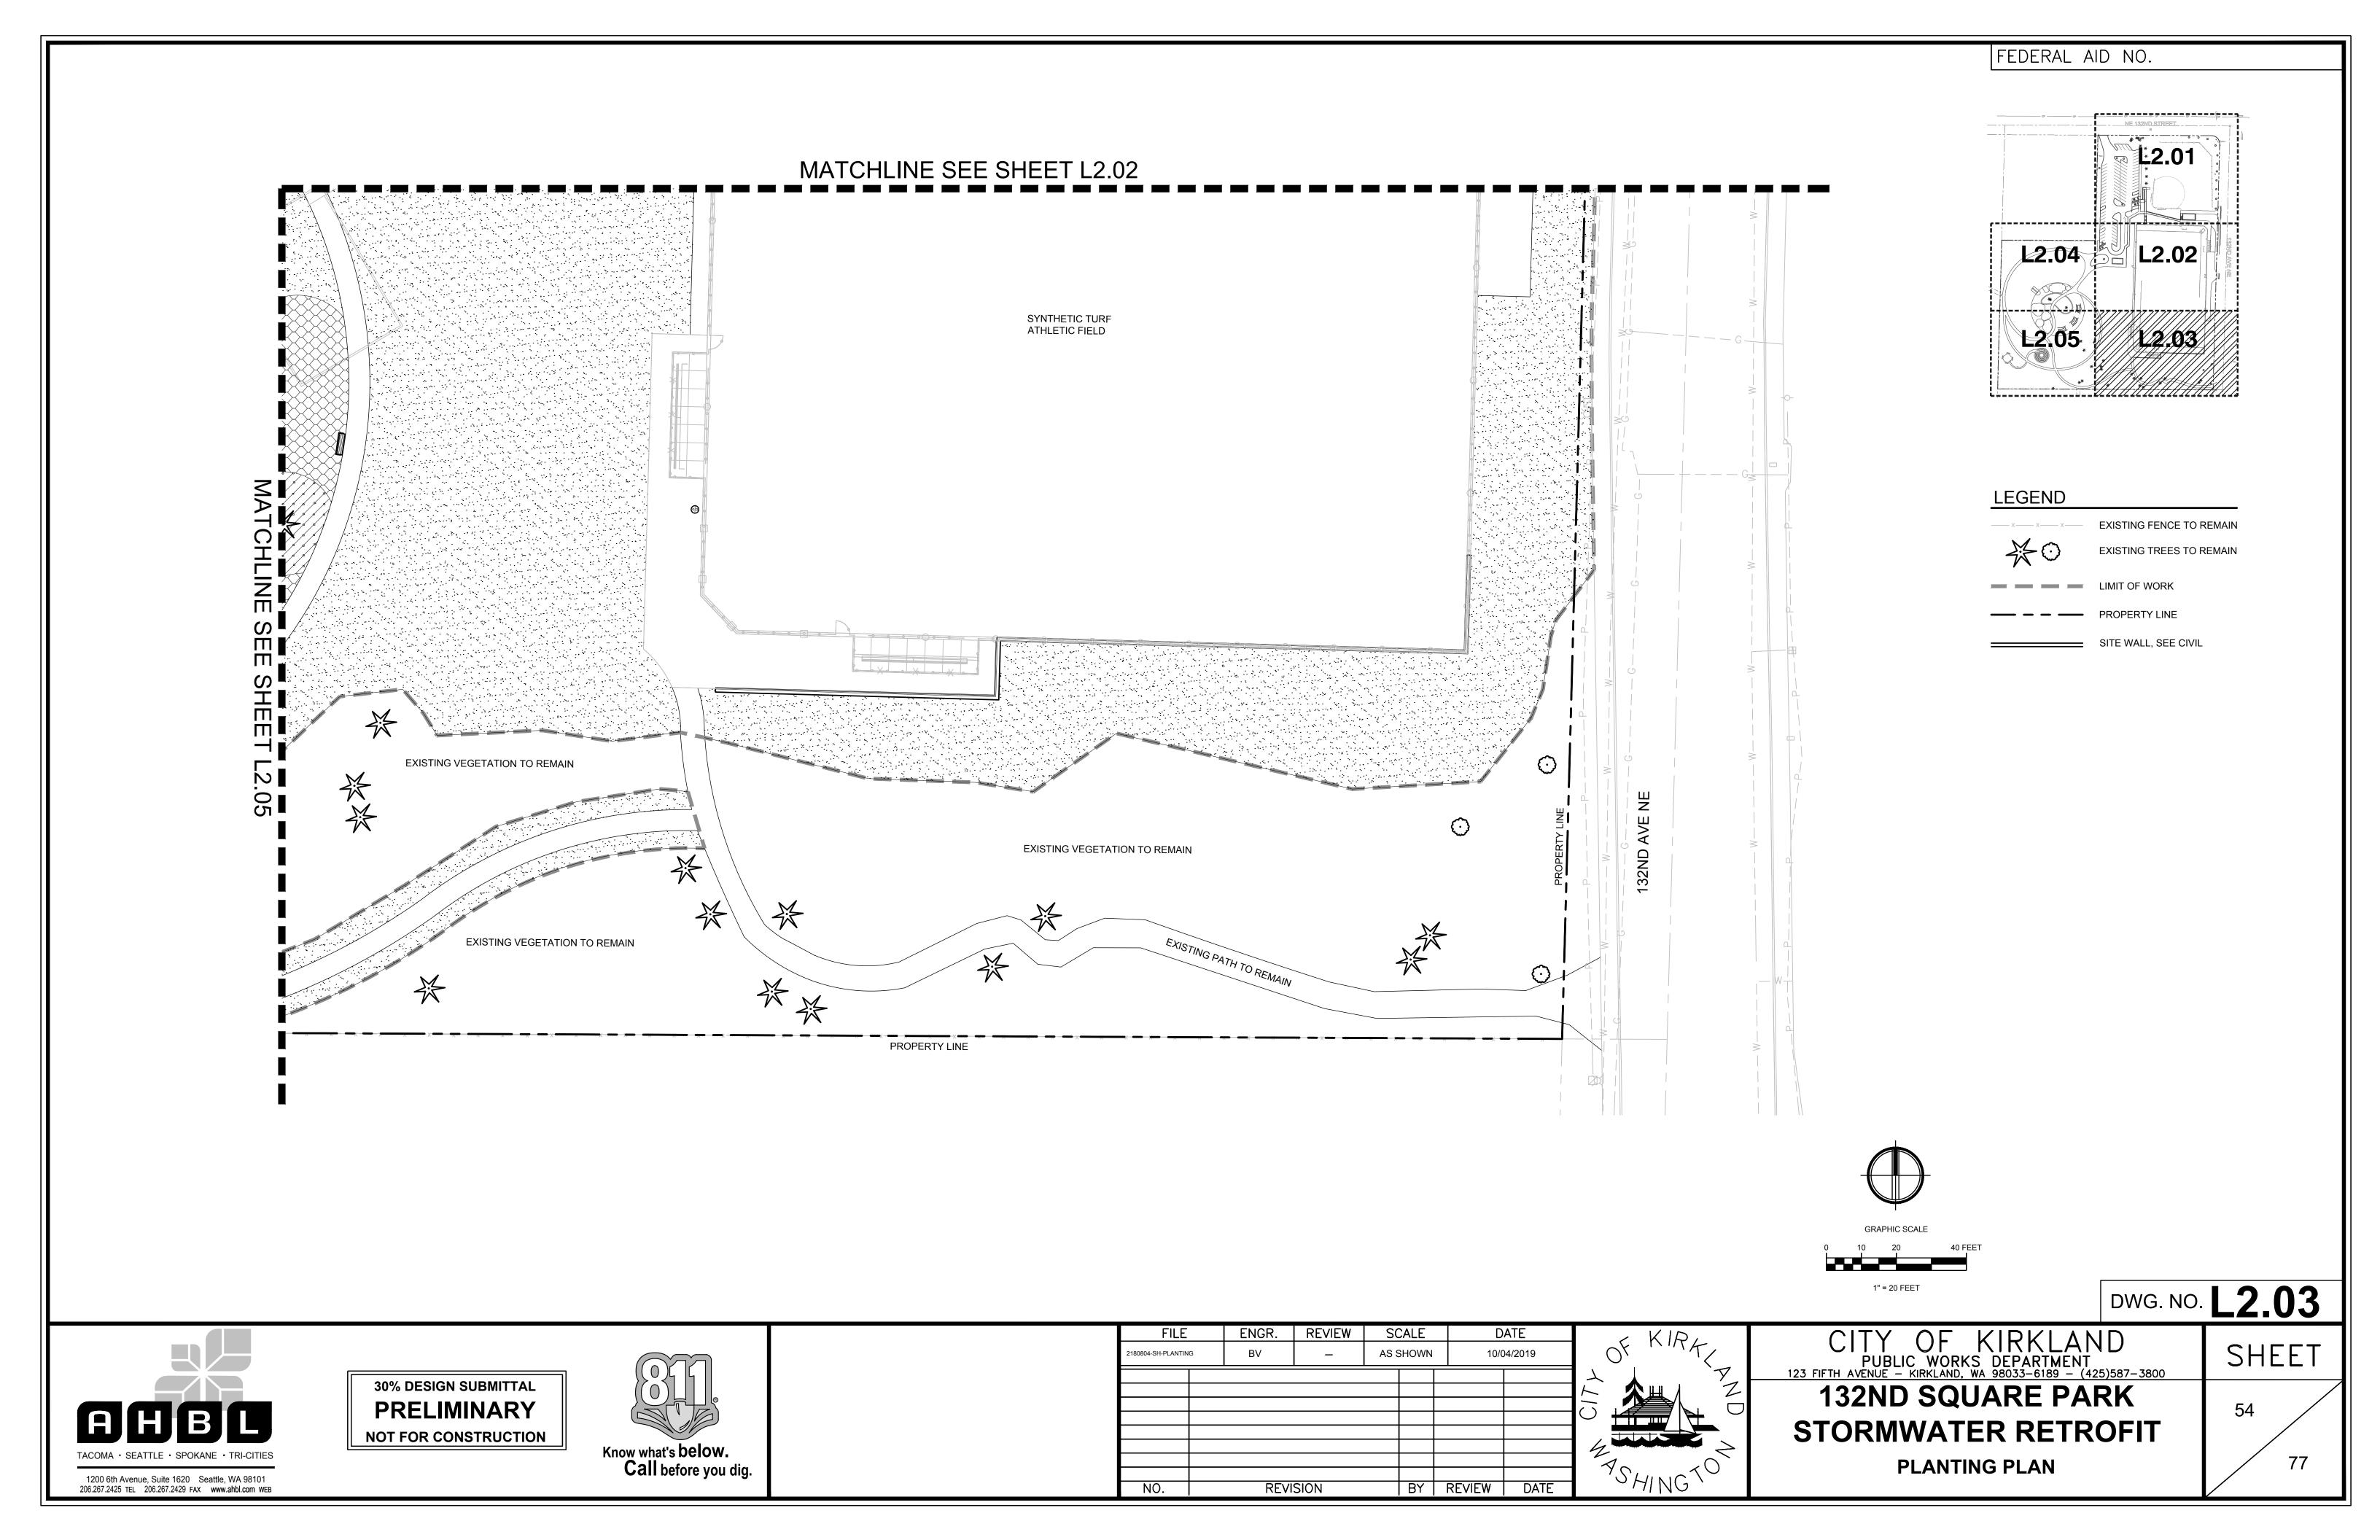
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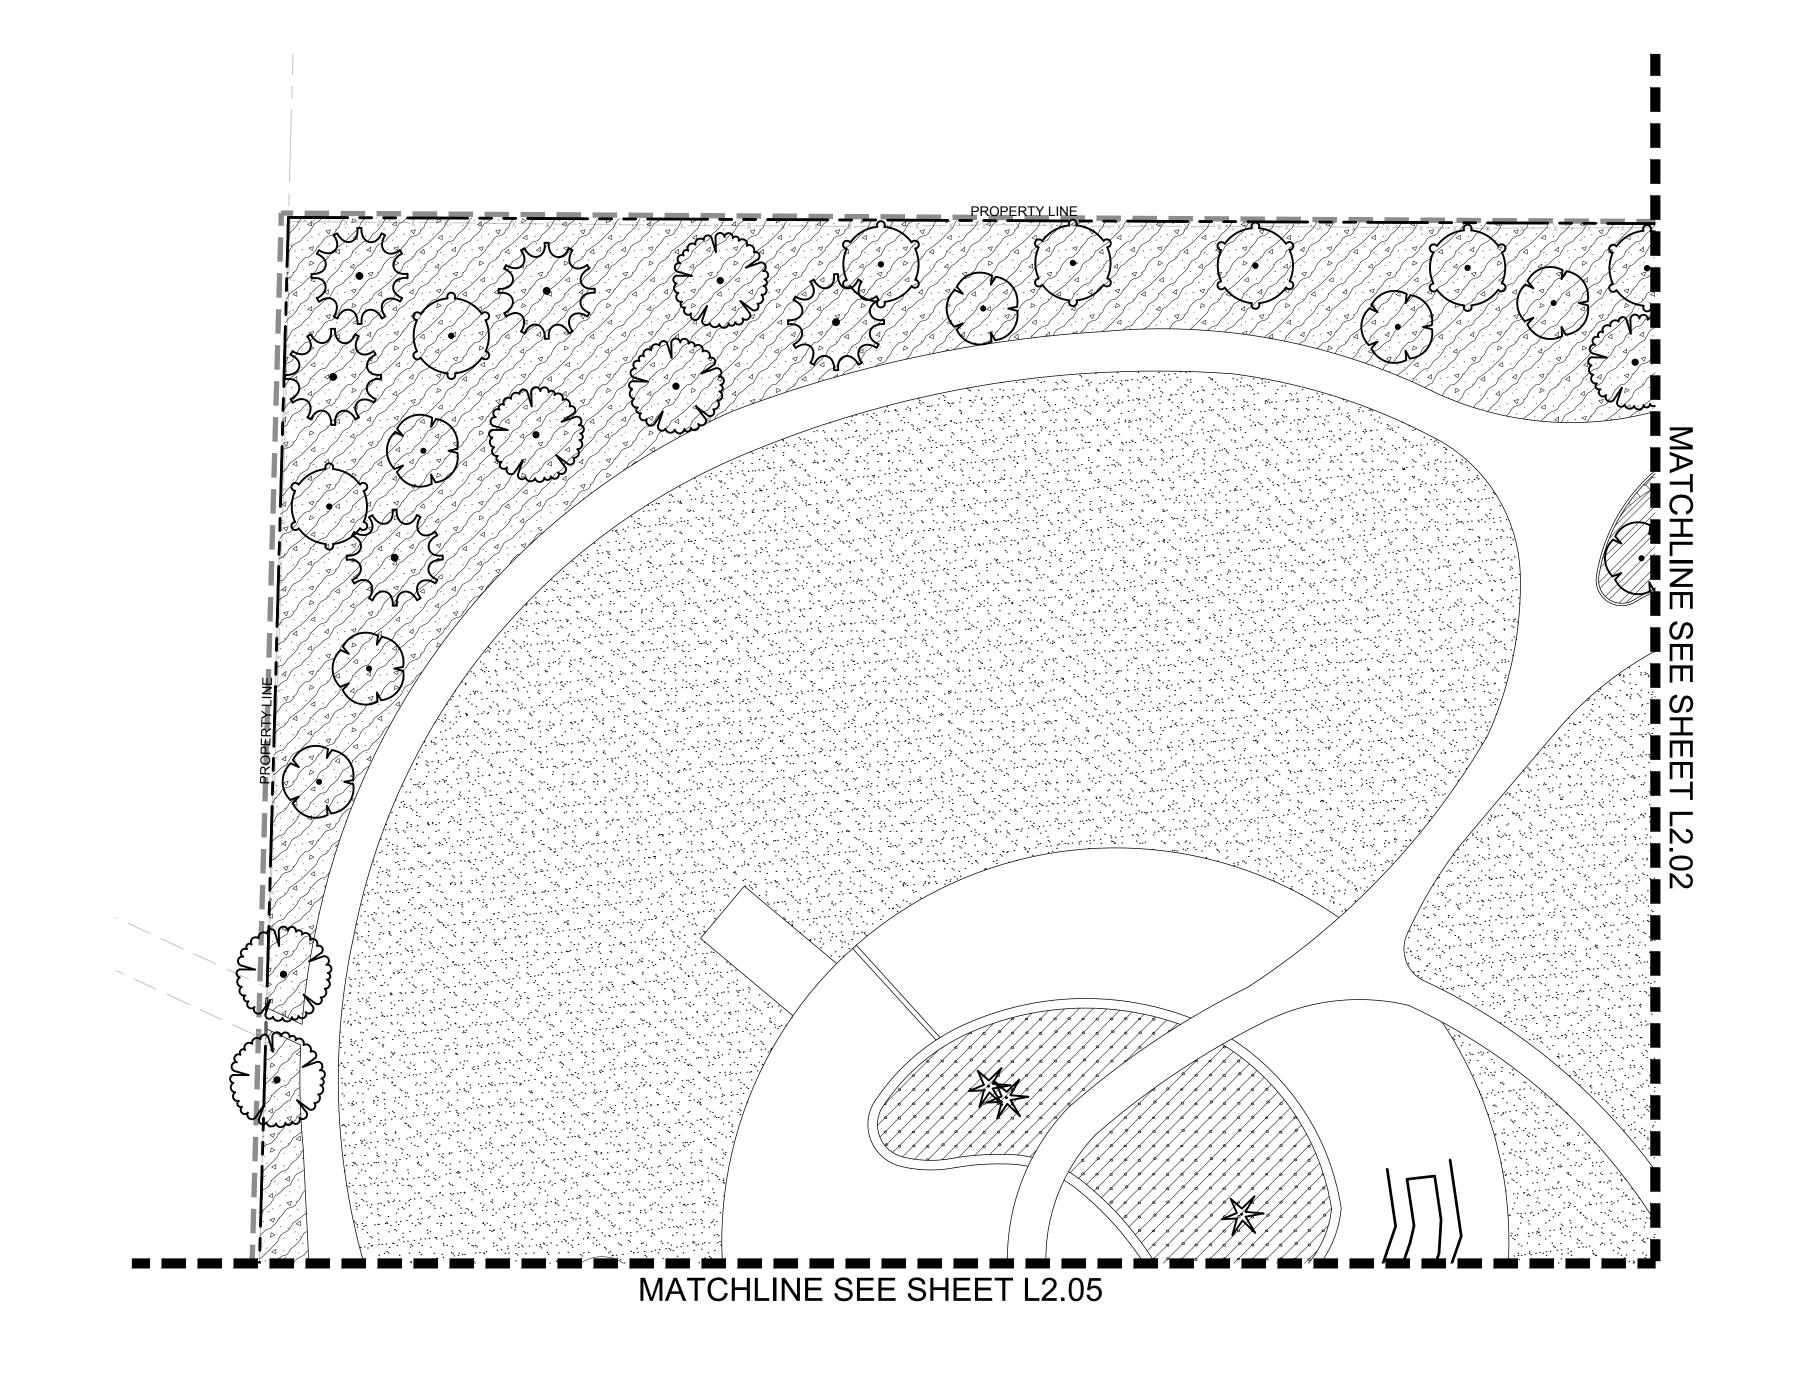
132ND SQUARE PARK
STORMWATER RETROFIT
OVERALL PLANTING PLAN

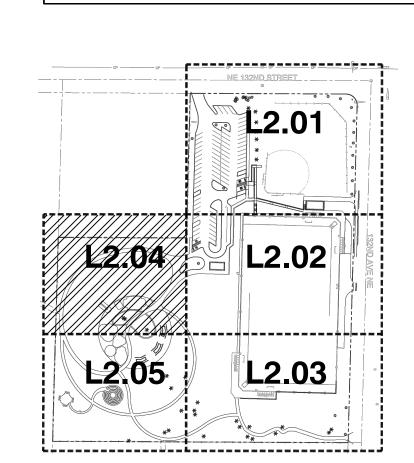
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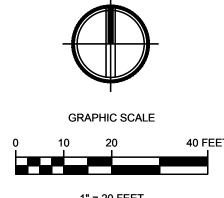


LEGEND

EXISTING FENCE TO REMAIN

EXISTING TREES TO REMAIN

SITE WALL, SEE CIVIL



1" = 20 FEET

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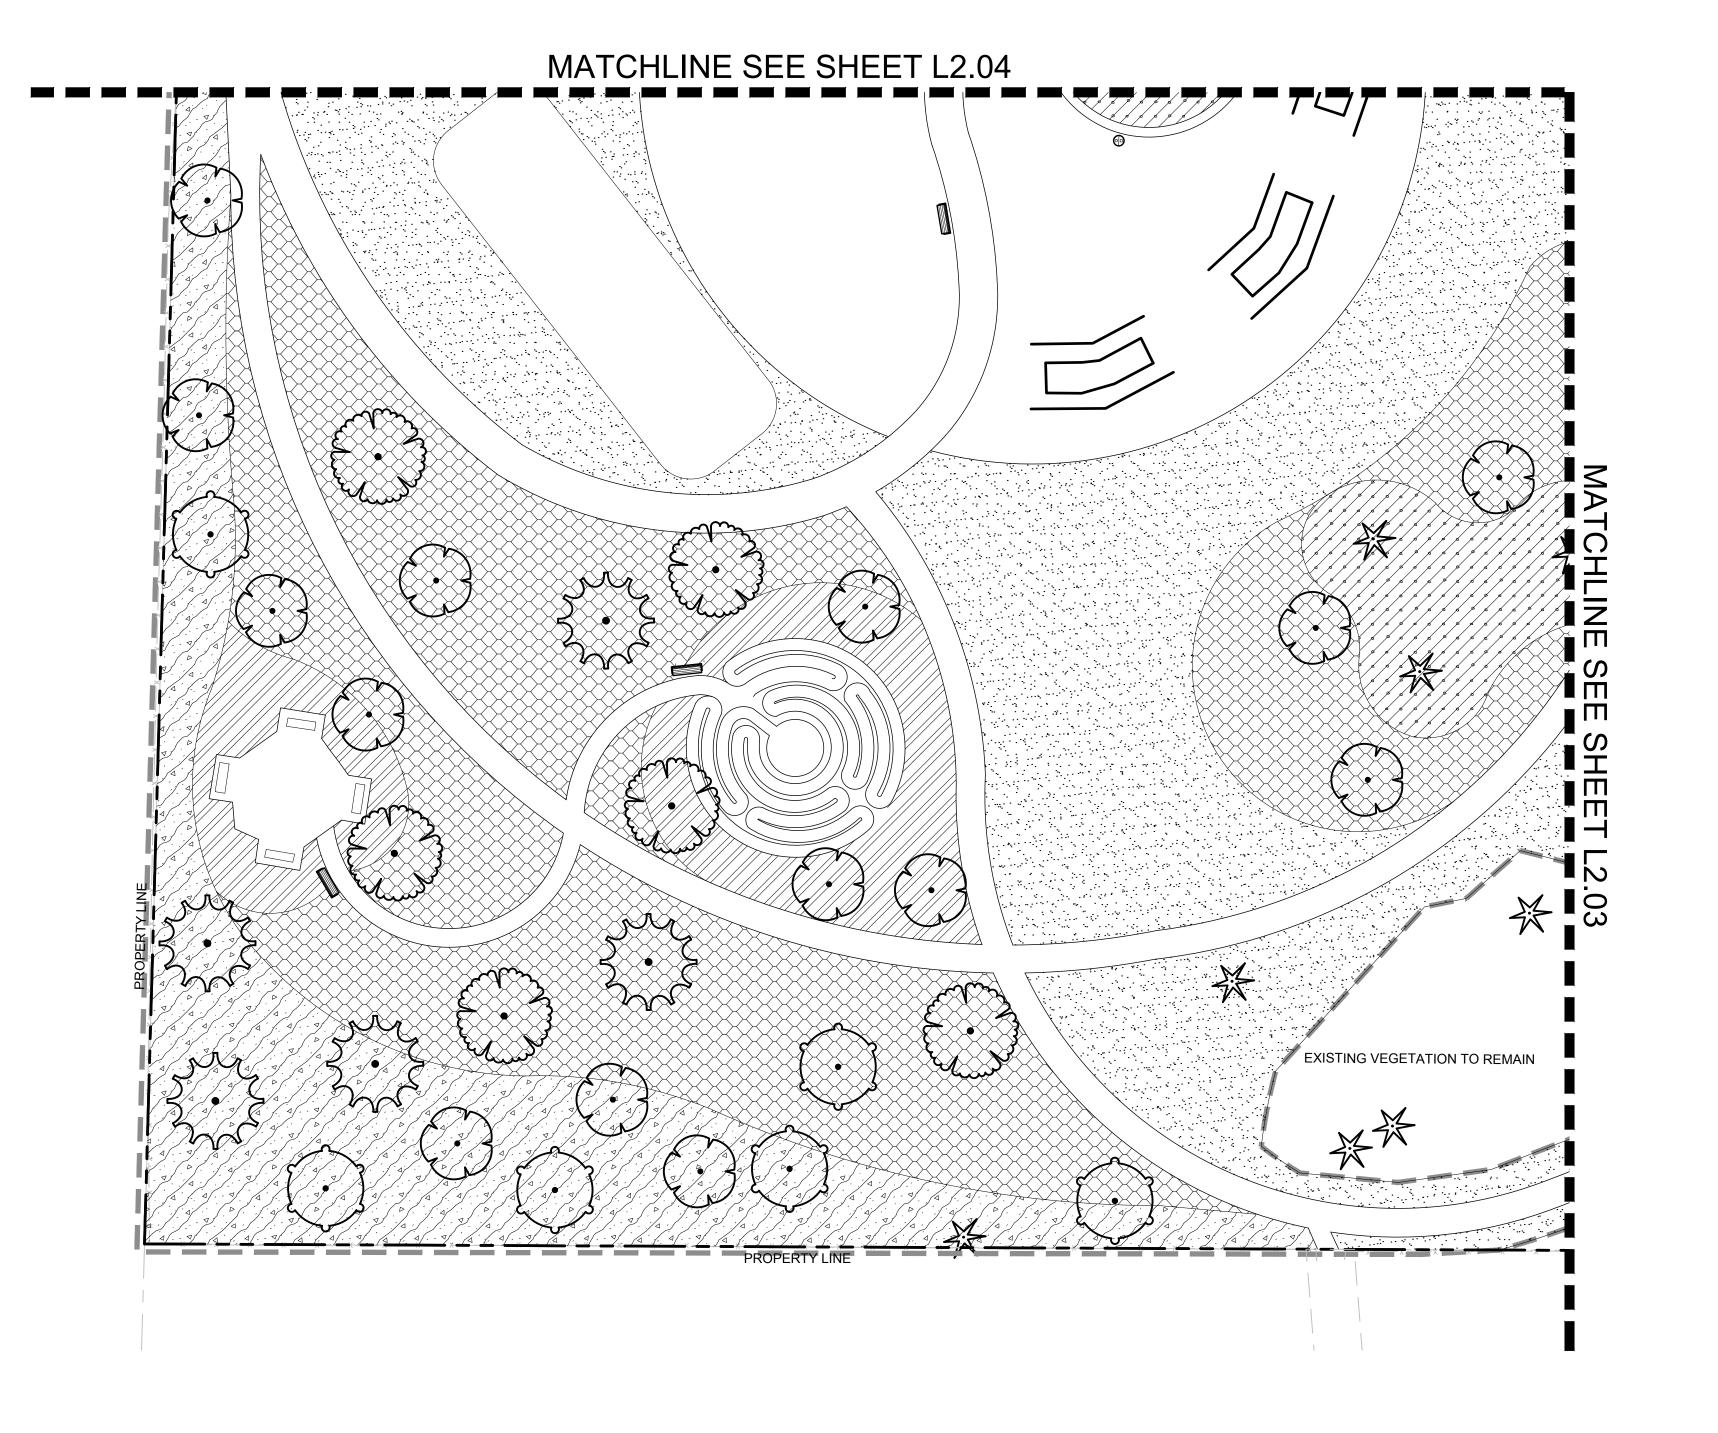


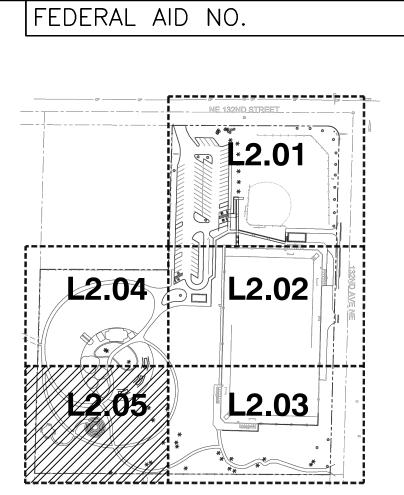
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STORMWATER RETROFIT **PLANTING PLAN**





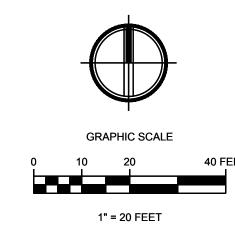
LEGEND

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EXISTING FENCE TO REMAIN
EXISTING TREES TO REMAIN

PROPERTY LINE

SITE WALL, SEE CIVIL



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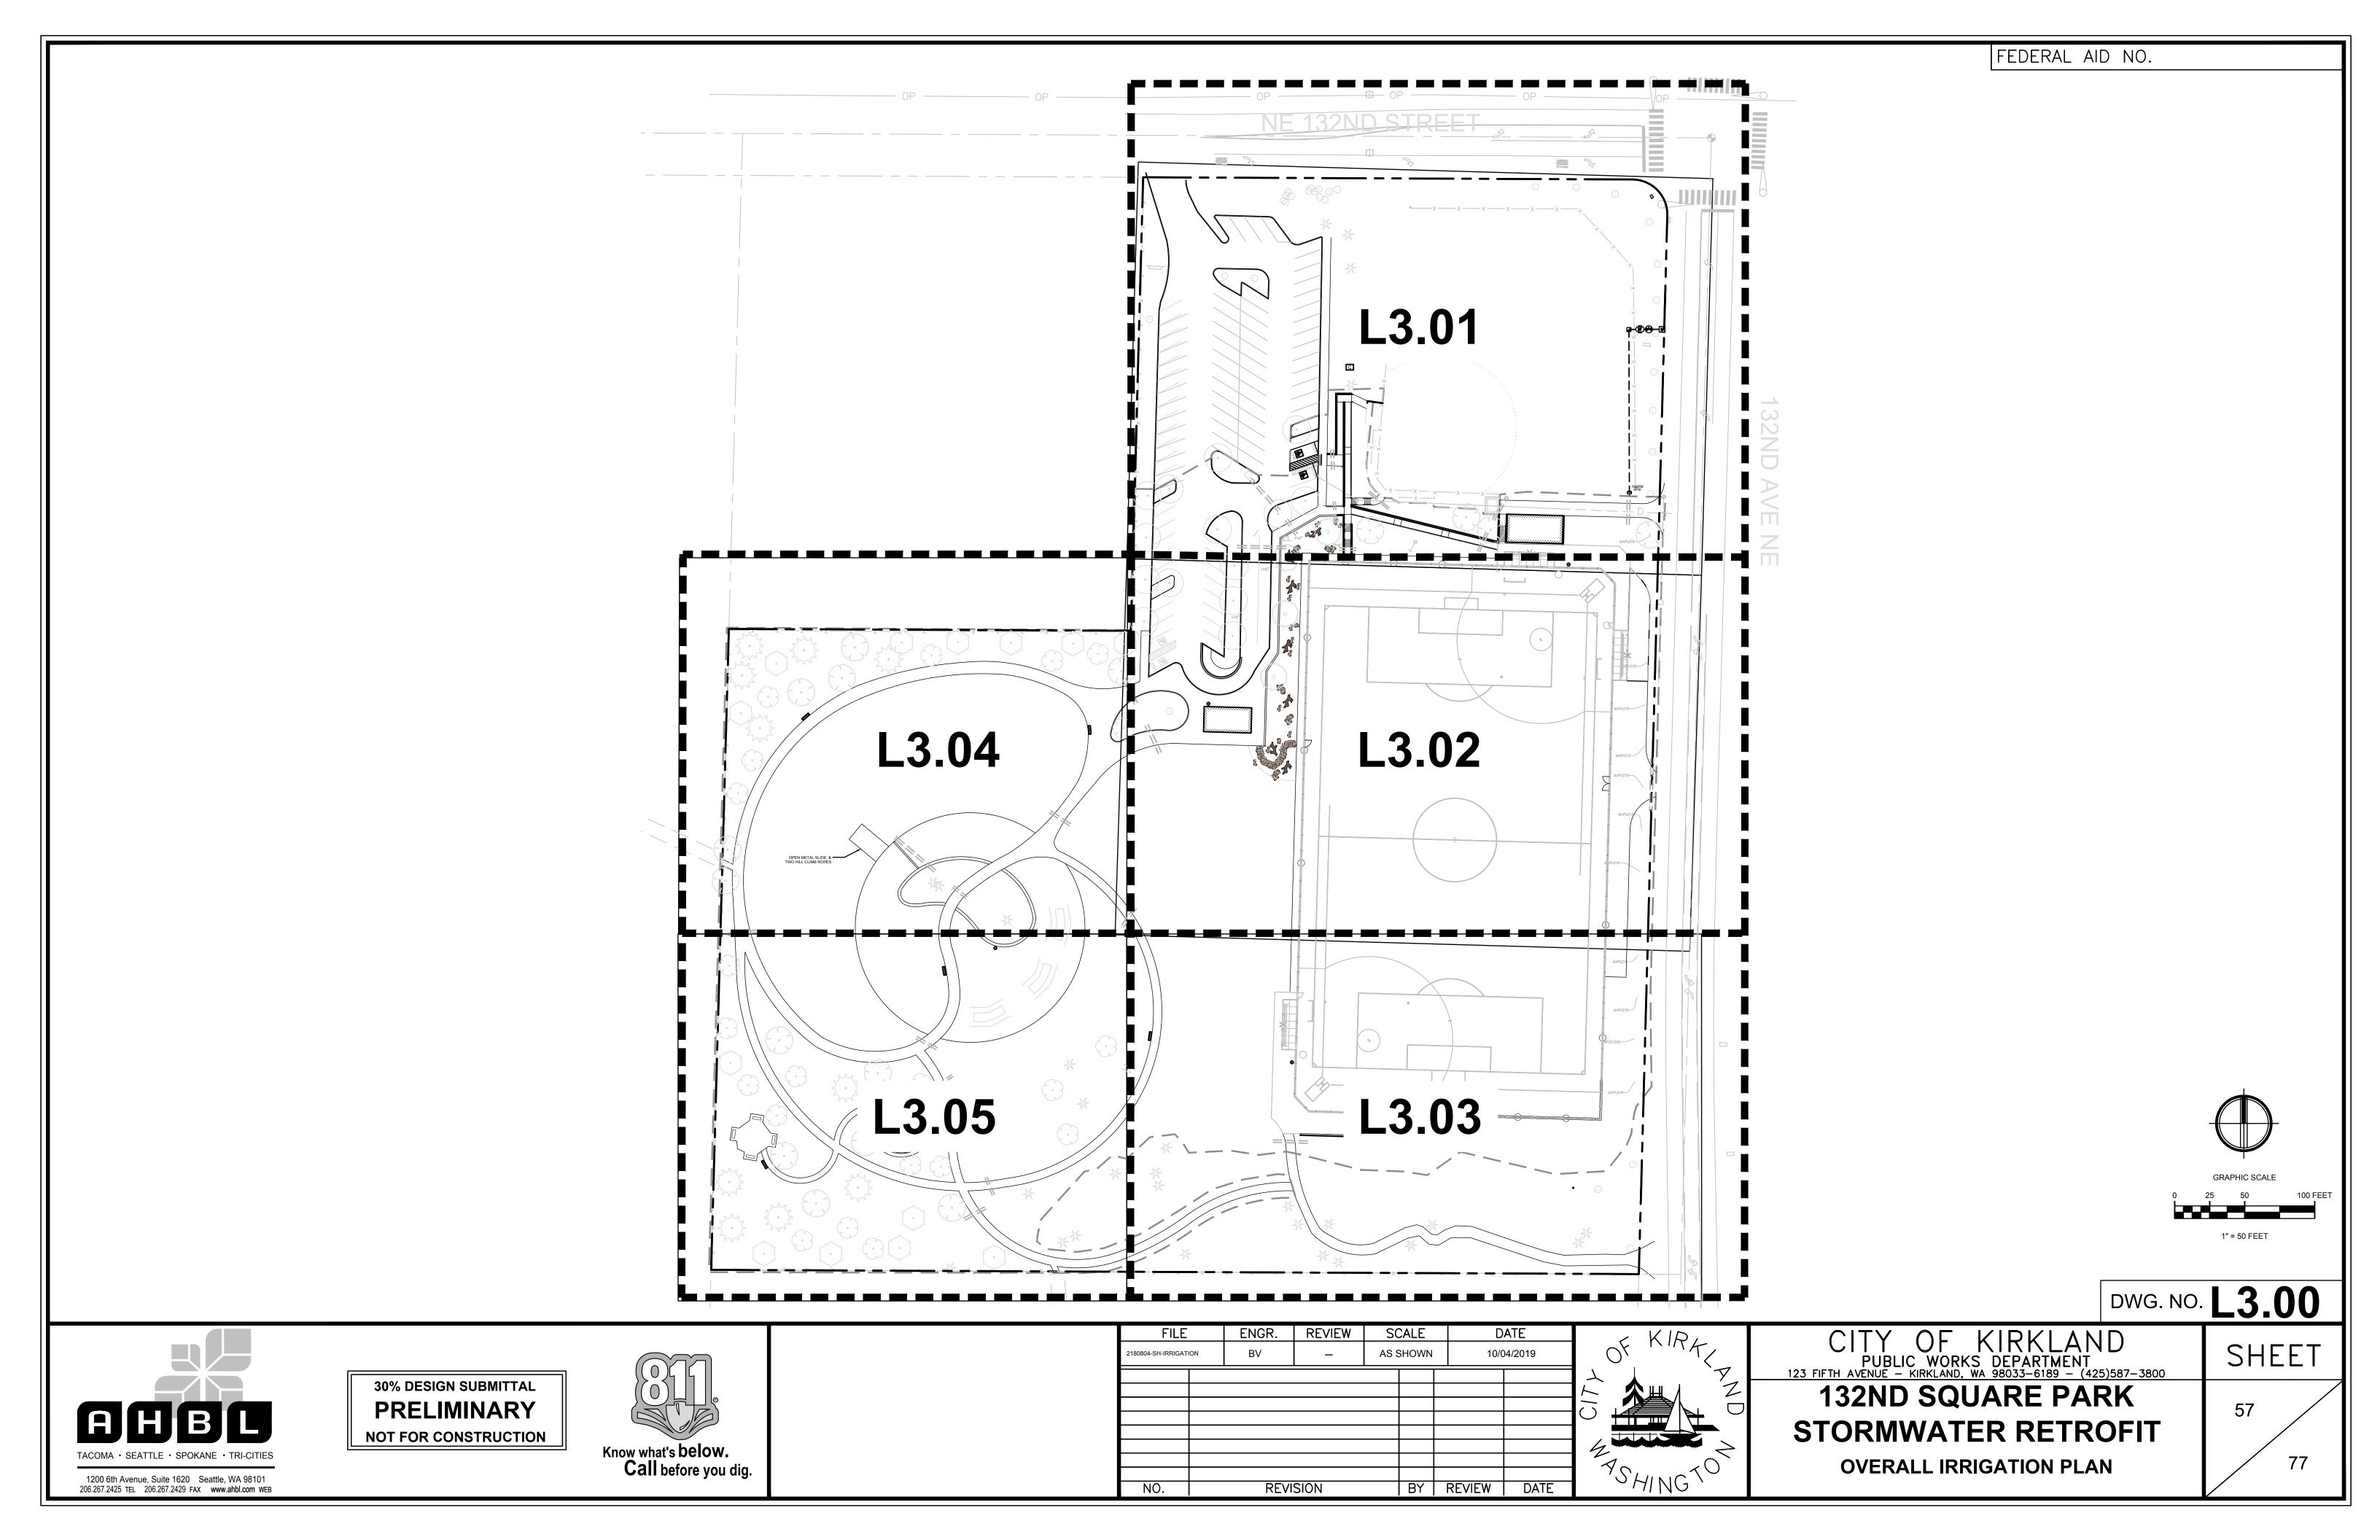


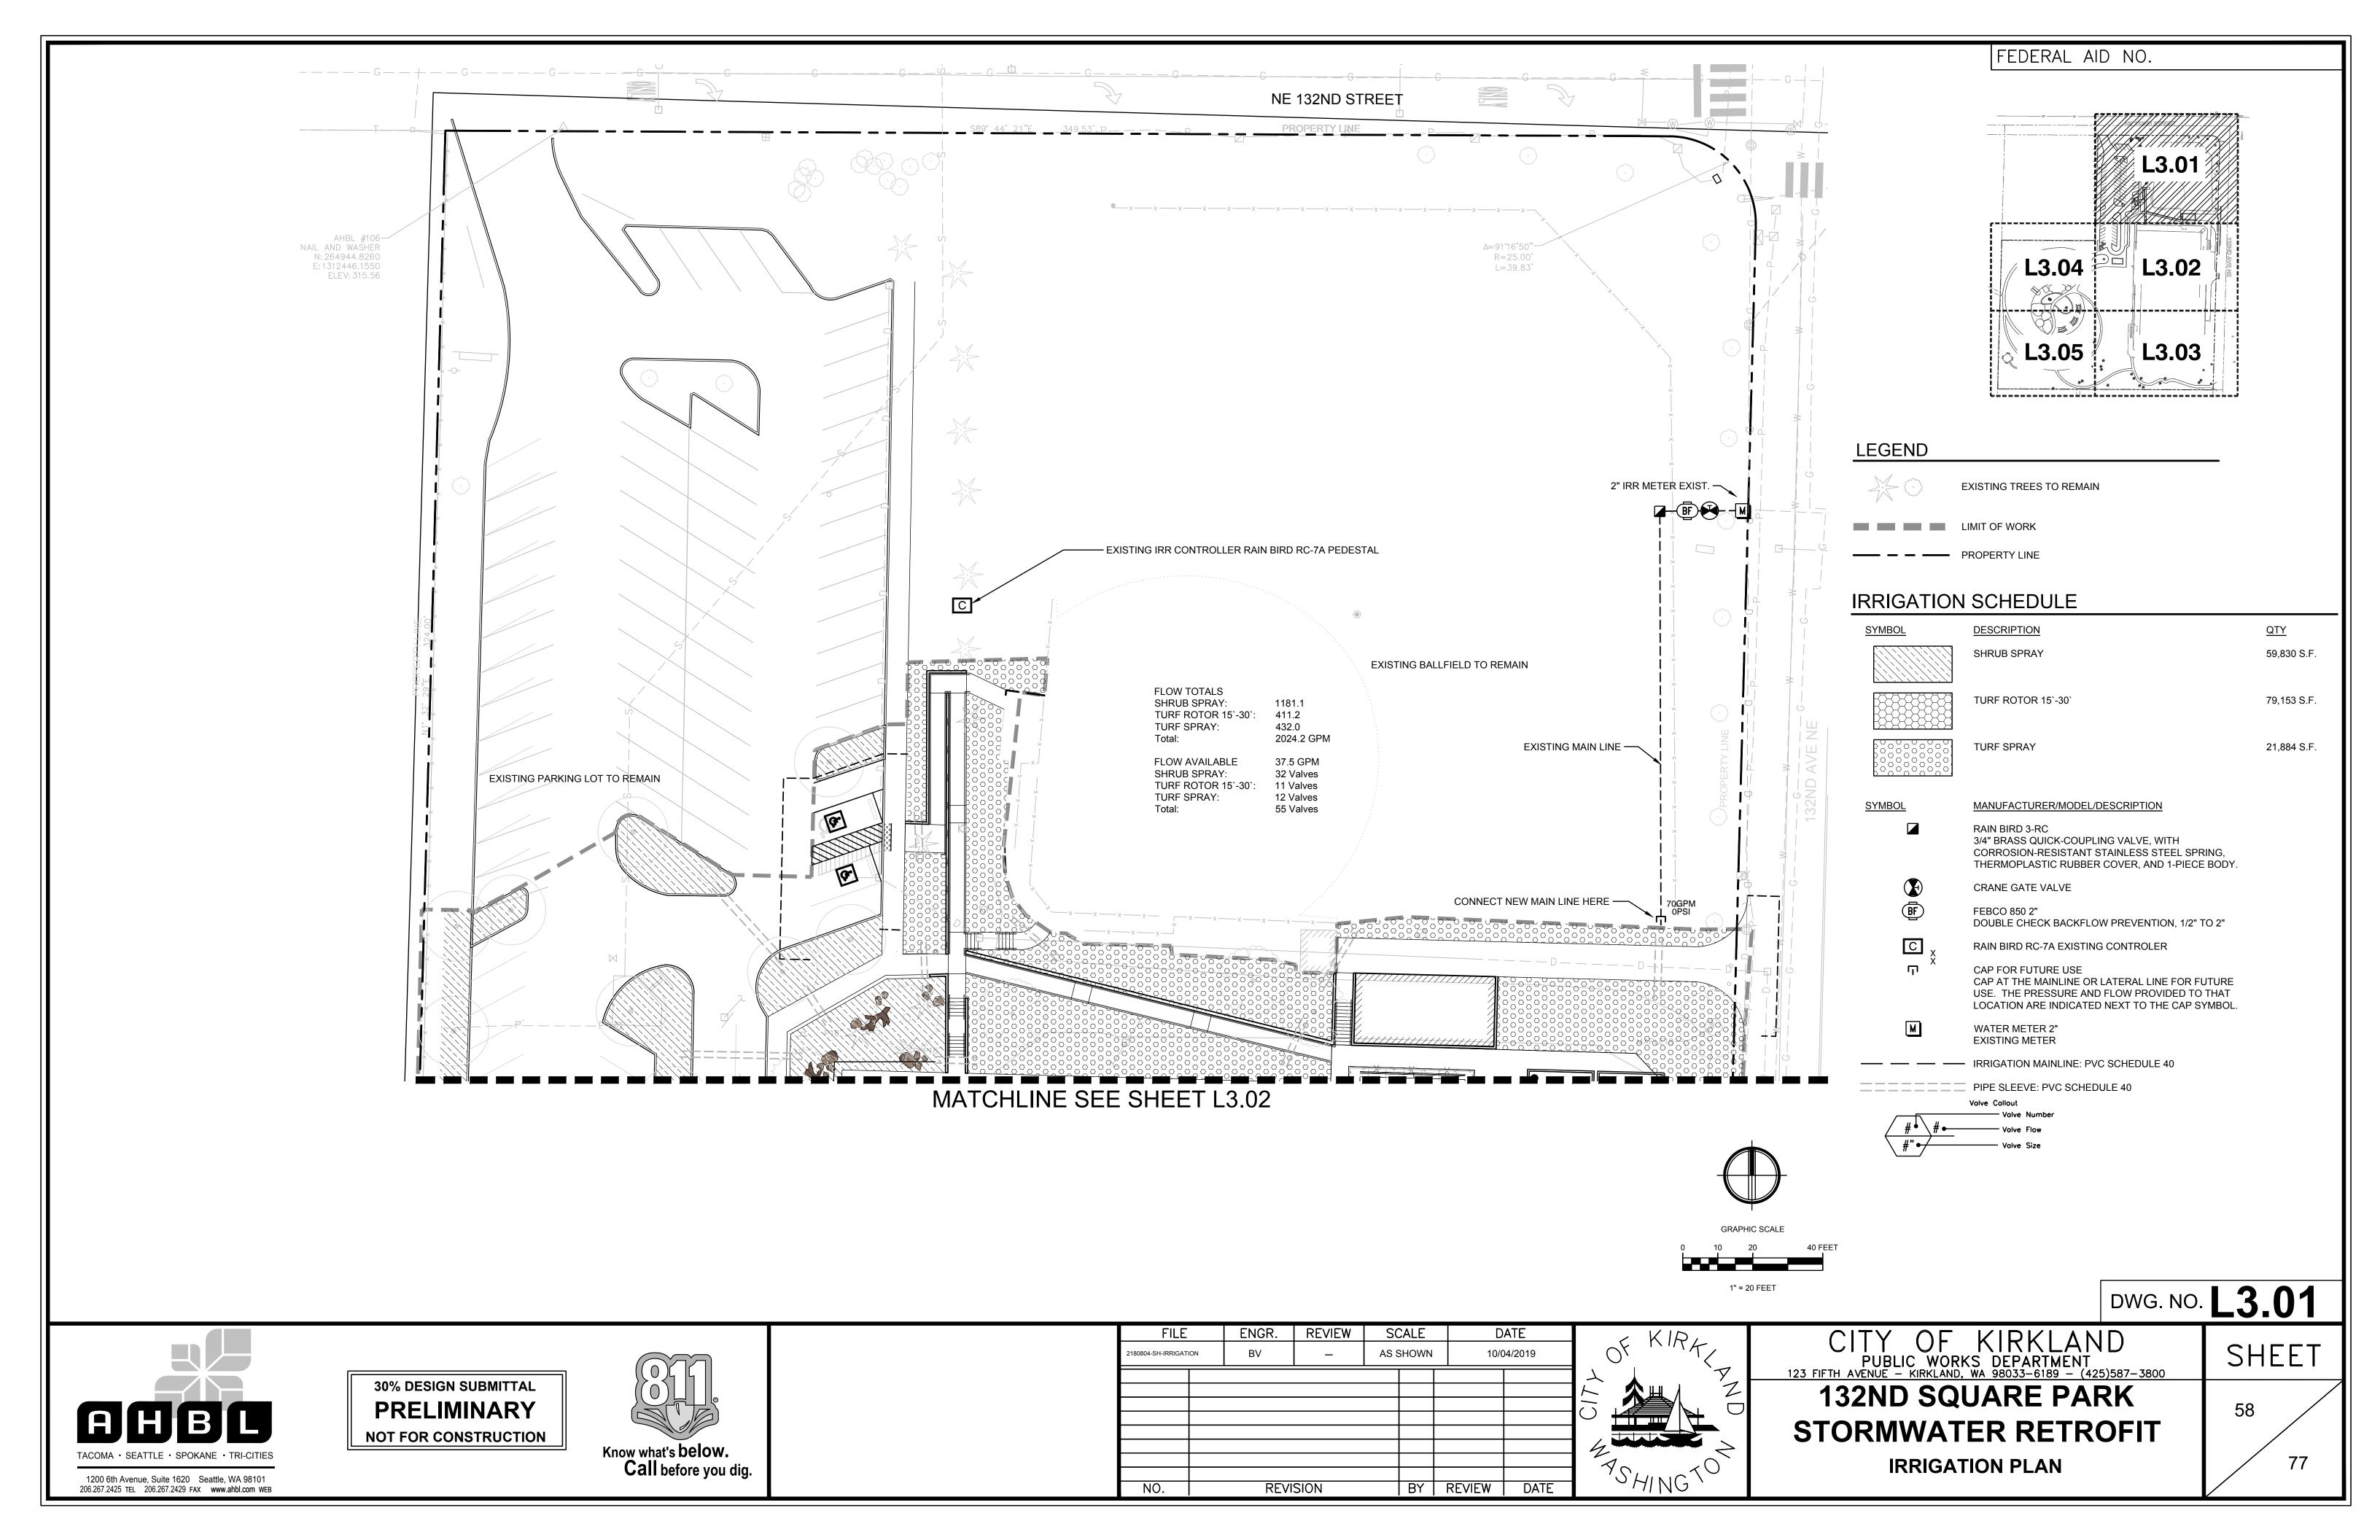
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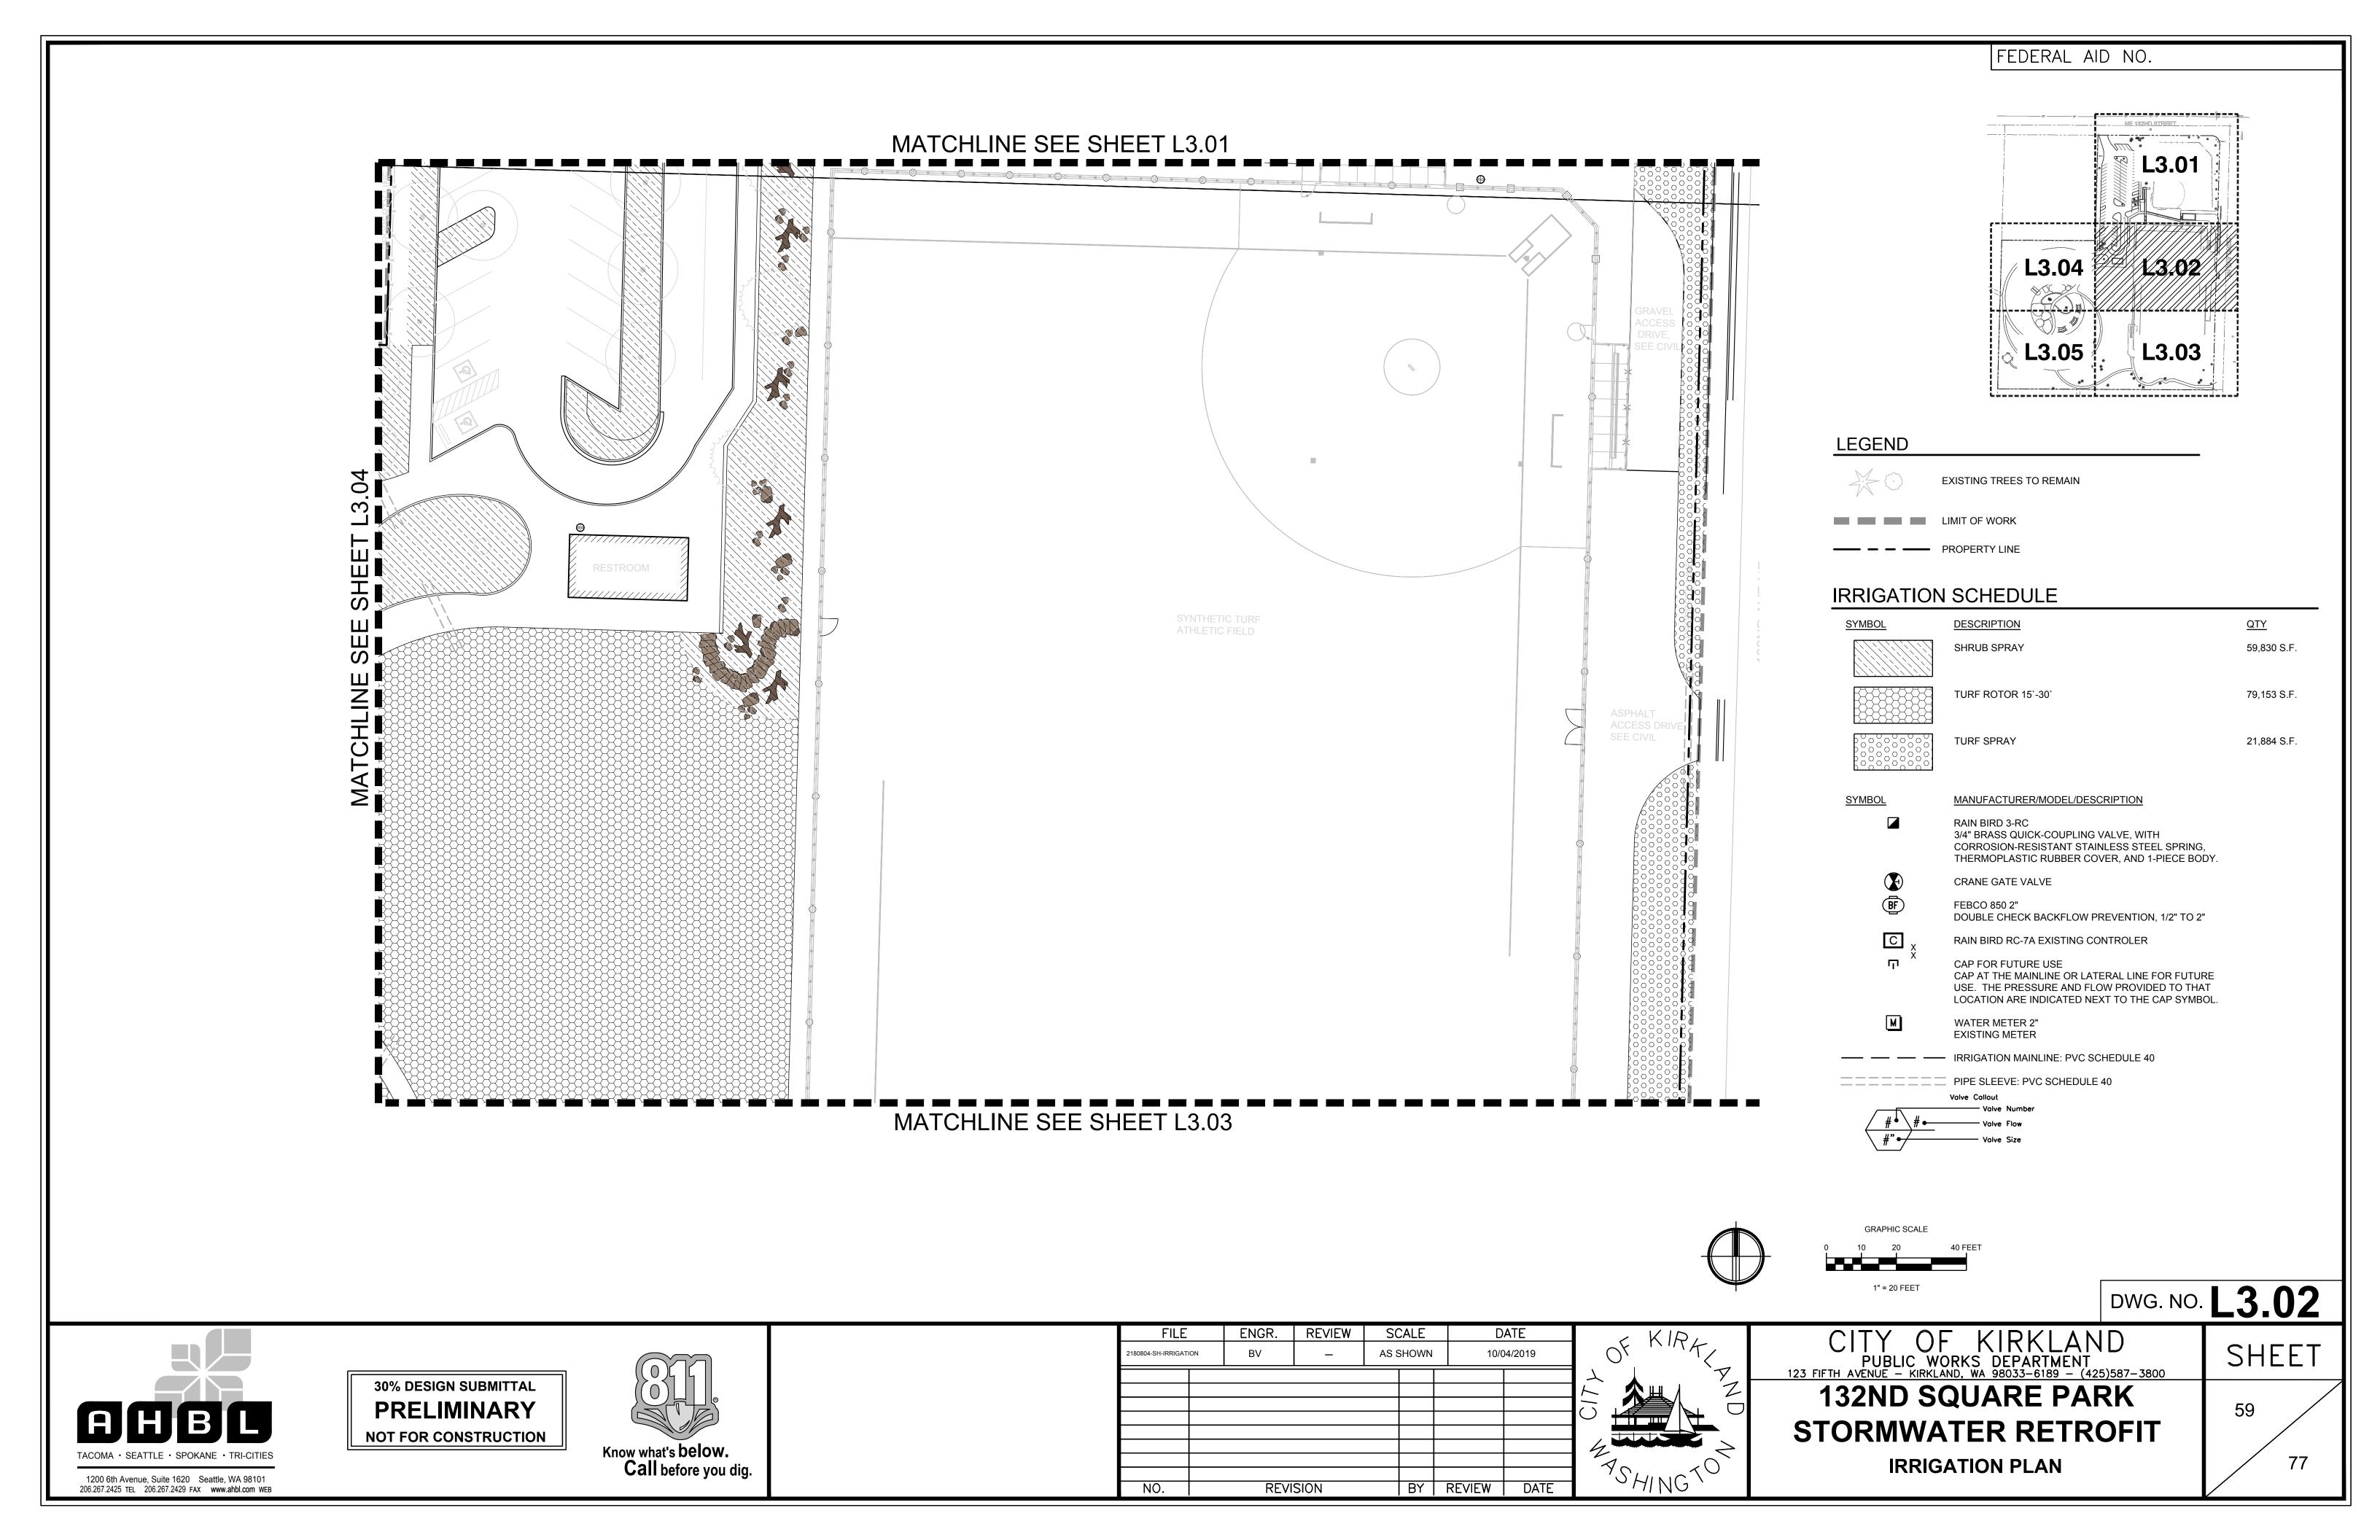


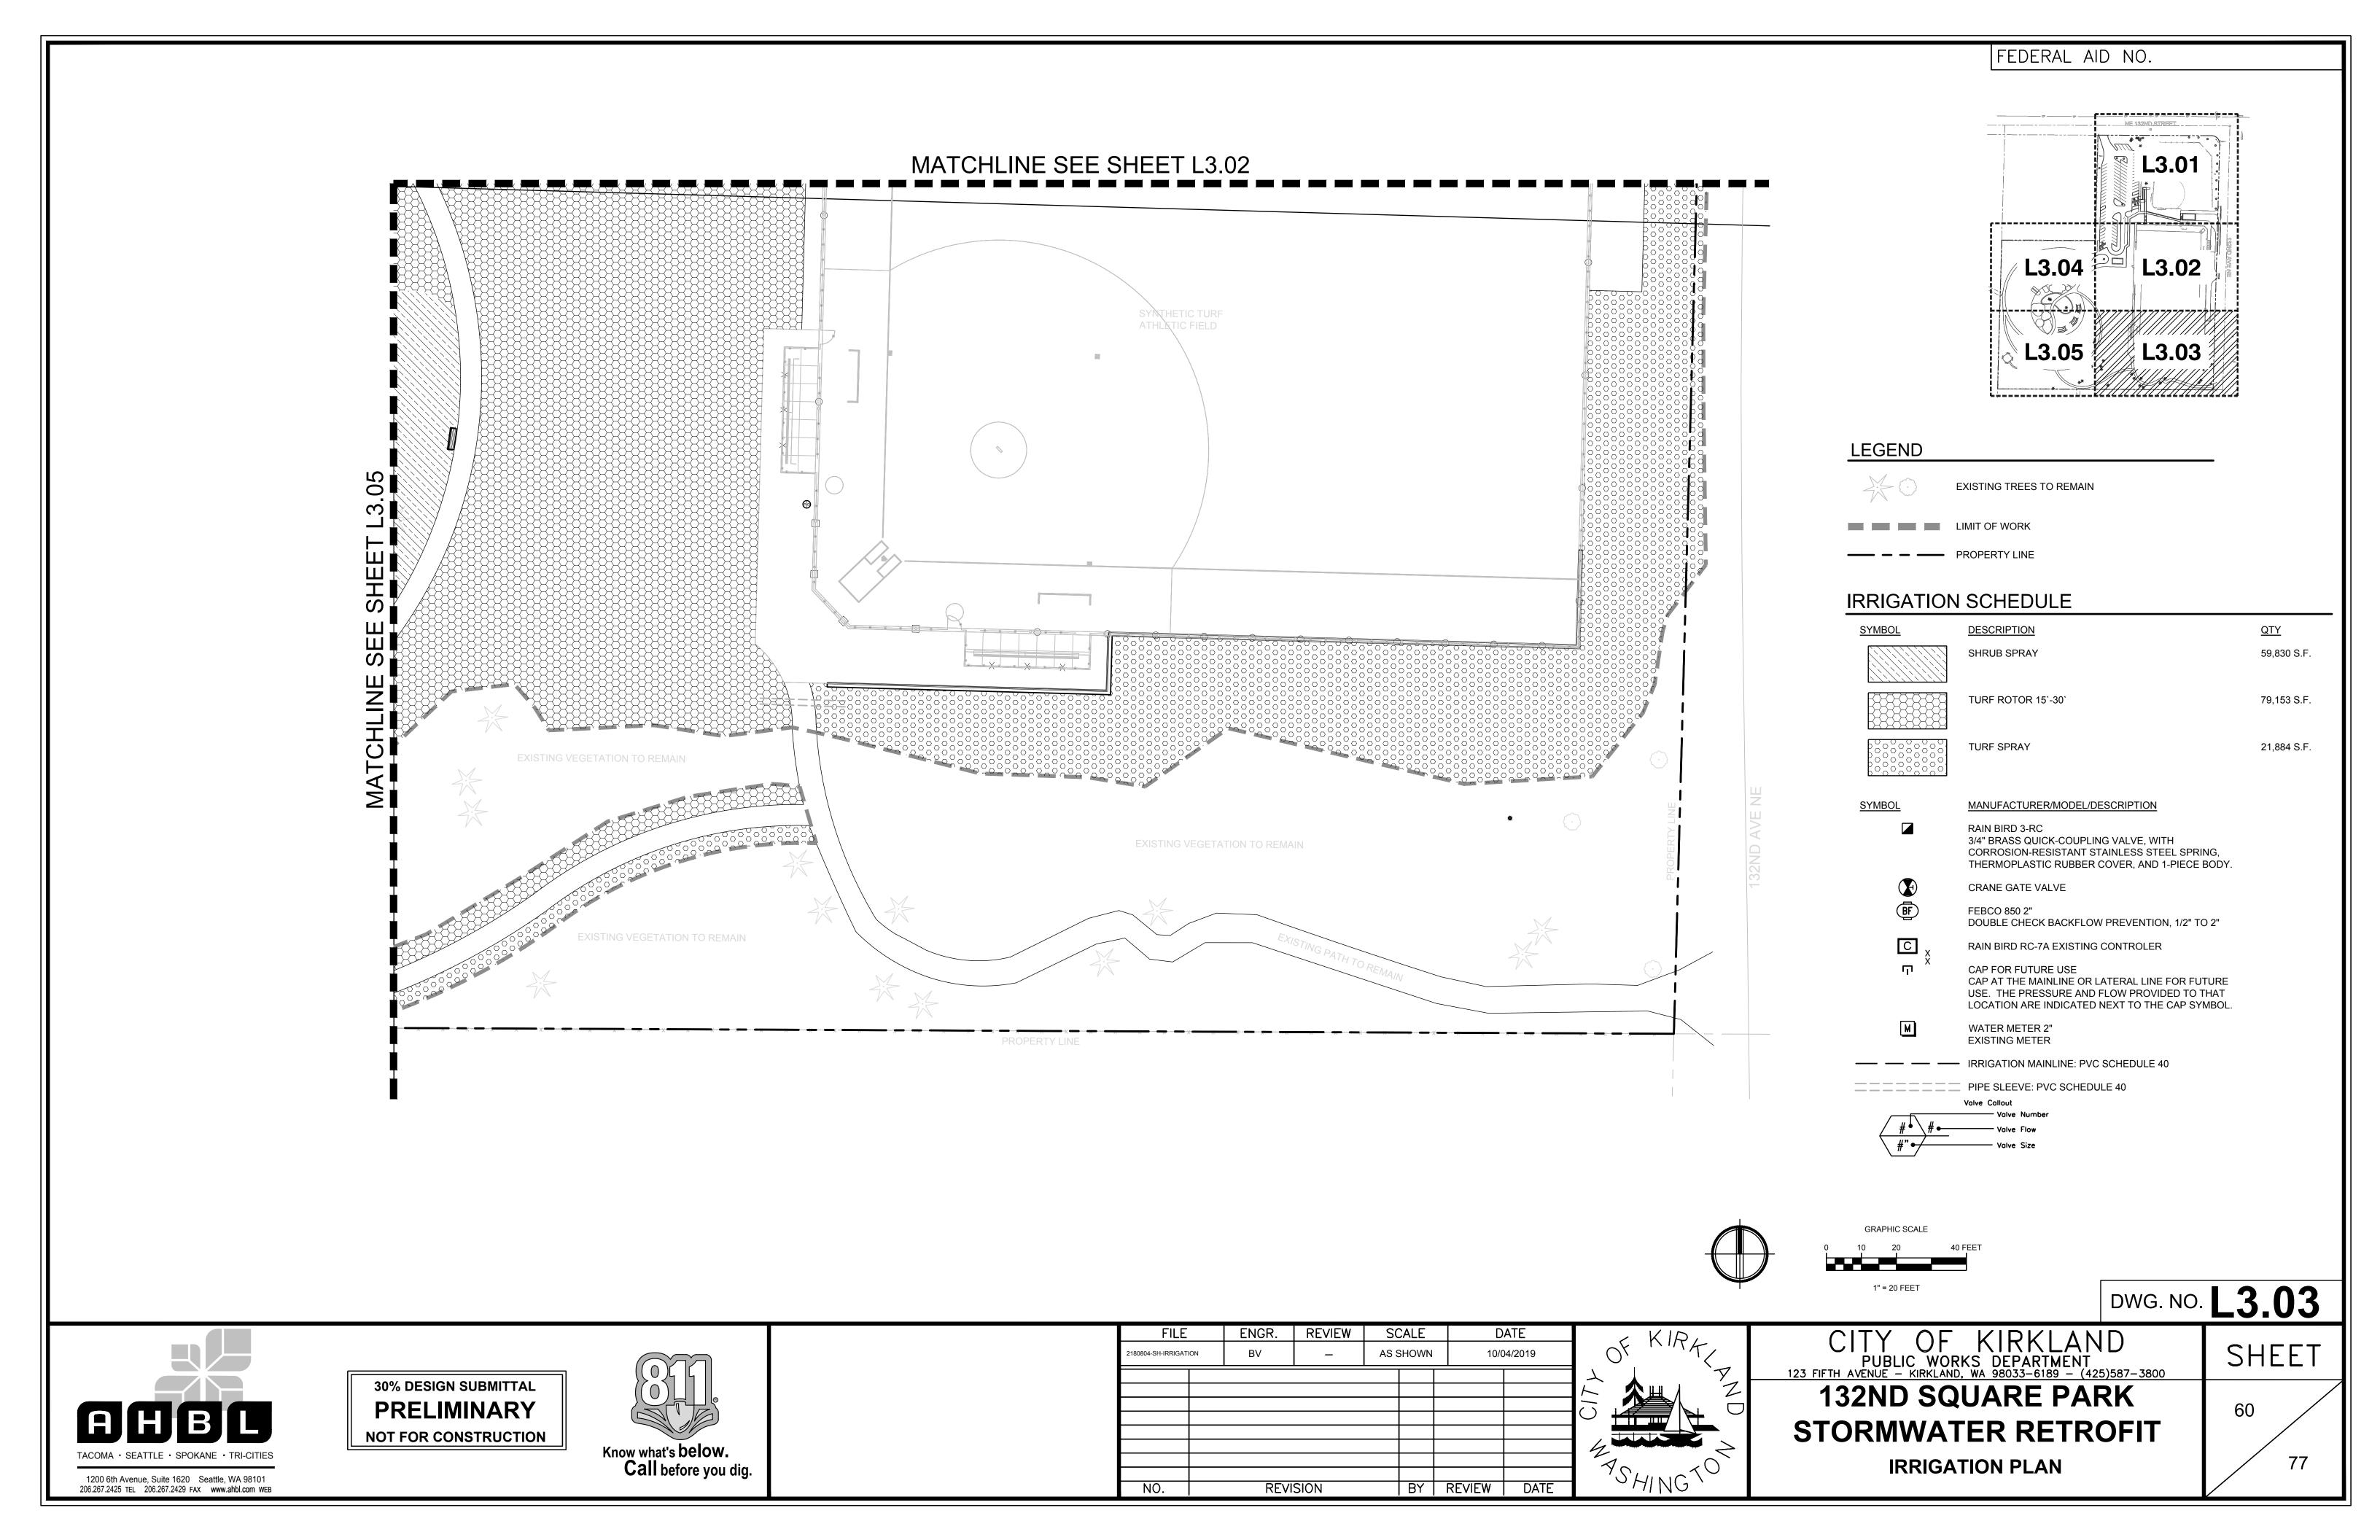
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132ND SQUARE PARK

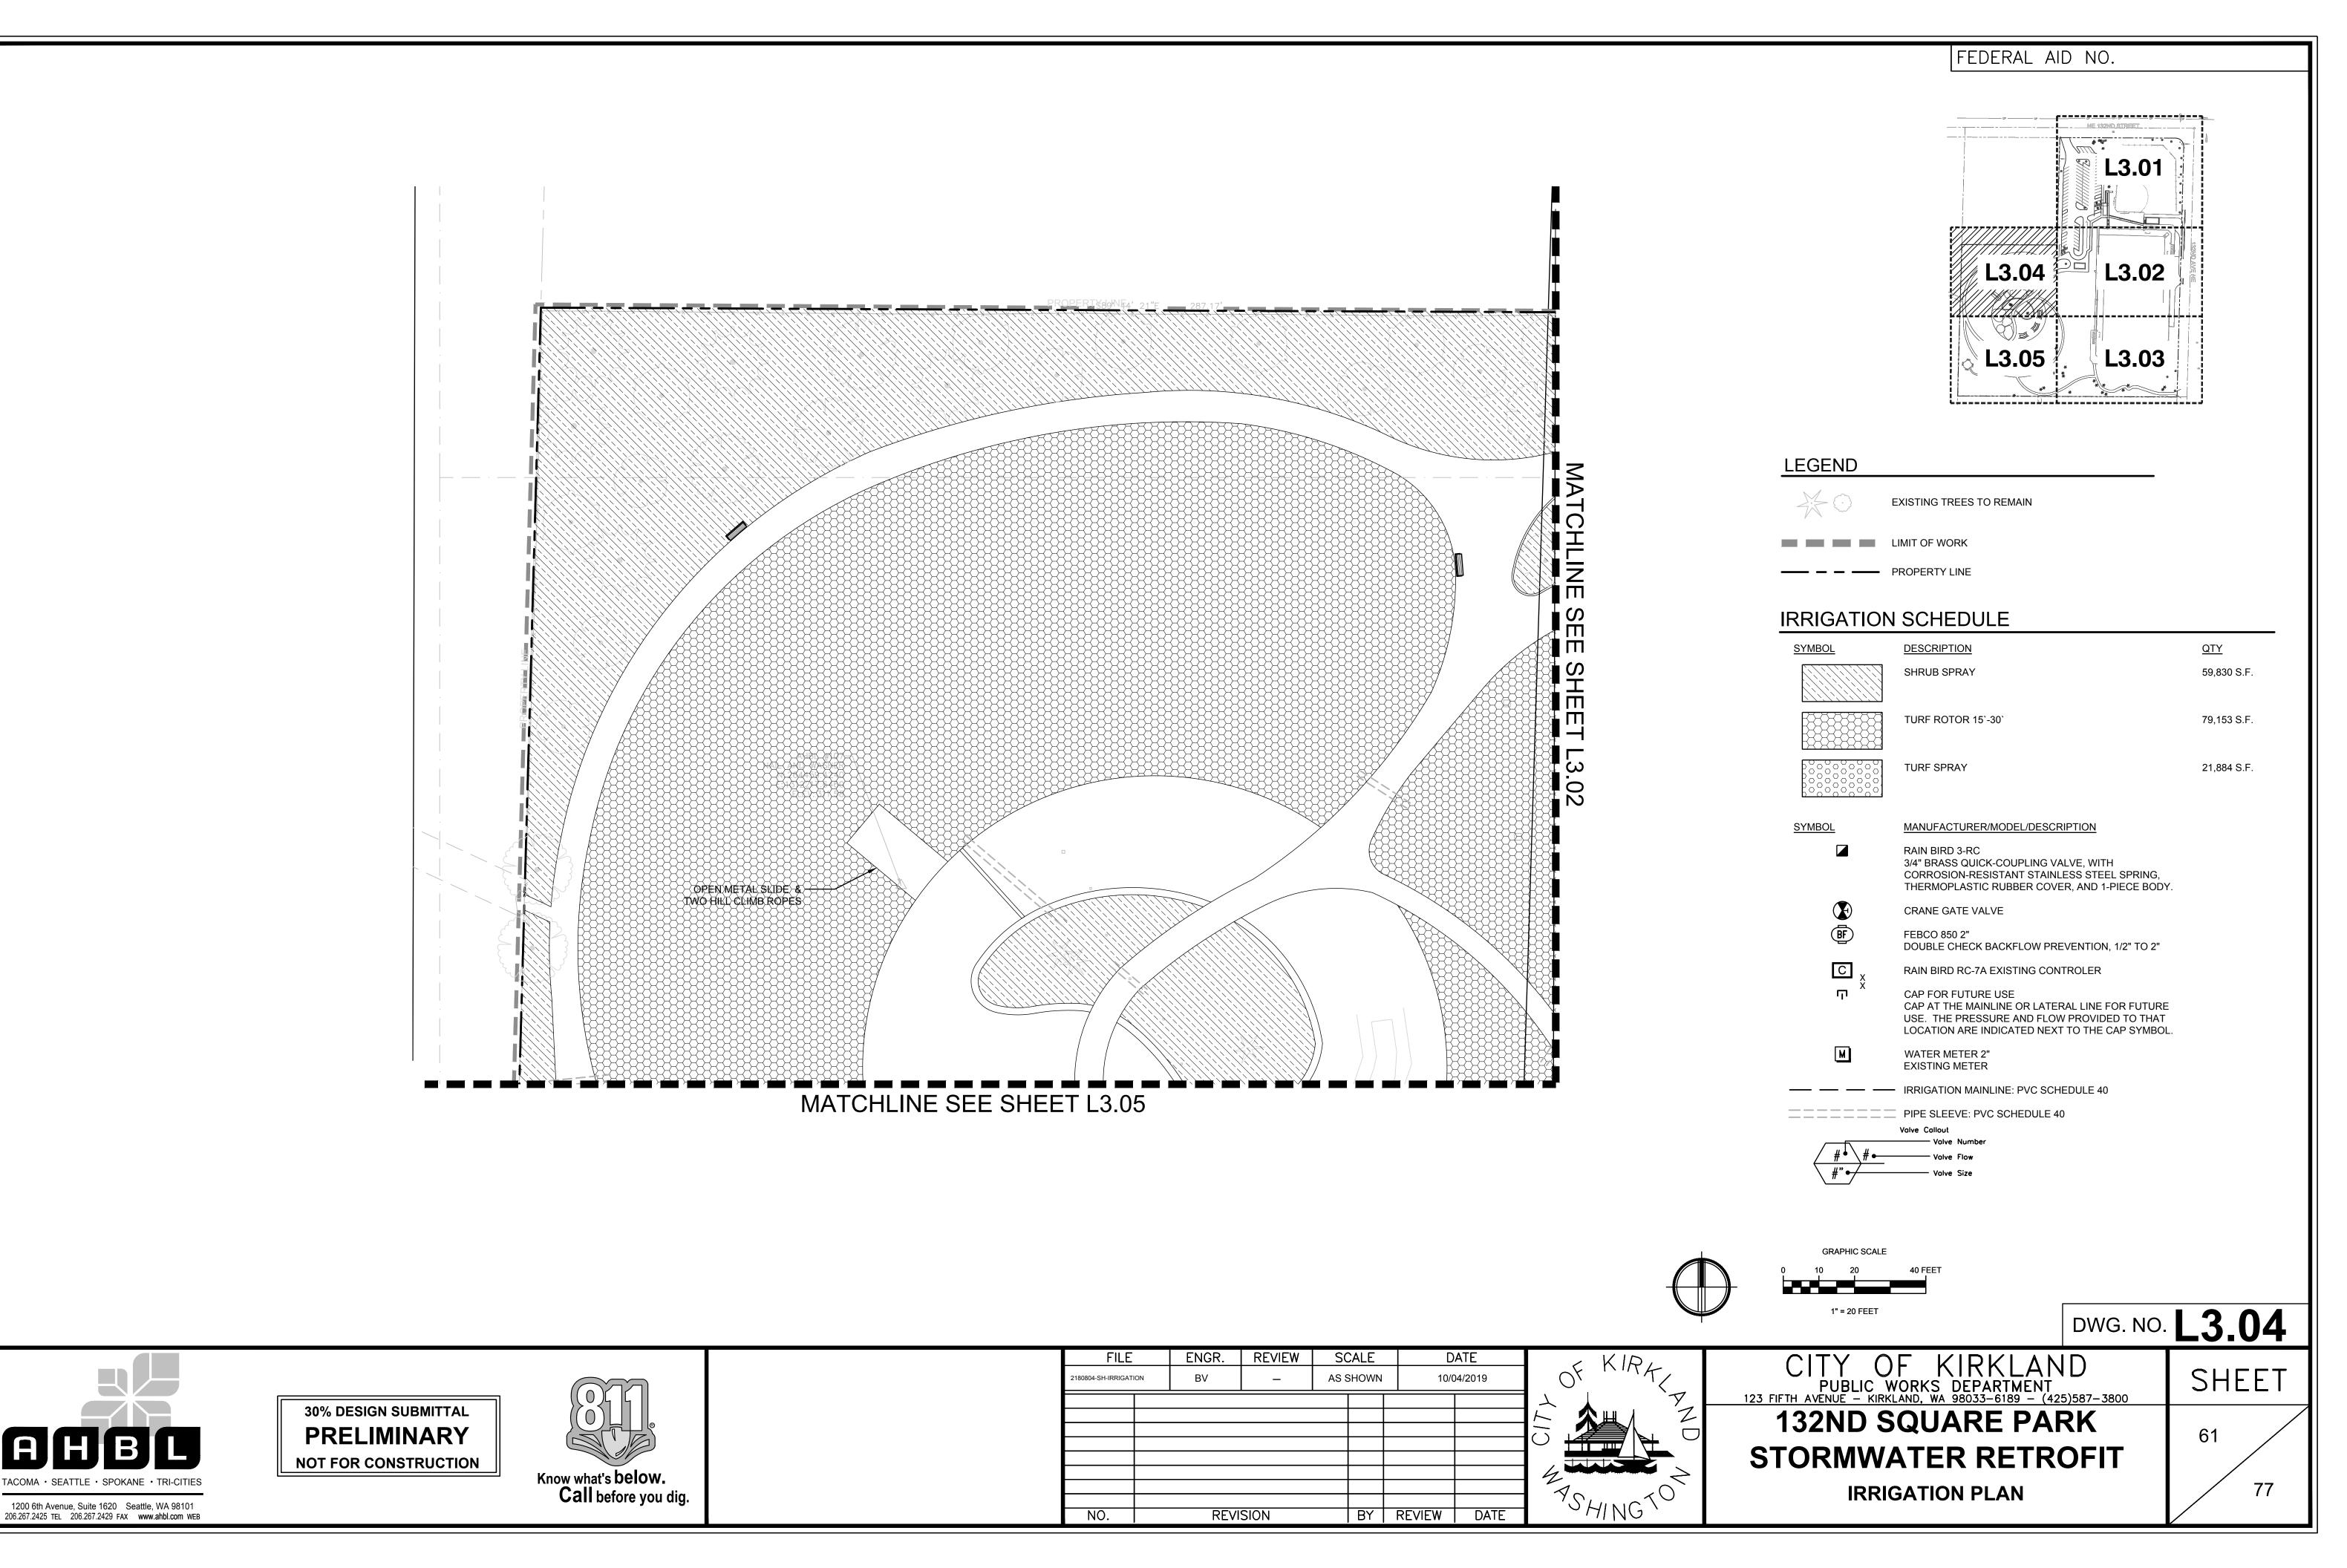
132ND SQUARE PARK
STORMWATER RETROFIT
PLANTING PLAN

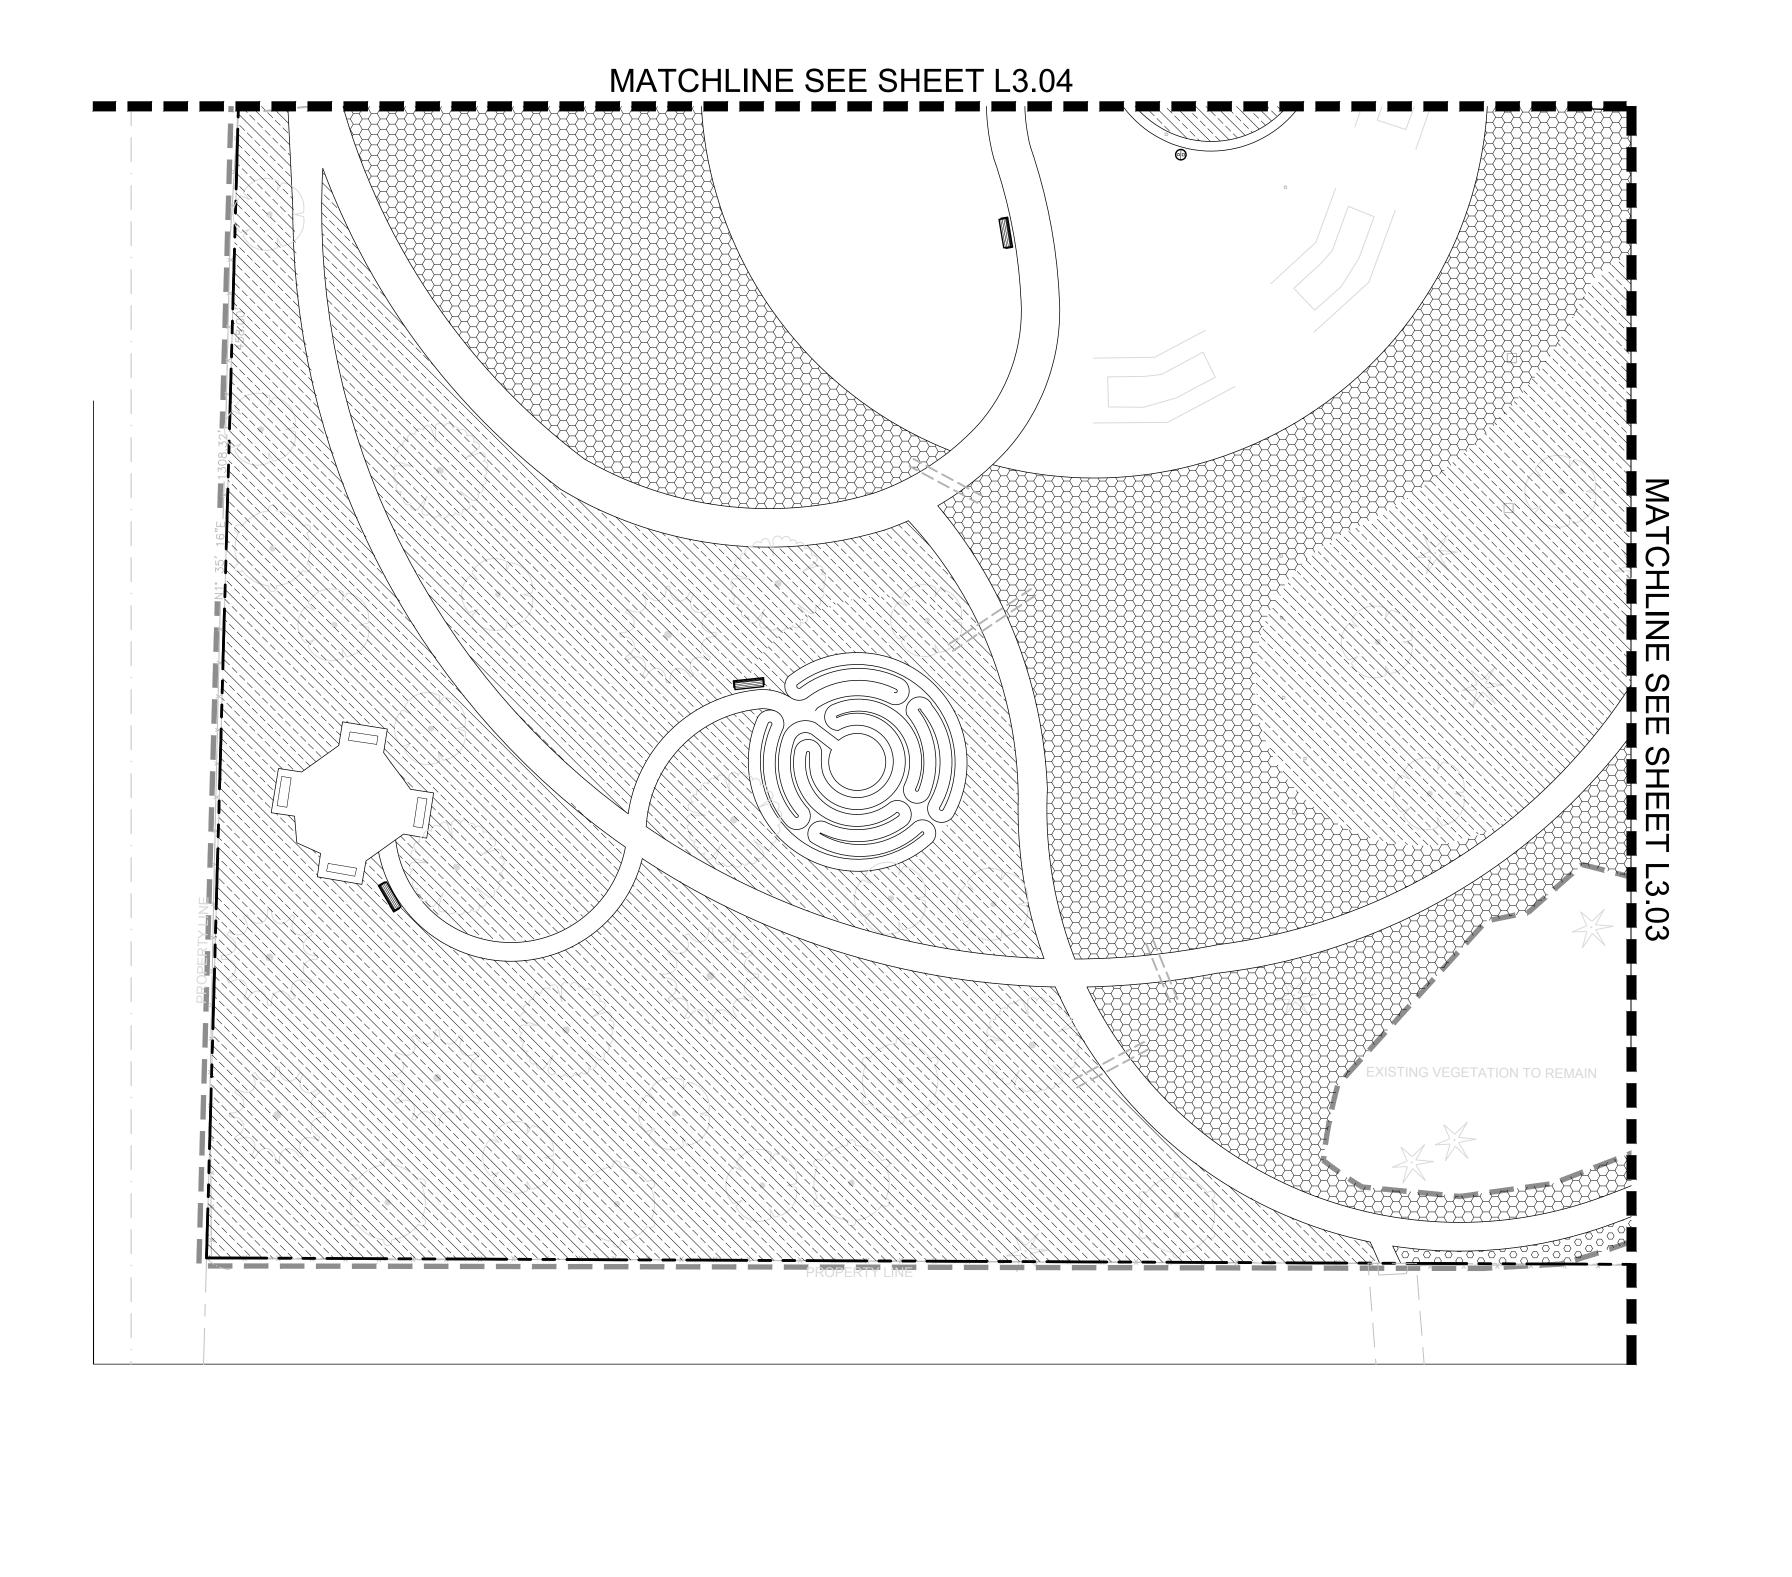


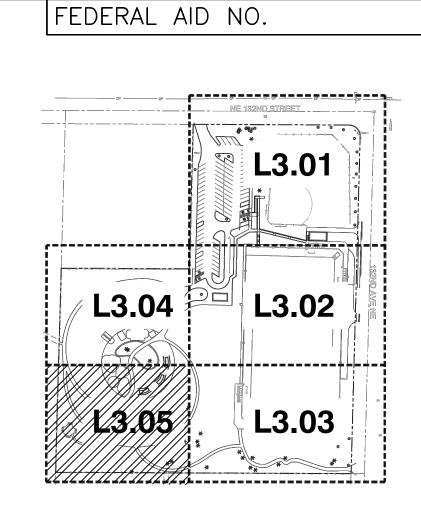












EXISTING TREES TO REMAIN

LEGEND

IRRIGATION SCHEDULE

STIVIBUL	DESCRIPTION	<u>QIT</u>
	SHRUB SPRAY	59,830 S.F.
	TURF ROTOR 15'-30'	79,153 S.F.
	TURF SPRAY	21,884 S.F.

MANUFACTURER/MODEL/DESCRIPTION

RAIN BIRD 3-RC 3/4" BRASS QUICK-COUPLING VALVE, WITH CORROSION-RESISTANT STAINLESS STEEL SPRING,

THERMOPLASTIC RUBBER COVER, AND 1-PIECE BODY.

CRANE GATE VALVE

FEBCO 850 2" DOUBLE CHECK BACKFLOW PREVENTION, 1/2" TO 2"

RAIN BIRD RC-7A EXISTING CONTROLER

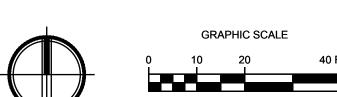
CAP FOR FUTURE USE CAP AT THE MAINLINE OR LATERAL LINE FOR FUTURE USE. THE PRESSURE AND FLOW PROVIDED TO THAT

LOCATION ARE INDICATED NEXT TO THE CAP SYMBOL. WATER METER 2"

--- -- IRRIGATION MAINLINE: PVC SCHEDULE 40

EXISTING METER

PIPE SLEEVE: PVC SCHEDULE 40



1" = 20 FEET

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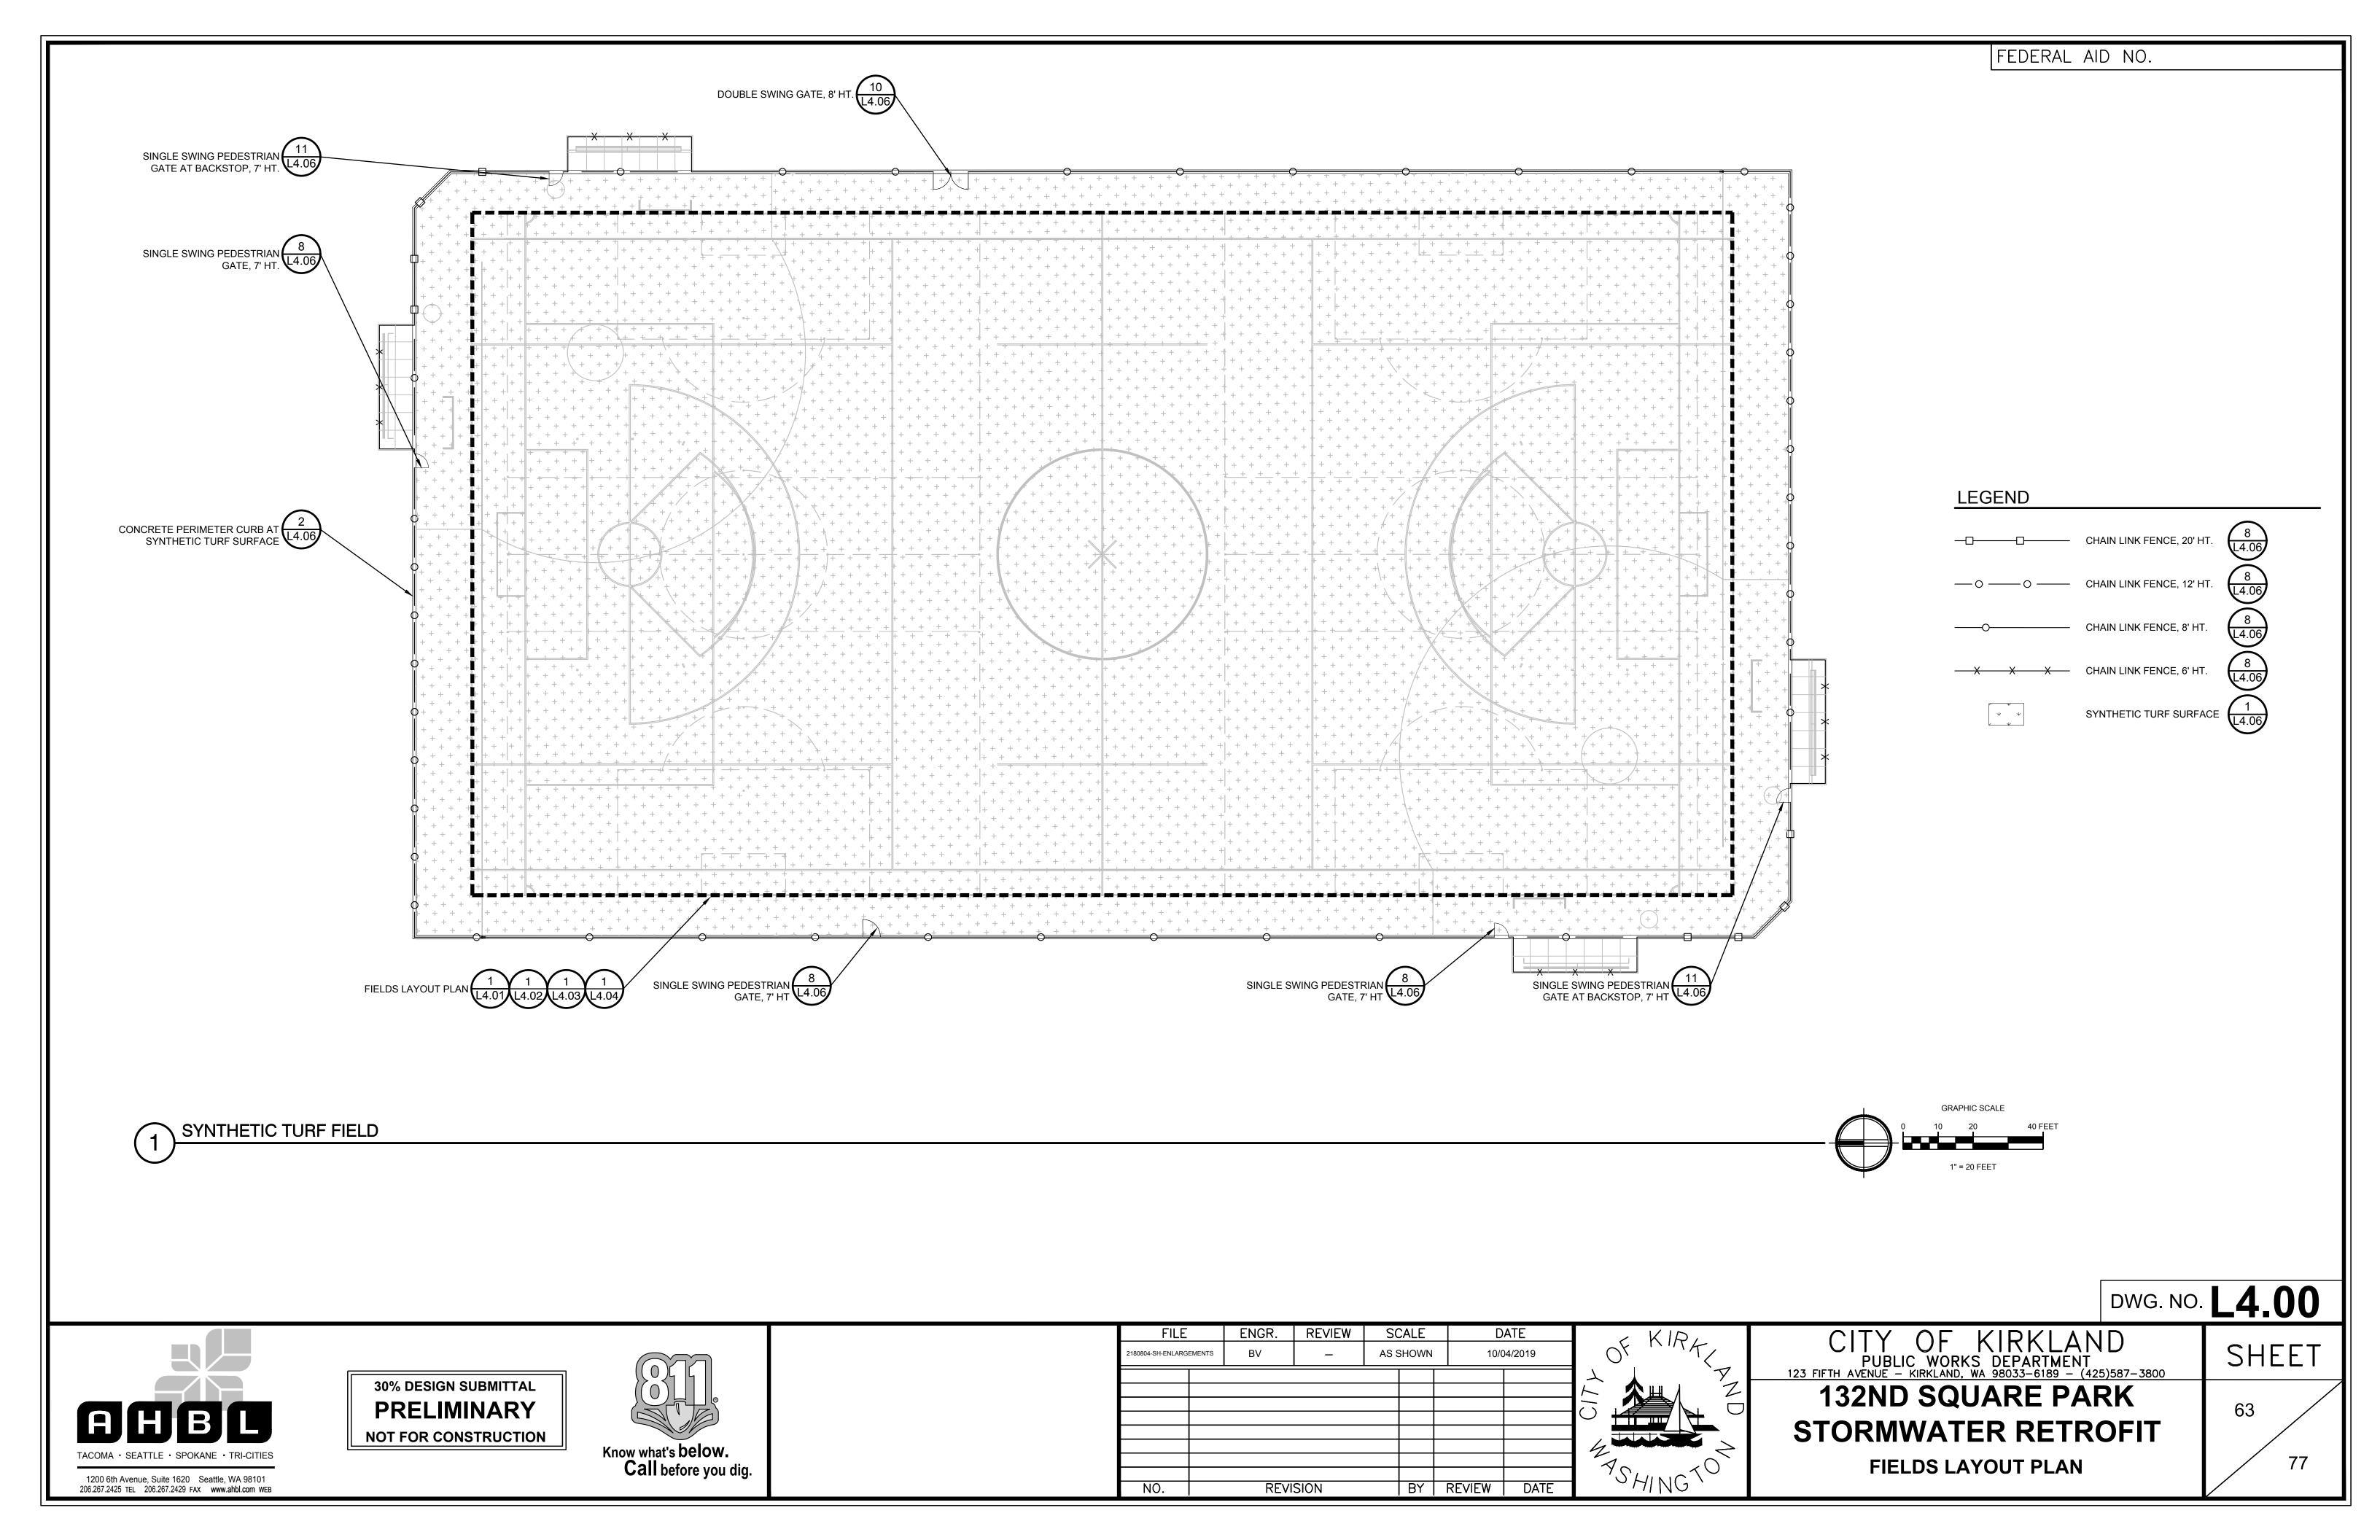
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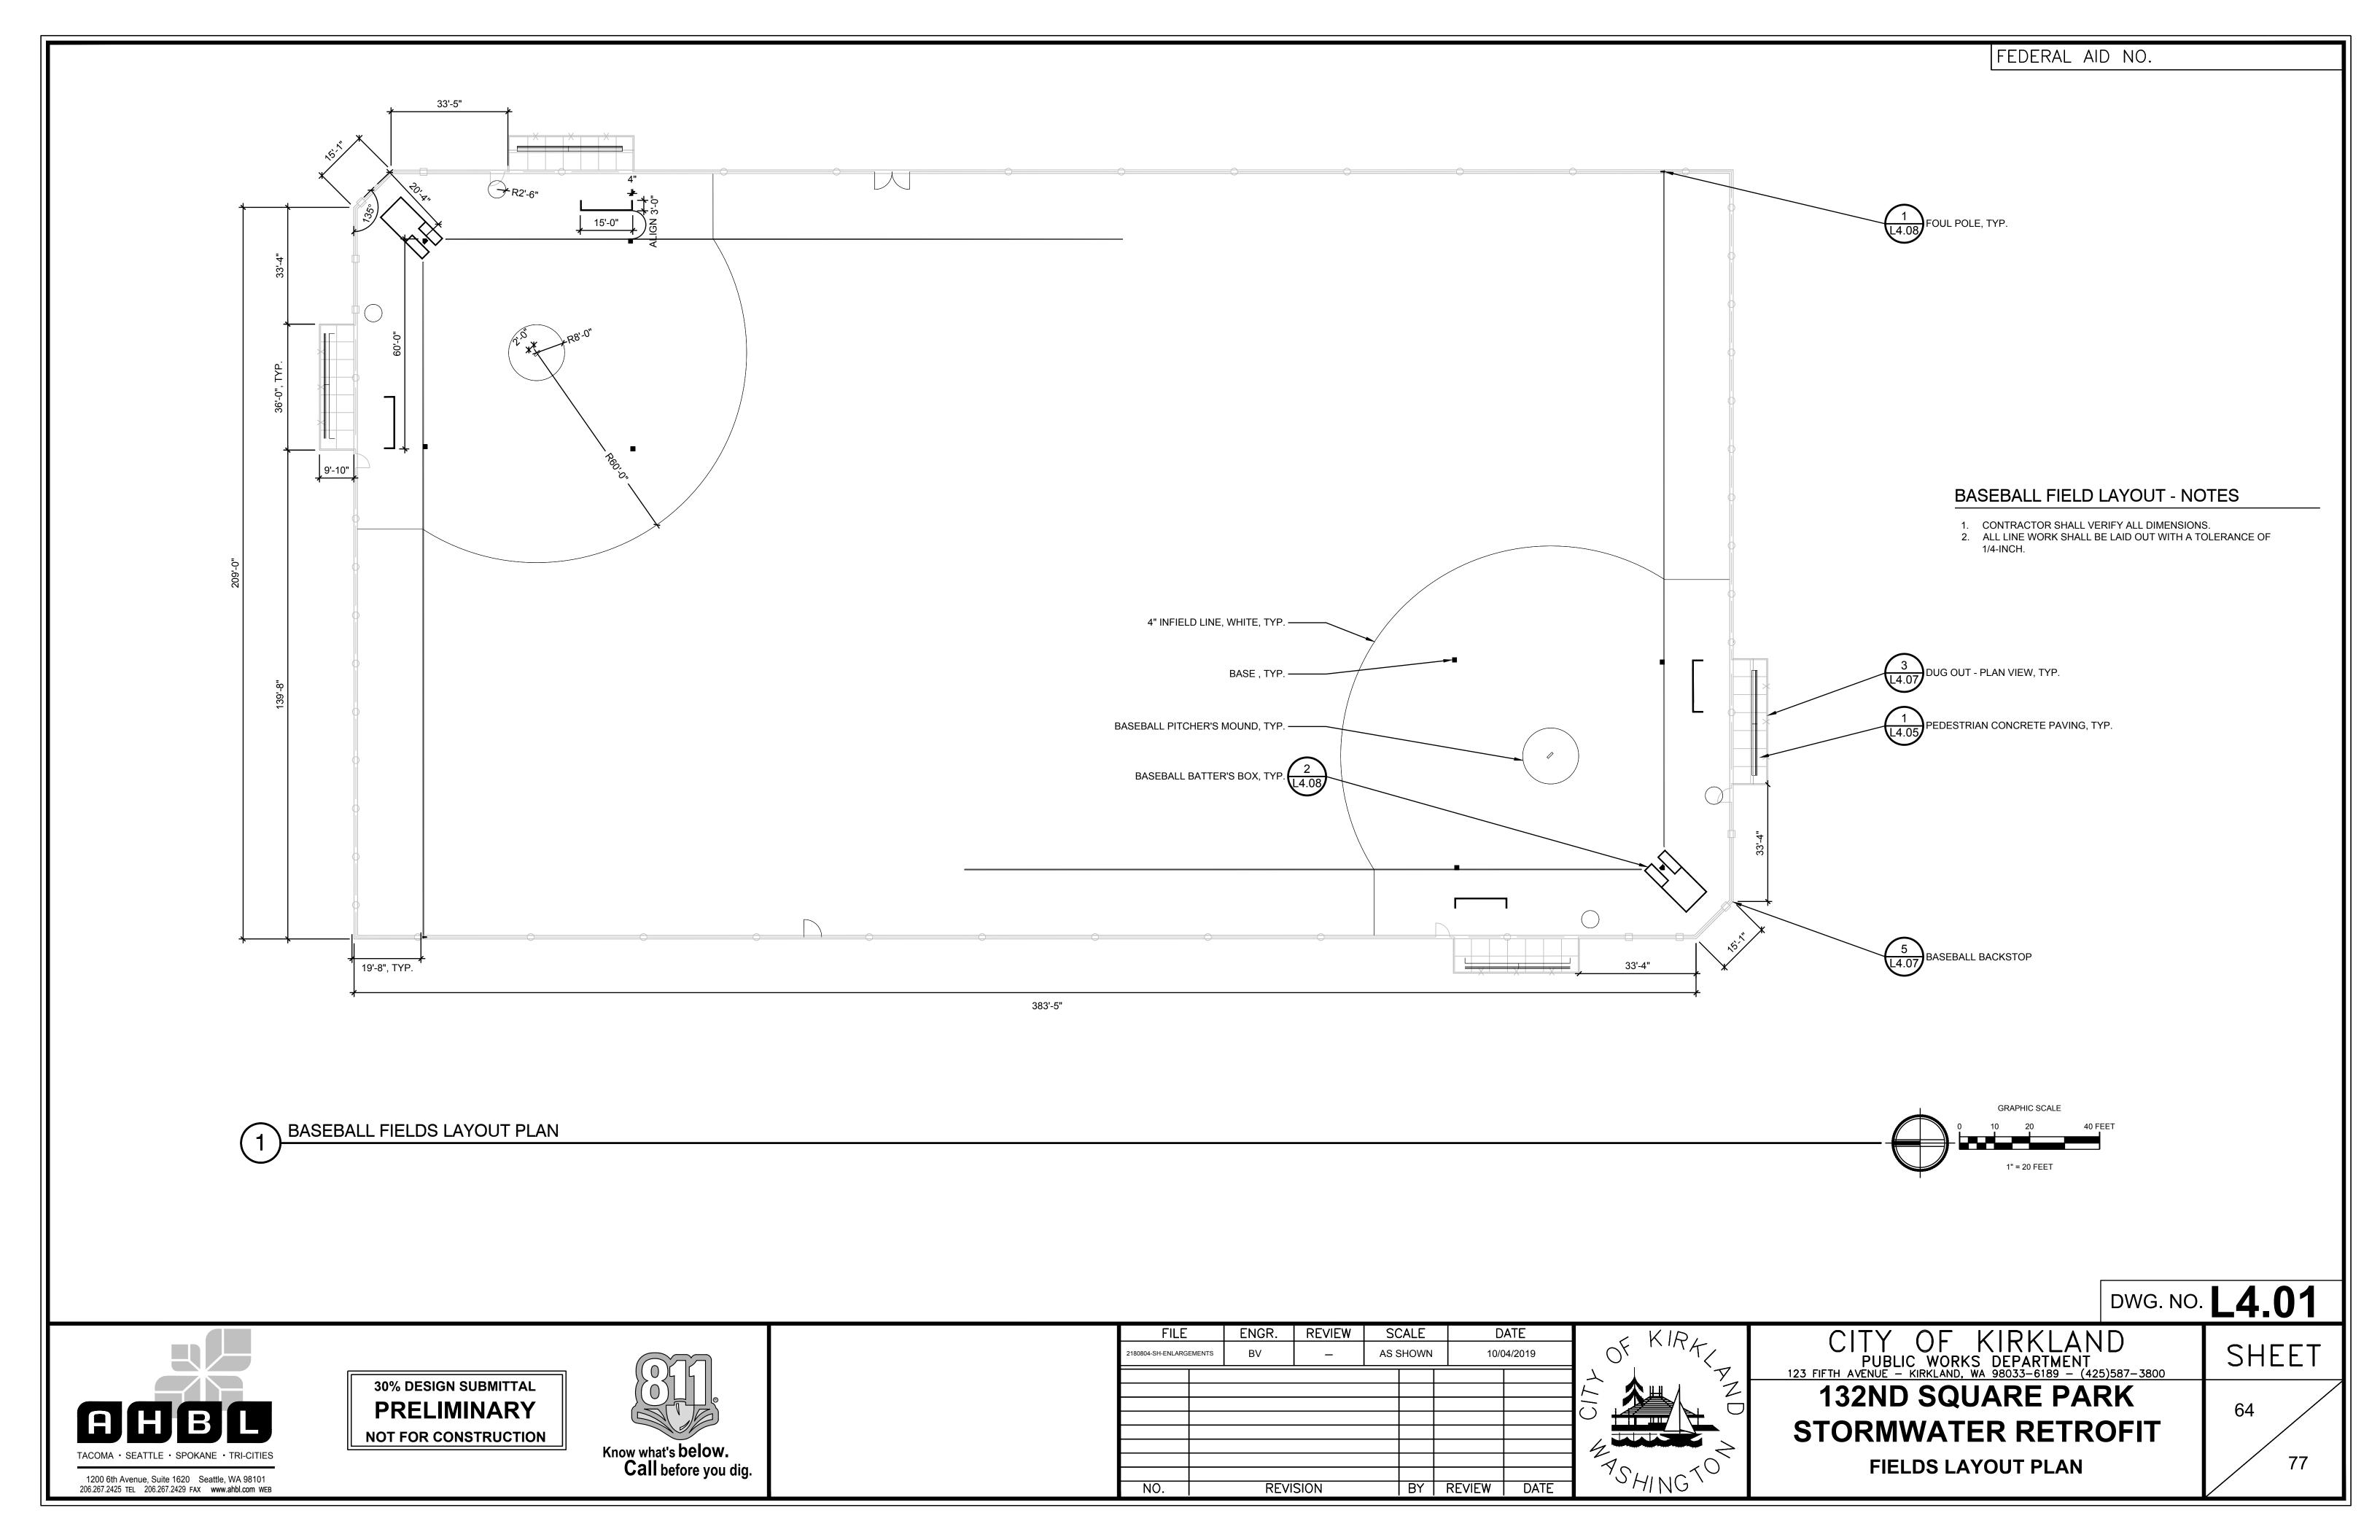


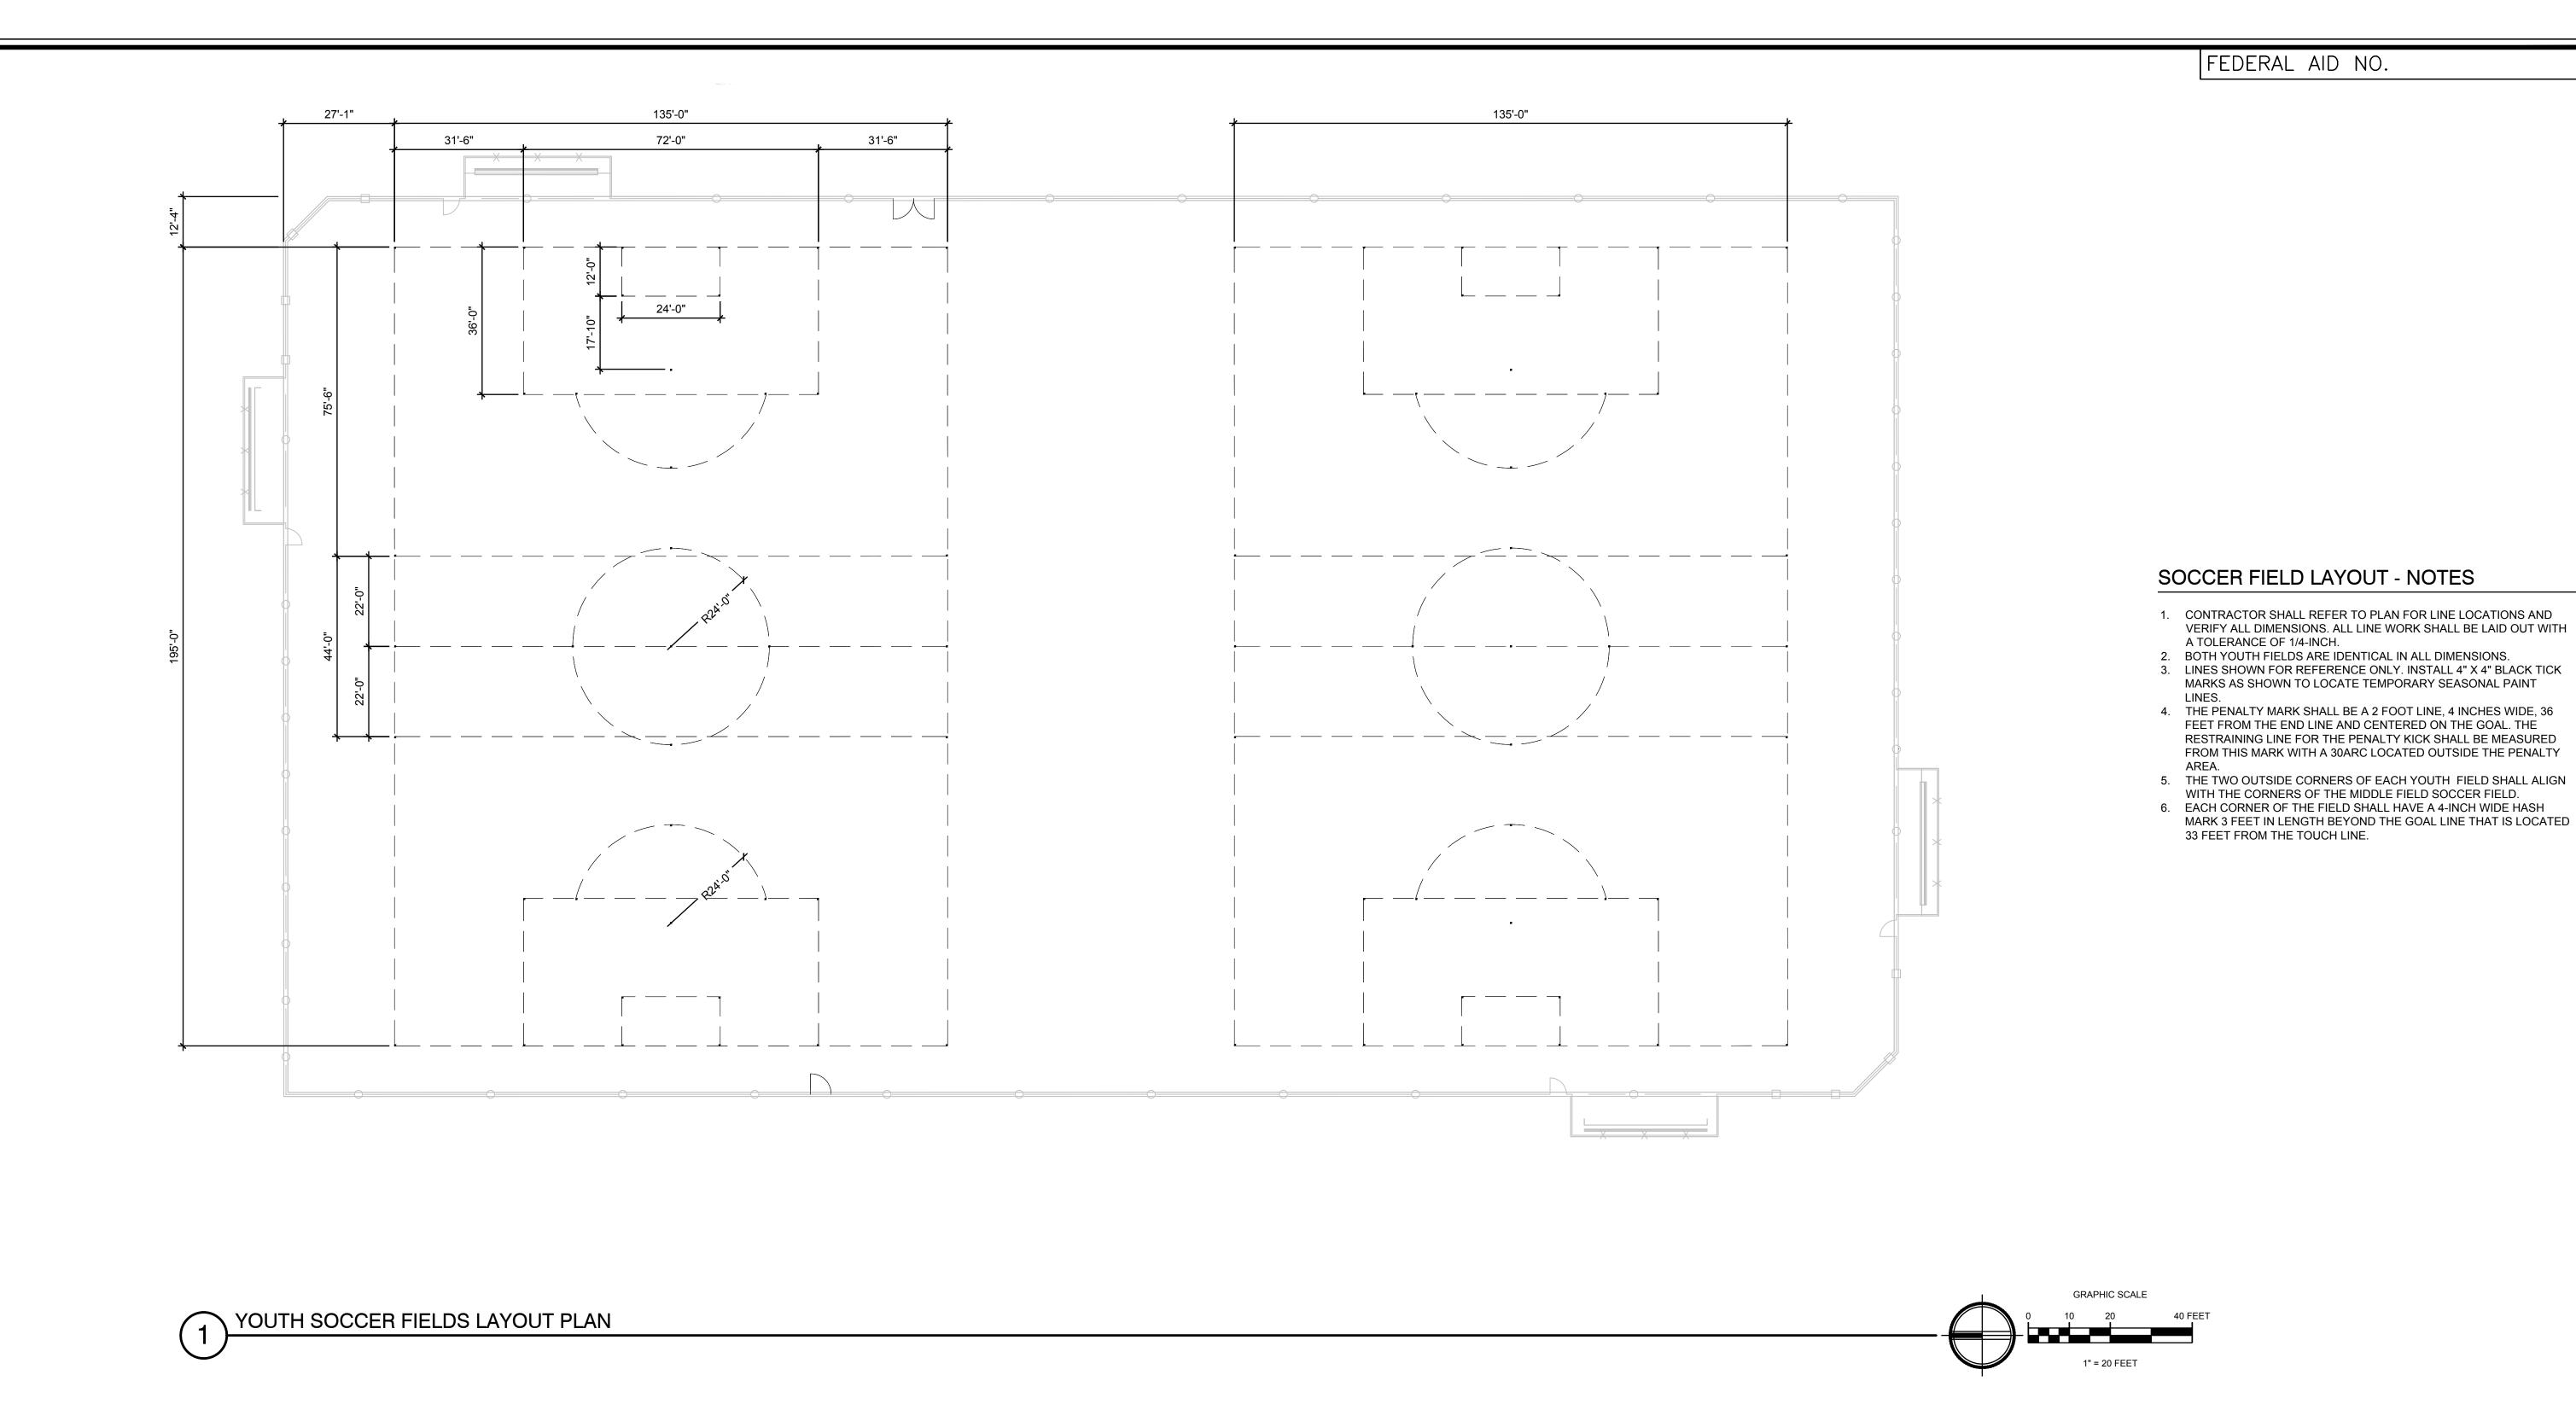
CITY	OF	KIRK	LAND	
PUBLI	C WORK	(S DEPART	MENT	
123 FIFTH AVENUE -	KIRKLAND,	WA 98033-618	<u> 39 – (425)587-</u>	<u>-3800</u>
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132ND SQUARE PARK STORMWATER RETROFIT

IRRIGATION PLAN







DWG. NO. **L4.02**

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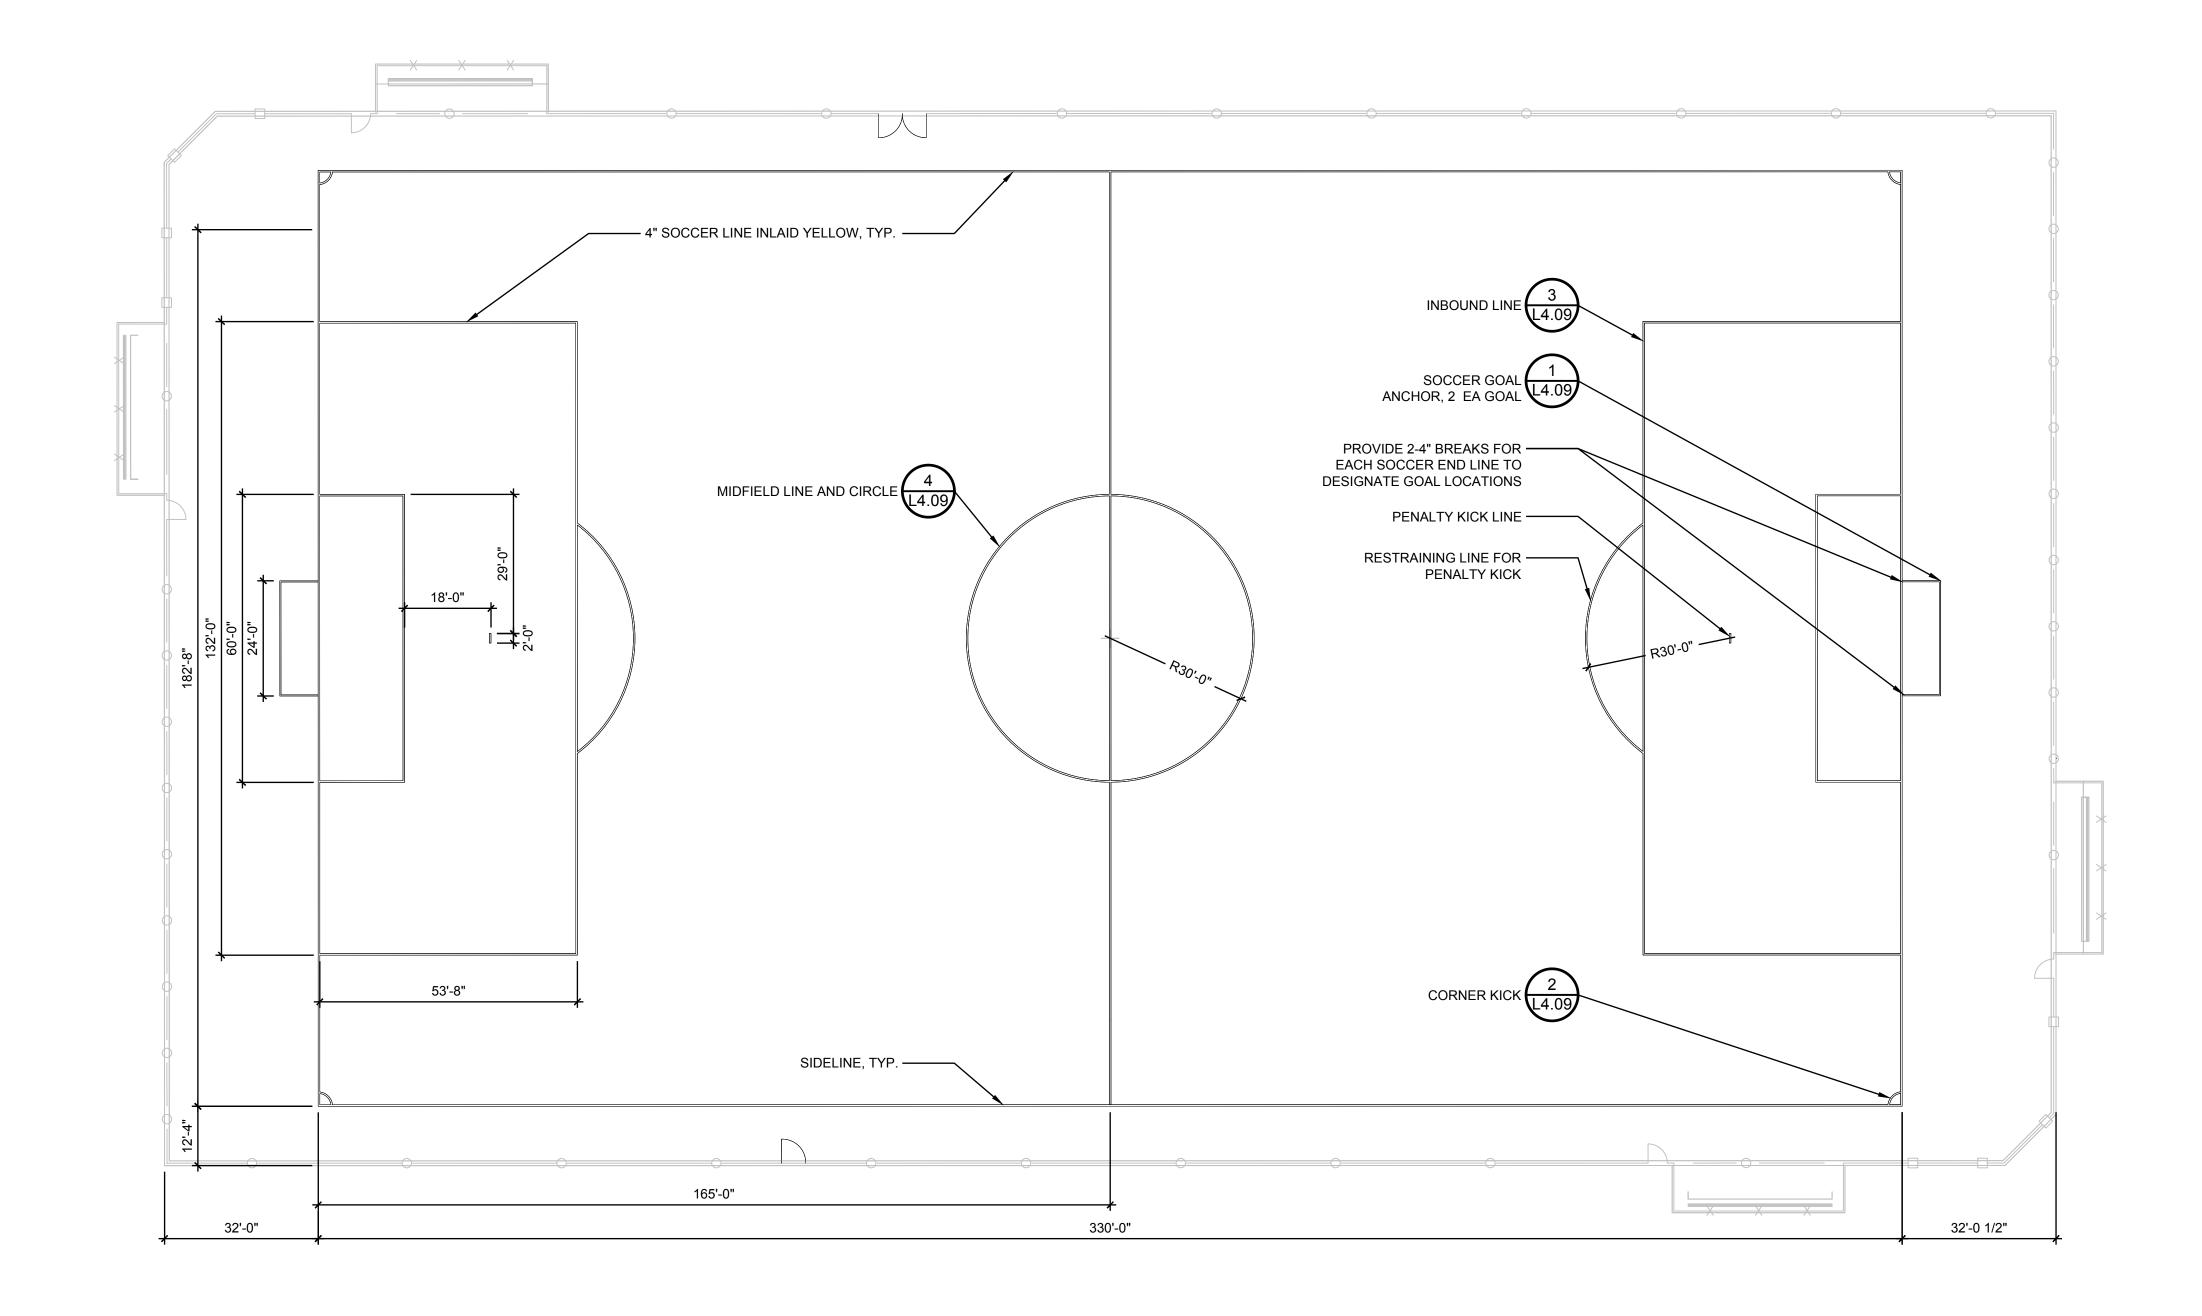
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PUBLIC WORKS DEPARTMENT

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122ND SOUADE DADK

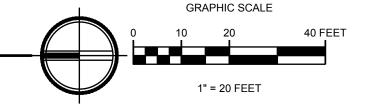
132ND SQUARE PARK
STORMWATER RETROFIT
FIELDS LAYOUT PLAN



SOCCER FIELD LAYOUT - NOTES

- CONTRACTOR SHALL REFER TO PLAN FOR LINE LOCATIONS AND VERIFY ALL DIMENSIONS. ALL LINE WORK SHALL BE LAID OUT WITH A TOLERANCE OF 1/4-INCH.
- 2. THE SOCCER GOAL AREA SHALL MEASURE 18 FEET BY 60 FEET AND THE SOCCER PENALTY AREA SHALL BE 54 FEET BY 132 FEET
- 3. THE PENALTY MARK SHALL BE A 2 FOOT LINE, 4 INCHES WIDE, 36 FEET FROM THE END LINE AND CENTERED ON THE GOAL. THE RESTRAINING LINE FOR THE PENALTY KICK SHALL BE MEASURED FROM THIS MARK WITH A 30'ARC LOCATED OUTSIDE THE PENALTY AREA.
- 4. THE HALFWAY LINE FOR THE SOCCER FIELD SHALL BE A 4-INCH YELLOW INLAID LINE WITH A 60 FOOT DIAMETER CIRCLE IN THE CENTER OF THE FIELD.
- 5. EACH CORNER OF THE SOCCER FIELD SHALL HAVE A 3 FOOT RADIUS INLAID WITH 4 INCHES OF YELLOW TURF TO DESIGNATE THE CORNER KICK AREA.
- 6. EACH CORNER OF THE FIELD SHALL HAVE A 4-INCH WIDE HASH MARK 3 FEET IN LENGTH BEYOND THE GOAL LINE THAT IS LOCATED 33 FEET FROM THE TOUCH LINE.

SOCCER FIELD LAYOUT PLAN



TACOMA · SEATTLE · SPOKANE · TRI-CITIES

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DWG. NO. **L4.03**CITY OF KIRKLAND

PUBLIC WORKS DEPARTMENT

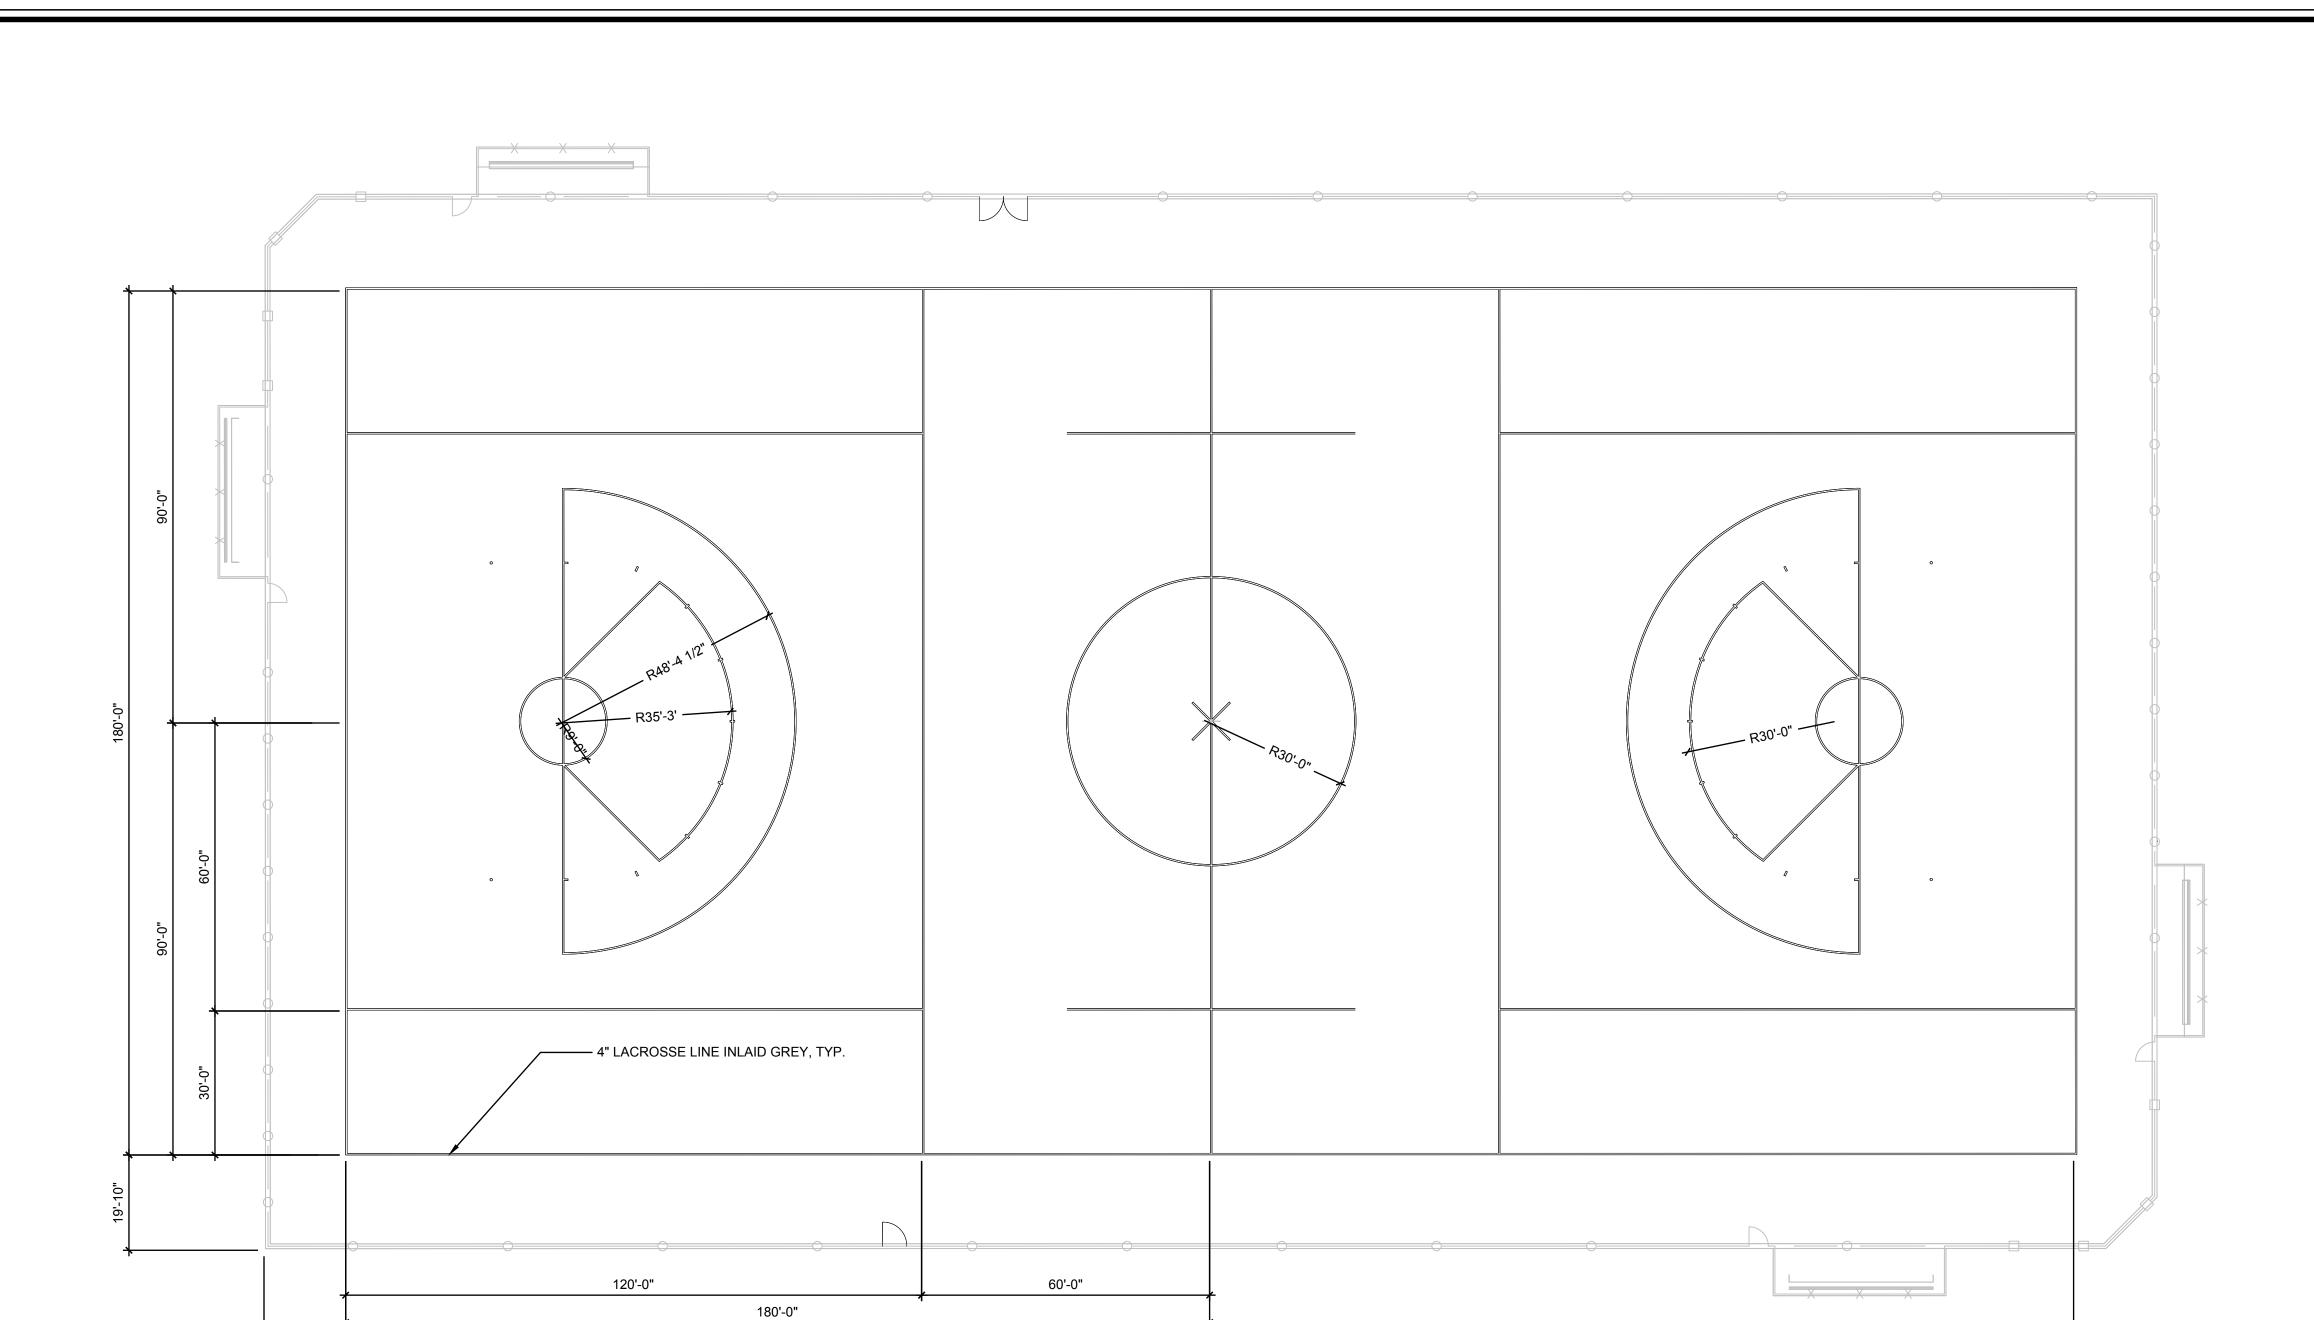
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DWG. NO. **L4.03**SHEET

132ND SQUARE PARK
STORMWATER RETROFIT

FIELDS LAYOUT PLAN

66



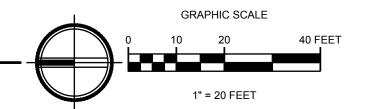
360'-0"

FEDERAL AID NO.

LACROSSE FIELD LAYOUT - NOTES

- CONTRACTOR SHALL VERIFY ALL DIMENSIONS PER US LACROSSE UNIFIED HS FIELD STANDARDS.
 ALL LINE WORK SHALL BE LAID OUT WITH A TOLERANCE OF 1/4-INCH.
 MID-FIELD LINES SHALL BE HELD 1'0" FROM THE SCHOOL LOGO.
 ALL LACROSSE FIELD LINES SHALL BE 4-INCH TUFTED INTO TURF PANELS.

LACROSSE - UNIFIED GIRLS AND BOYS FIELD LAYOUT PLAN



DWG. NO. **L4.04**



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17'-0"

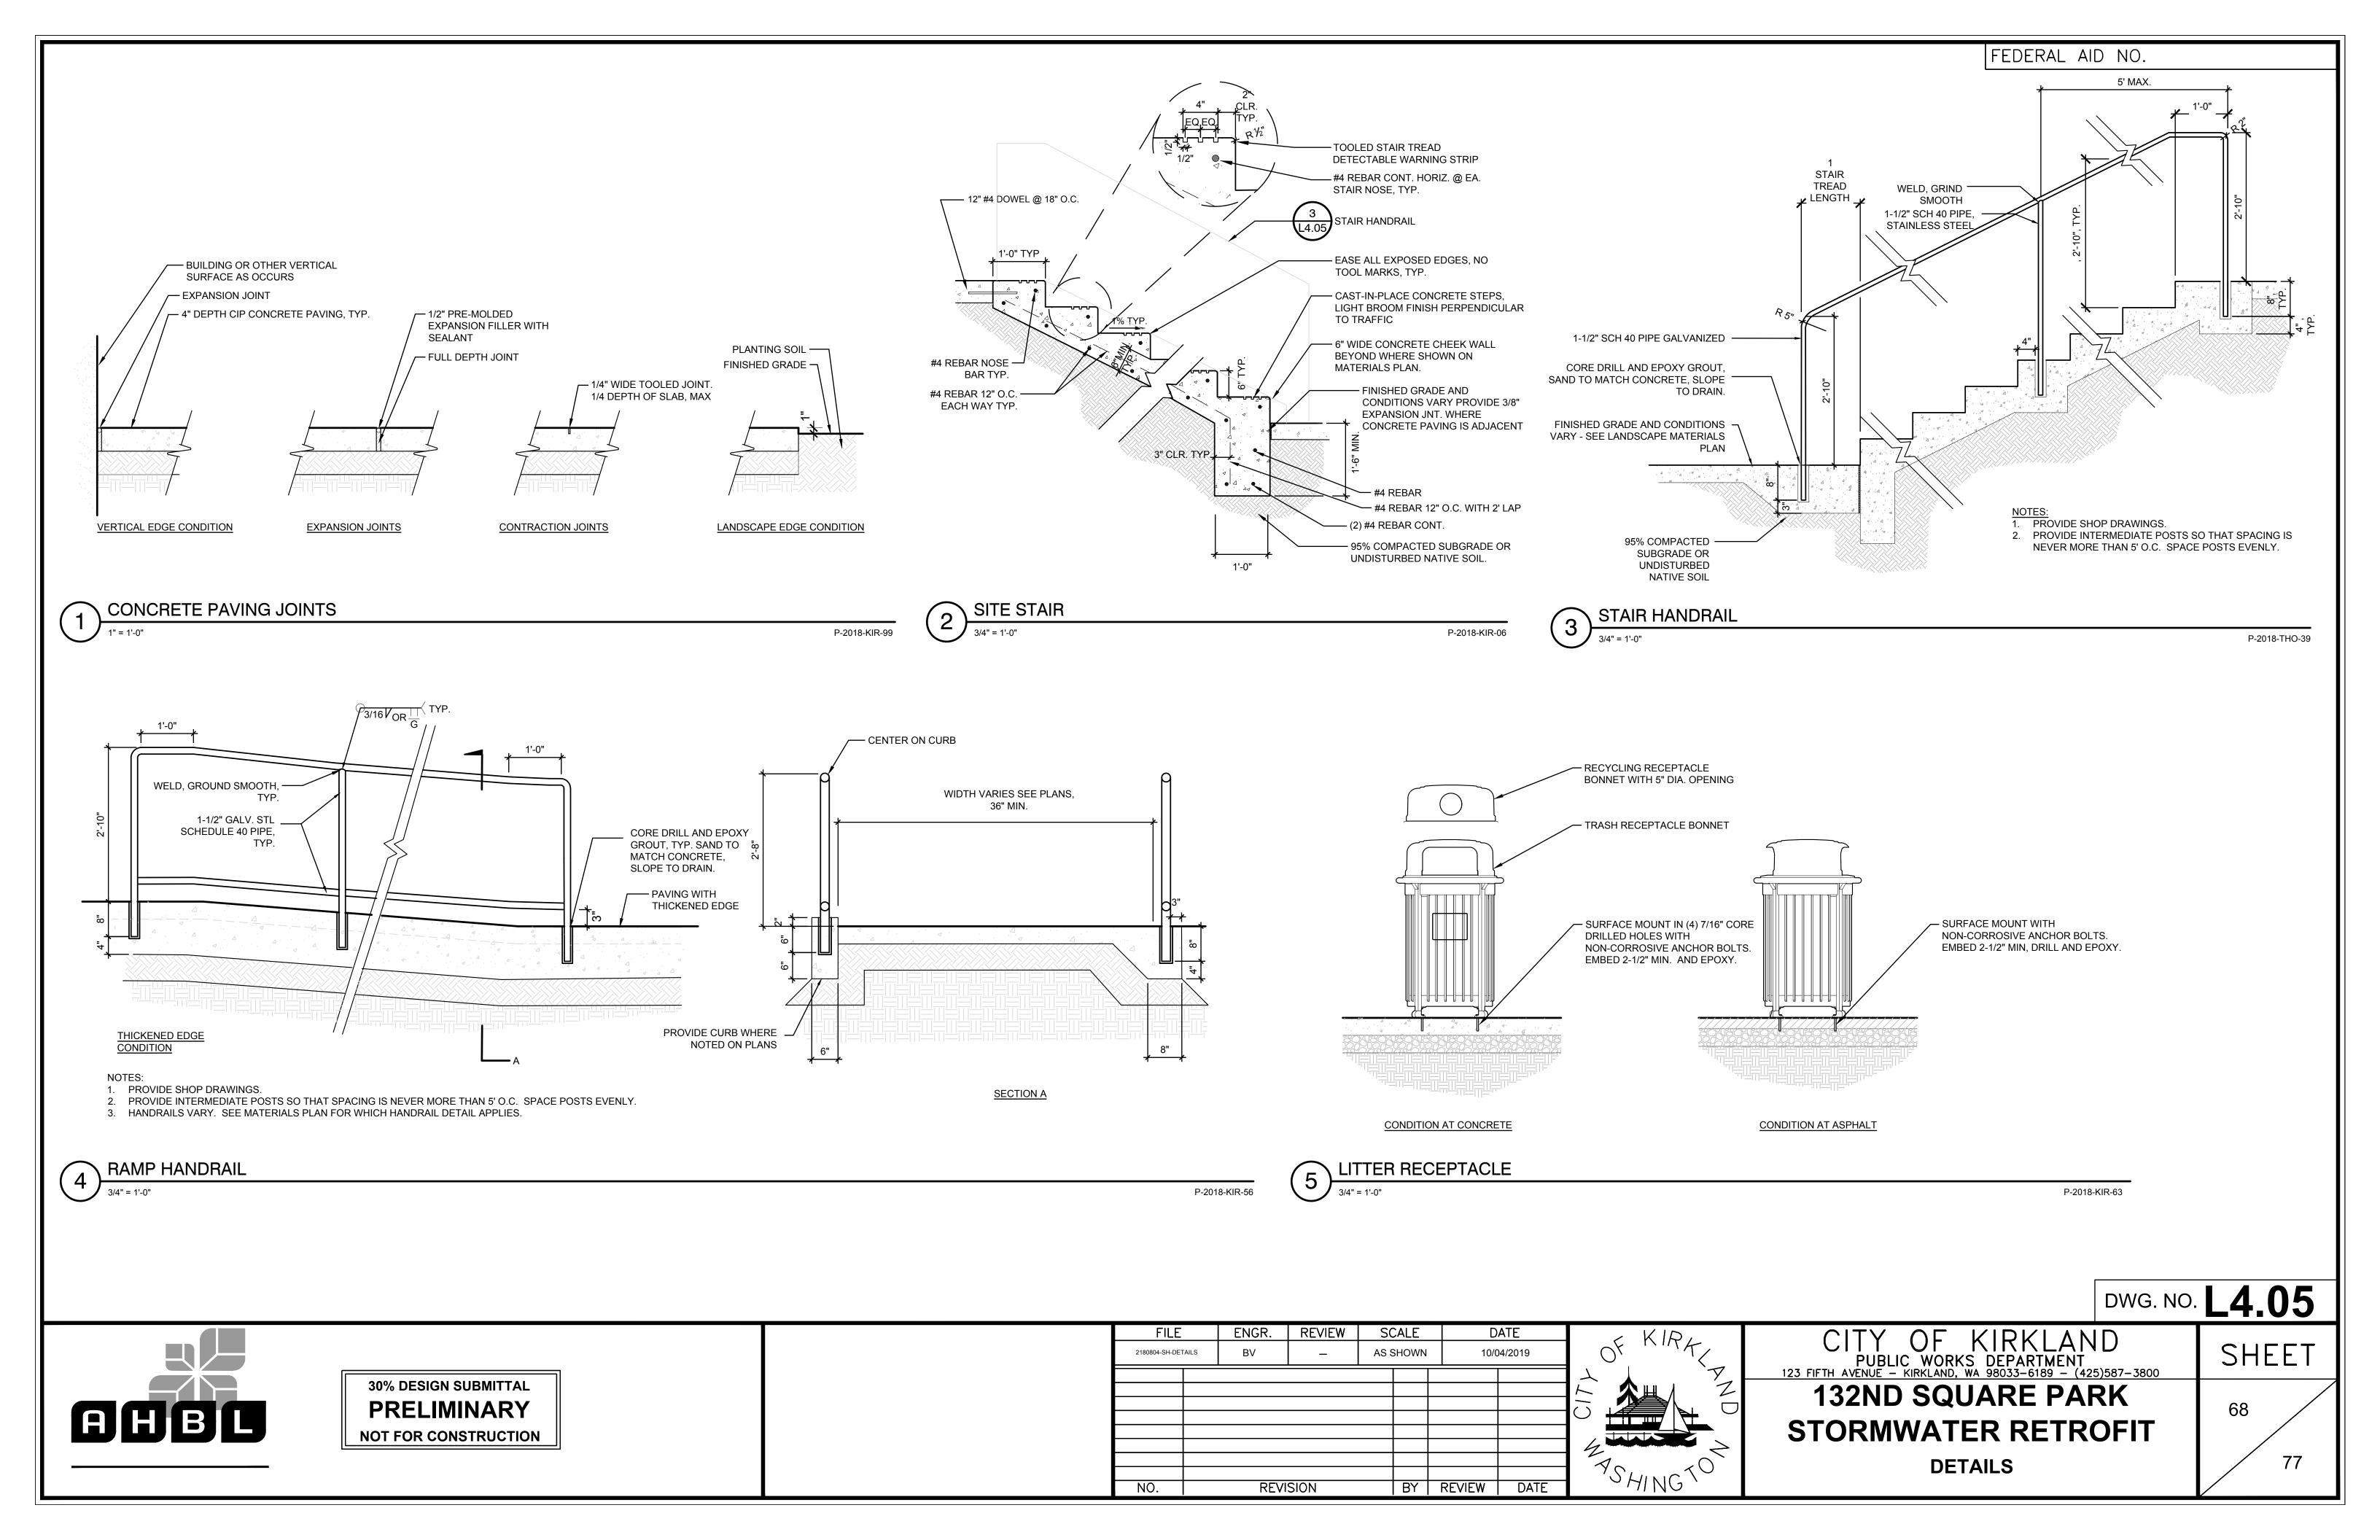


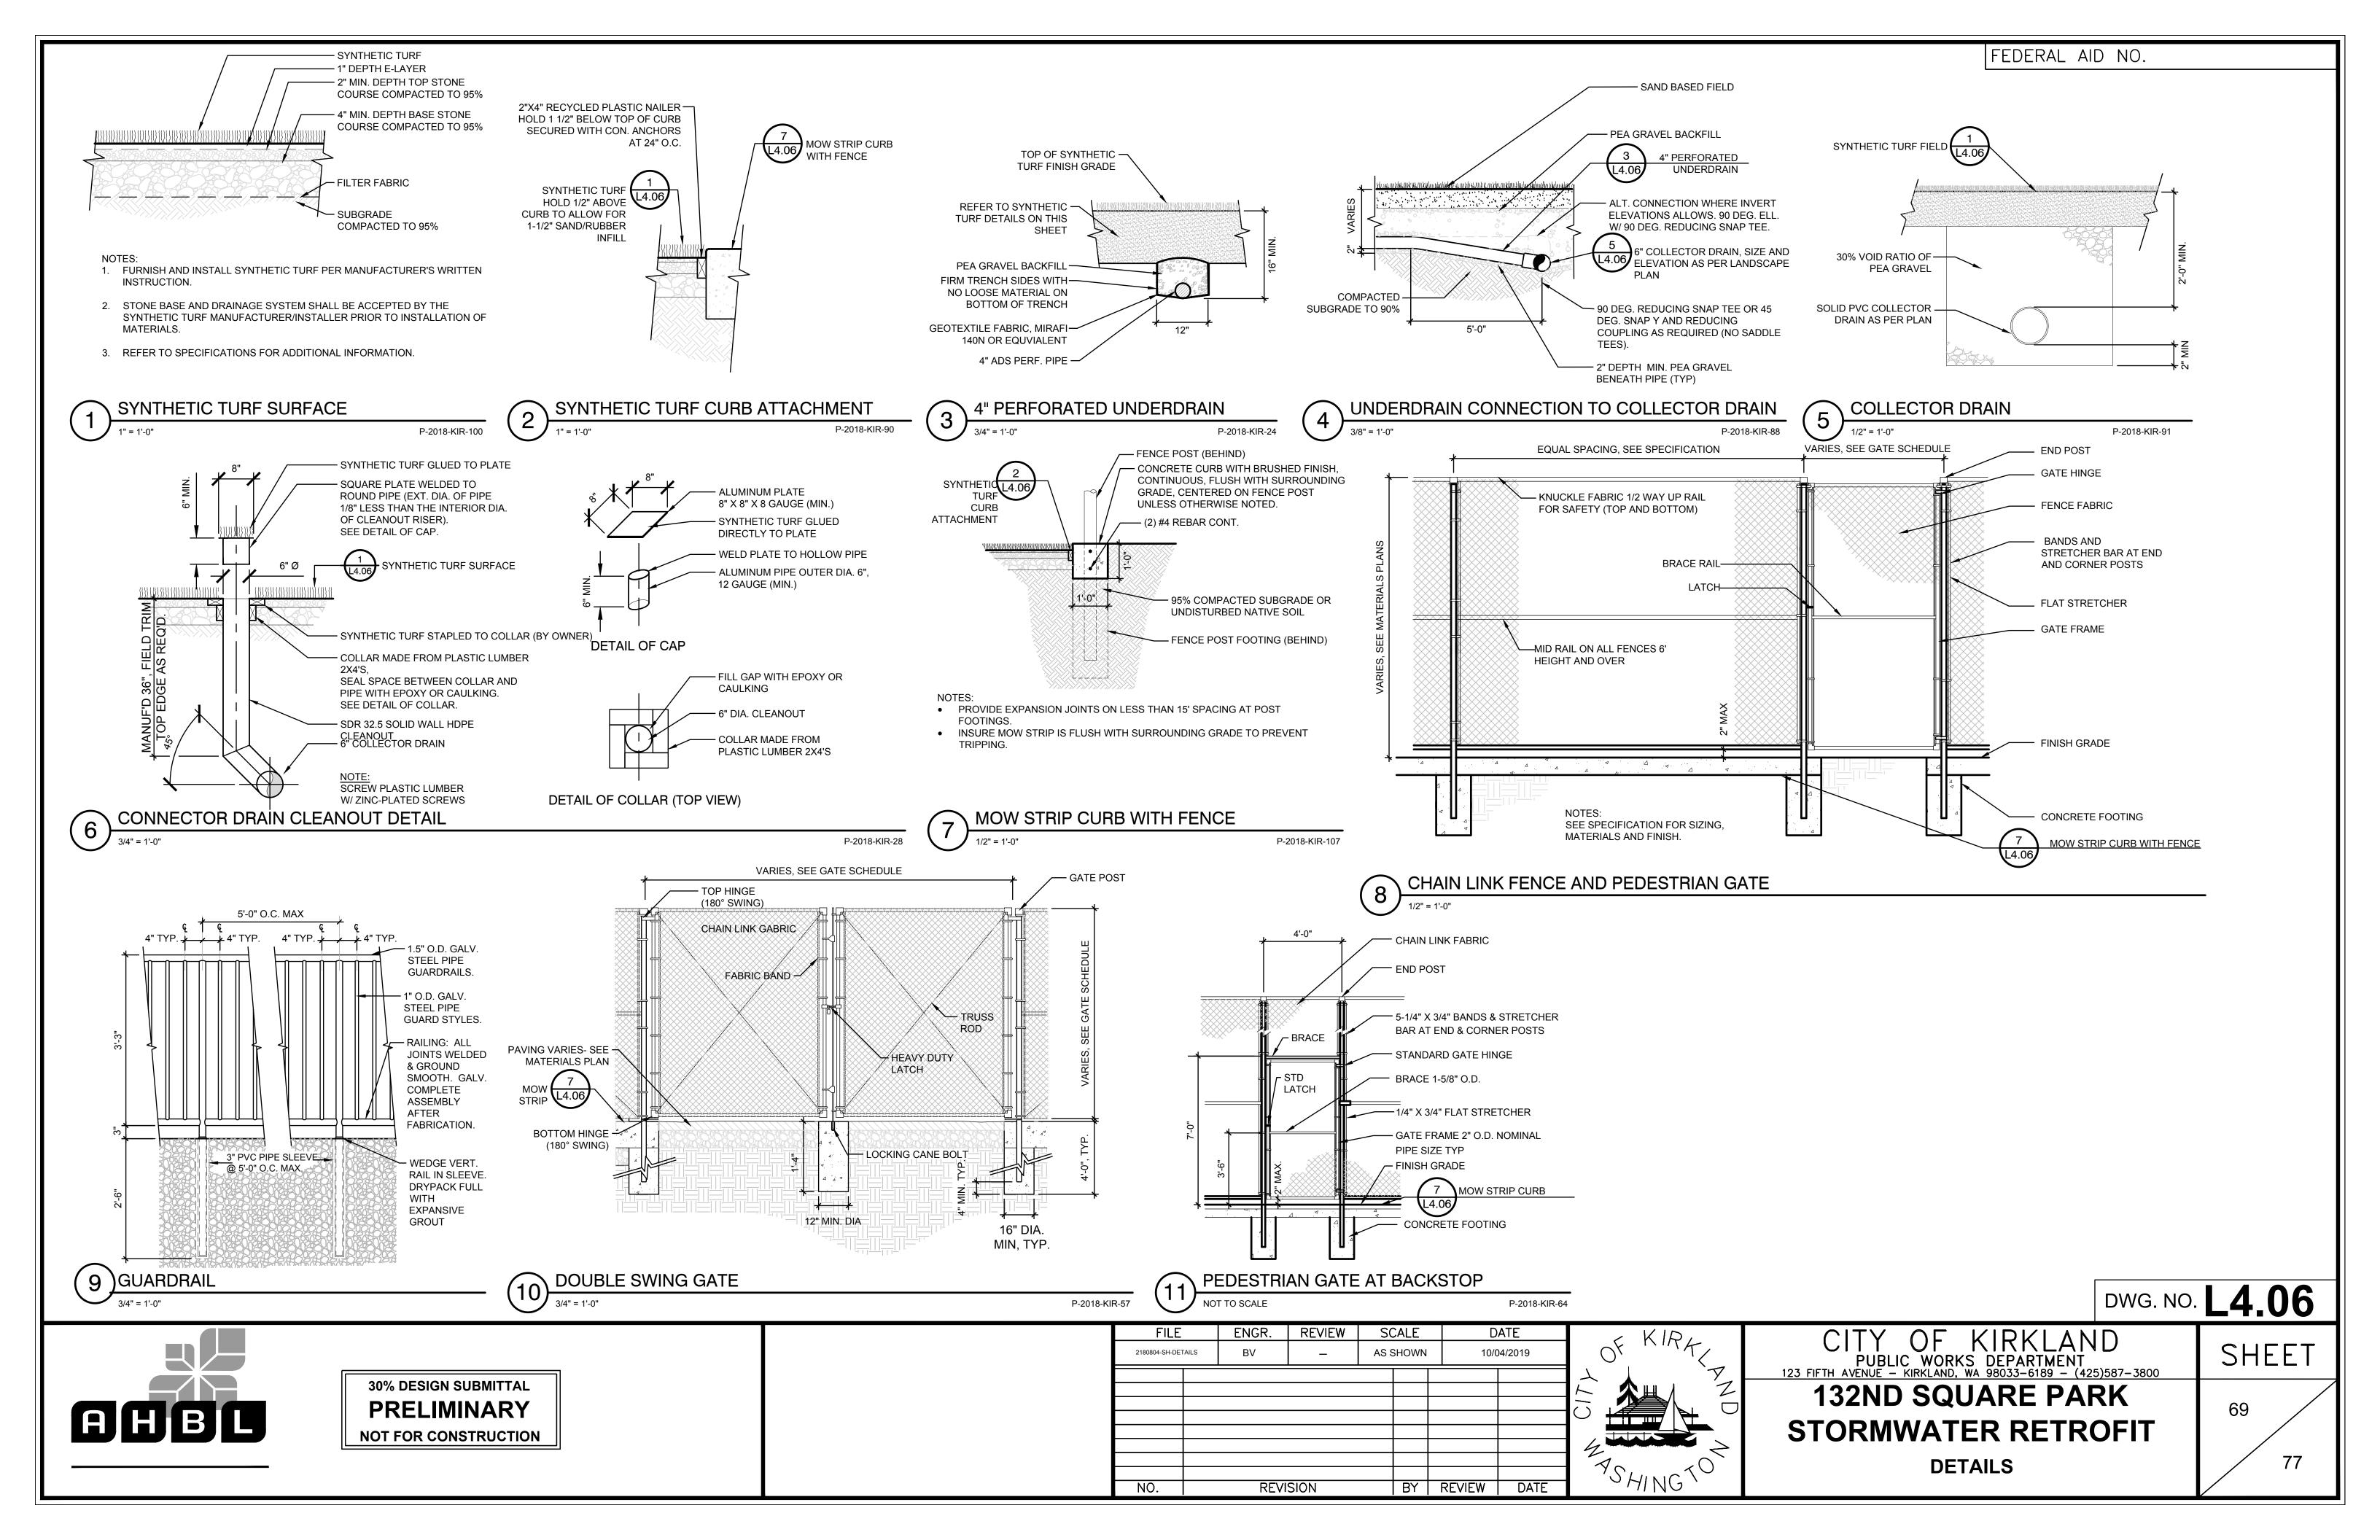
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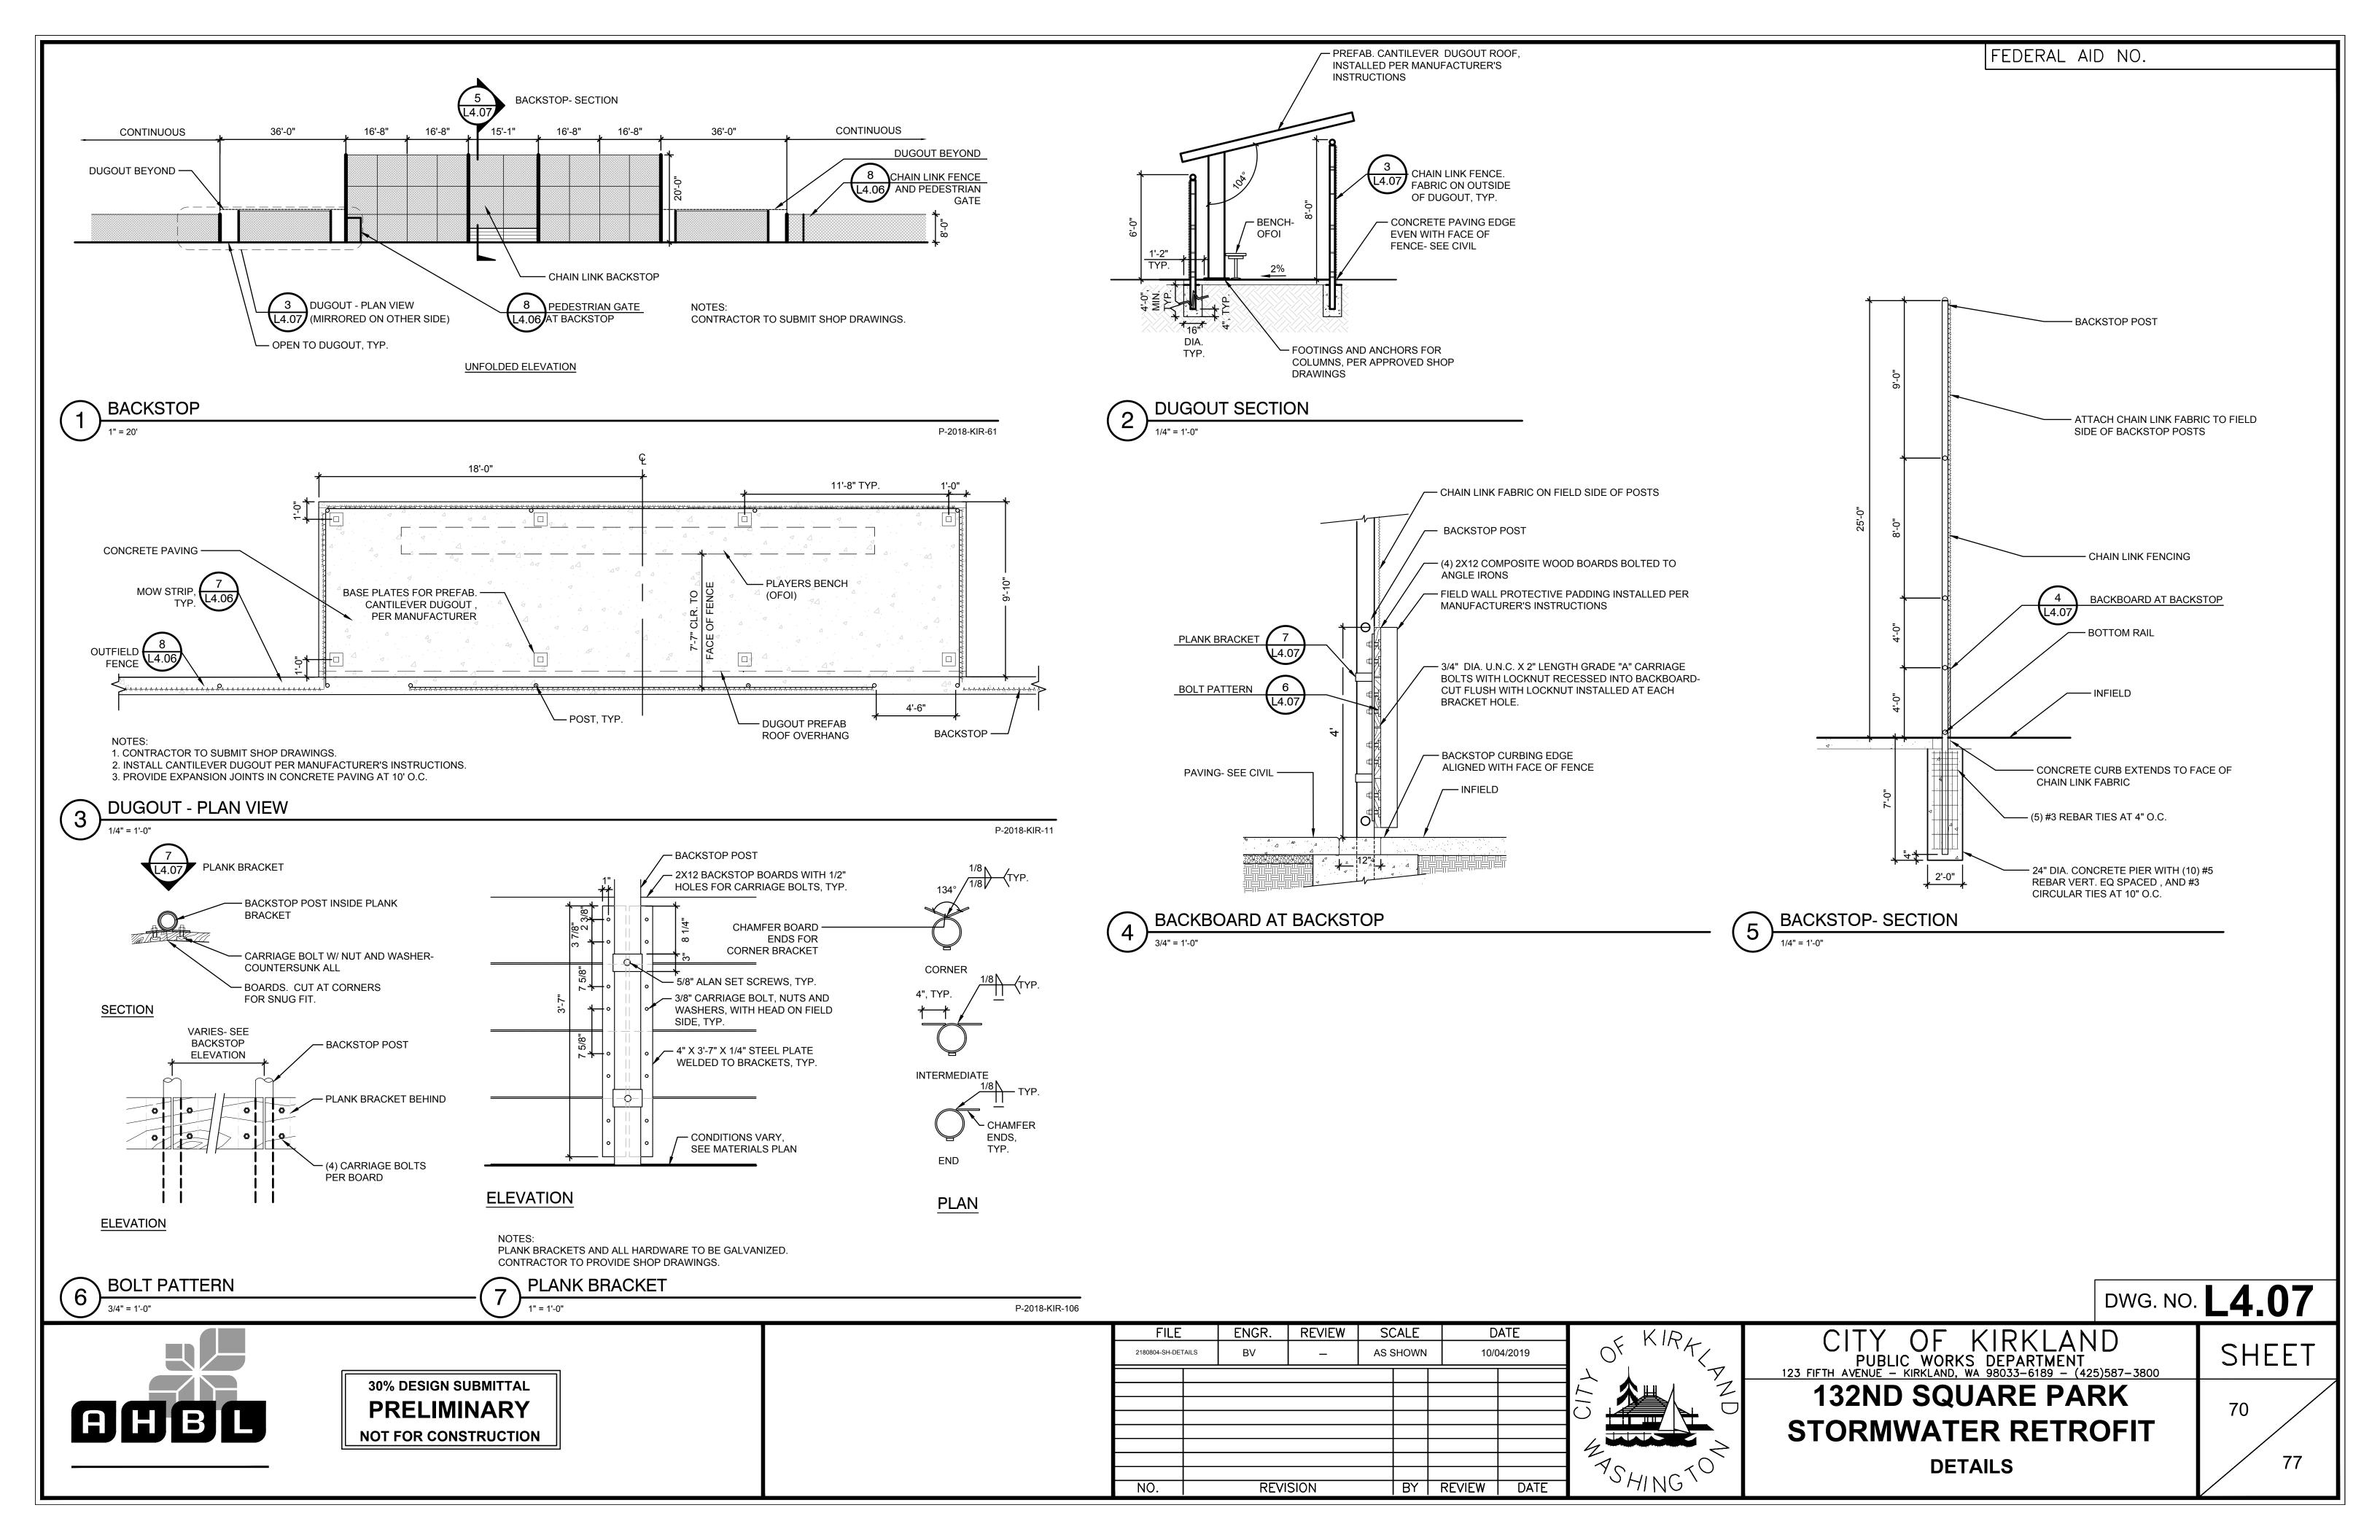


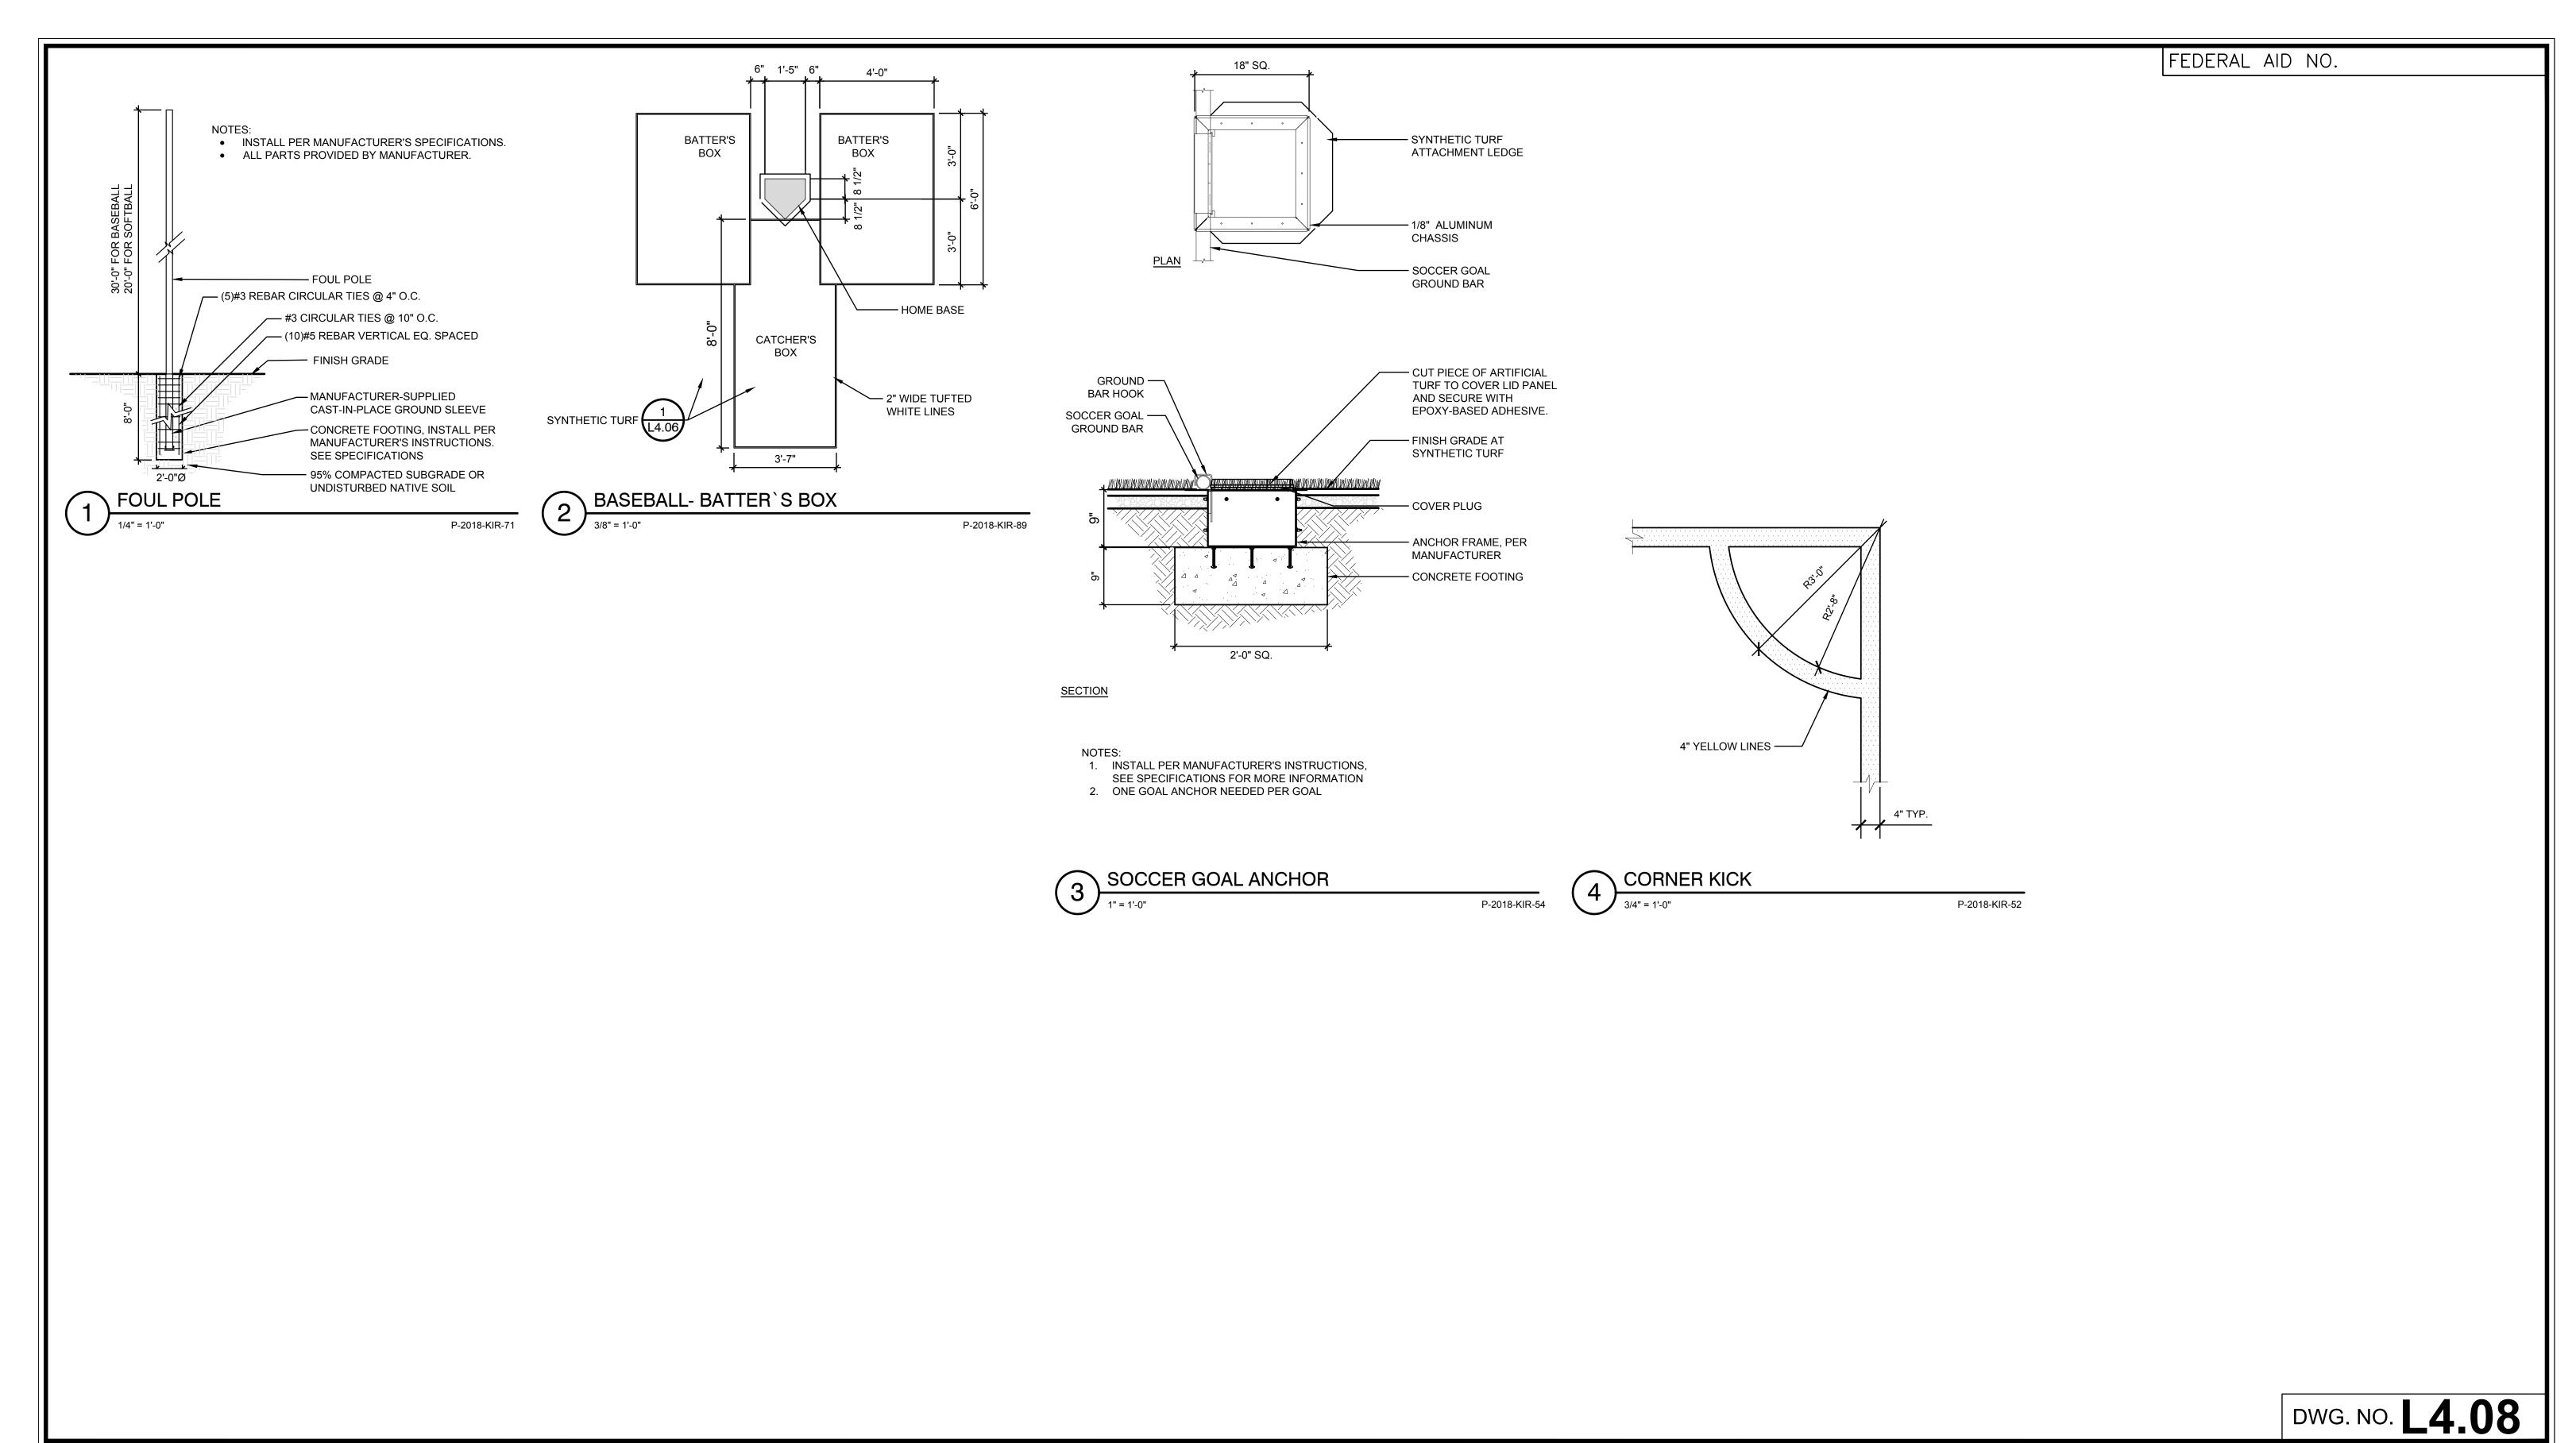
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132ND SQUARE PARK

STORMWATER RETROFIT FIELDS LAYOUT PLAN









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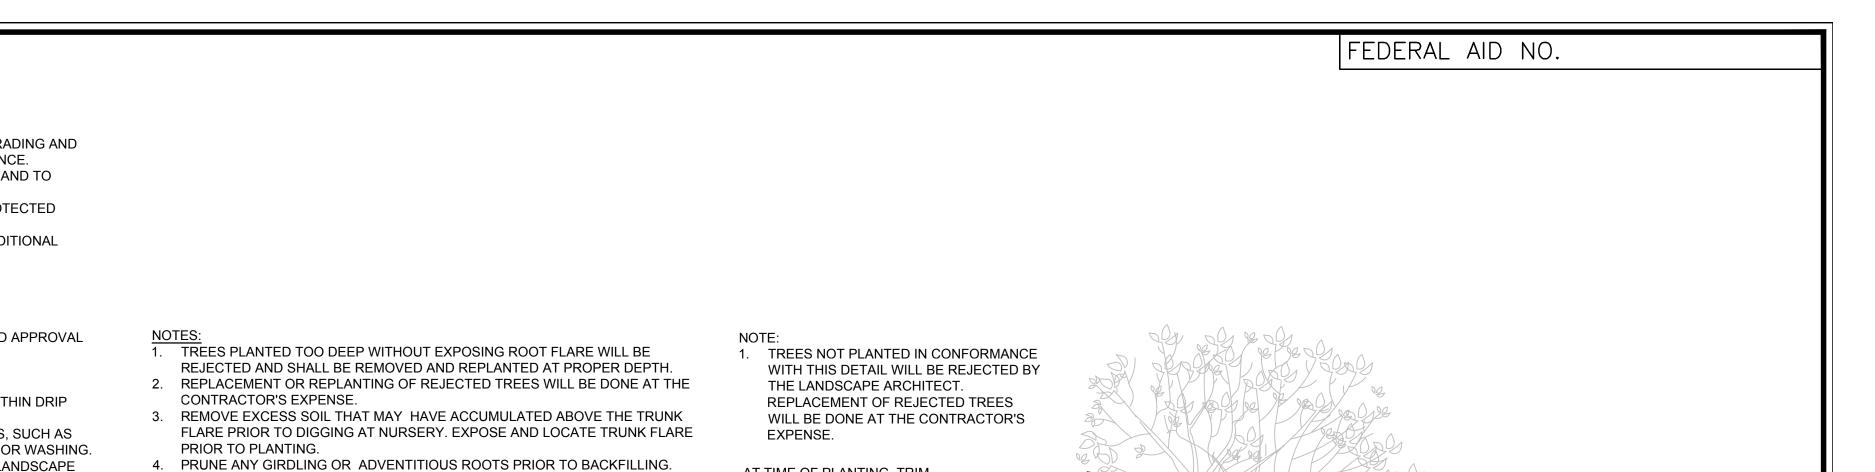


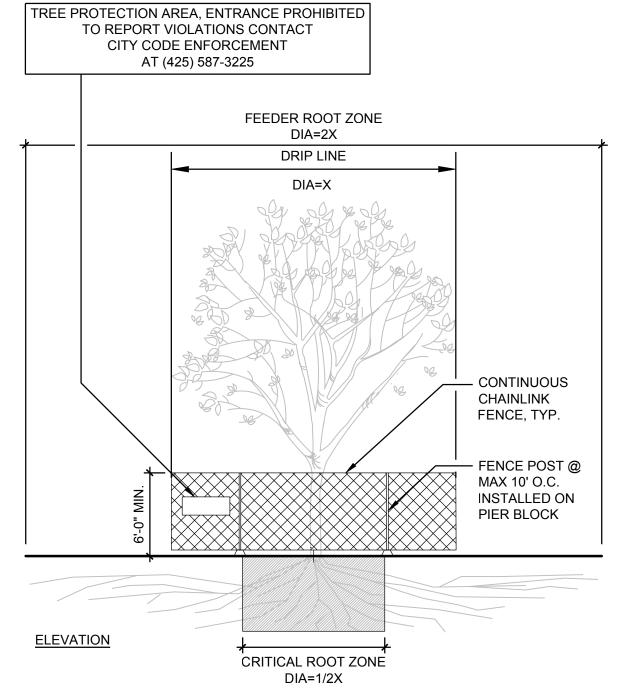
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132ND SQUARE PARK
STORMWATER RETROFIT

SHEET 71 77

DETAILS





1. FENCING TO BE PROVIDED AND MAINTAINED AT CANOPY DRIP LINE.

TREE PROTECTION FENCE SHOULD BE MAINTAINED THROUGHOUT GRADING AND

CONSTRUCTION AND SHALL NOT BE REMOVED UNTIL FINAL ACCEPTANCE.

3. ALL BRUSH CLEANUP WITHIN DRIP LINE SHOULD BE COMPLETED BY HAND TO PREVENT DISTURBANCE OF NATIVE GROUND COVERS.

4. NO WIRES, CABLES, OR OTHER DEVICES SHALL BE ATTACHED TO PROTECTED TREES DURING CONSTRUCTION.

CONTRACTOR SHALL REFER TO PLANS AND SPECIFICATIONS FOR ADDITIONAL INFORMATION.

TRENCHING/EXCAVATION

FENCING/ROOT PROTECTION

CRITICAL ROOT ZONE

1. NO DISTURBANCE ALLOWED WITHOUT SITE-SPECIFIC INSPECTION AND APPROVAL OF METHODS TO MINIMIZE ROOT DAMAGE.

1. LANDSCAPE ARCHITECT'S APPROVAL REQUIRED FOR USE/ACCESS WITHIN DRIP

2. NO SOIL DISTURBANCE OR ACTIVITY ALLOWED WITHIN FENCED AREAS, SUCH AS MATERIAL STORAGE/STOCKPILING, PARKING, EXCAVATION, DUMPING OR WASHING.

3. ANY TRENCHING SUBJECT TO FIELD INSPECTION AND APPROVAL BY LANDSCAPE

1. OPERATION OF HEAVY EQUIPMENT AND/OR STOCKPILING OF MATERIALS SUBJECT TO LANDSCAPE ARCHITECT'S APPROVAL.

2. MINIMIZE TRENCH WIDTH WHEN USING HEAVY EQUIPMENT. SURFACE PROTECTION* MEASURES MAY BE REQUIRED.

3. LIMIT ANY DISTURBANCE TO MAXIMUM 1/3 OF FEEDER ROOT ZONE. 4. IF ROOTS GREATER THAN 2 INCH FOUND OUTSIDE OF FENCING, PROTECT BY HAND EXCAVATION AND, IF NECESSARY, CUT CLEANLY AND KEEP MOIST.

5. IF ROOTS GREATER THAN 1 INCH DIAMETER ARE DAMAGED DURING CONSTRUCTION, MAKE A CLEAN STRAIGHT CUT TO REMOVE DAMAGED PORTION OF ROOT. ALL EXPOSED ROOTS SHALL BE TEMPORARILY COVERED WITH DAMP BURLAP TO

PREVENT DRYING AND COVERED WITH SOIL AS SOON AS POSSIBLE. 7. USE 3 INCHES OR DEEPER WOOD CHIP MULCH OUTSIDE FENCED AREAS TO PROTECT FEEDER ROOTS.

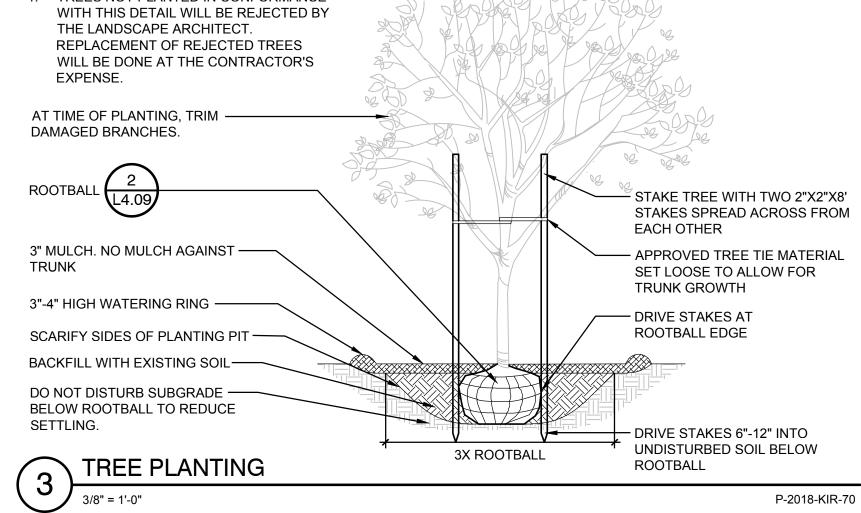
*SURFACE PROTECTION MEASURES

6-8" MULCH LAYER, 3/4"PLYWOOD, OR STEEL PLATES

SIGNAGE AS DETAILED ABOVE TO BE POSTED EVERY 15 FEET ALONG FENCE

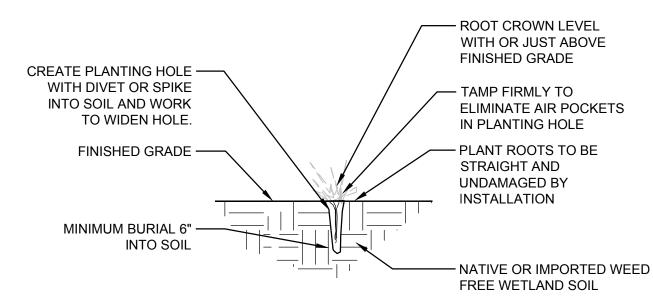
 TRUNK FLARE — BOTTOM OF TRUNK FLARE. LOCATE BOTTOM OF TRUNK FLARE 1" MIN. ABOVE ADJACENT FINISH GRADE. - MULCH LAYER, HOLD OFF FROM TREE TRUNK - FINISH GRADE - REMOVE WIRE BASKET (NO EXCEPTIONS) AND ANY OTHER SYNTHETIC MATERIAL FROM ROOTBALL. CUT BACK AND REMOVE BURLAP FROM TOP AND SIDE OF ROOTBALL. SET BALL ON COMPACTED SOIL MOUND TO PREVENT SETTLING.

P-2018-KIR-65



TREE PROTECTION

SPACING PLAN



RIPARIAN PLUG PLANTING

GROUNDCOVER PLANTING PLAN 1. ALL GROUNDCOVER TO BE PLANTED AT EQUAL TRIANGULAR SPACING PER O.C. SPACING ON LEGEND. SPACING X .86 FOR TRIANGULAR PATTERN FROM CURB SPACING AS SPECIFIED 3" OF MULCH.-NO MULCH AGAINST THE BASE OF THE PLANT BACKFILL WITH **EXCAVATED SOIL** WATER THOROUGHLY. — 2X ROOTBALL ——∤

GROUNDCOVER PLANTING

3" MULCH. NO MULCH AGAINST THE BASE OF THE PLANT BACKFILL WITH EXCAVATED SOIL REMOVE BURLAP FROM TOP AND SIDES OF ROOT BALL DOWN -SCARIFY -INTO GROUND. SET TOP OF BALL SIDES OF FLUSH WITH FINISH GRADE. PLANTING PIT LOOSEN / PULL OUT ROOTS-FROM CONTAINER GROWN PLANTS SHRUB PLANTING

P-2018-KIR-72

INSTALL EDGING PER MANUFACTURER'S SPECIFICATIONS WITH TOP OF EDGING 1/4" TO 1/2" ABOVE COMPACTED FINISH GRADE (TURF SIDE). **CONDITIONS VARY** SEE PLAN SHRUB SIDE TOP OF SUBGRADE 3/16" X 4" STEEL EDGING COLOR SHALL BE BLACK COMPACT SUBGRADE ON EITHER SIDE OF EDGING TO MAINTAIN STABILITY STAKE AT ALL CURVE RETURNS, **CURVE MIDPOINTS, AND AT 36"** O.C. MIN.

DETAIL-FILE

P-2018-KIR-68

P-2018-KIR-76

P-2018-KIR-73

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REVIEW SCALE ENGR. DATE FILE AS SHOWN 10/04/2019 2180804-SH-DETAILS REVISION BY REVIEW DATE NO.

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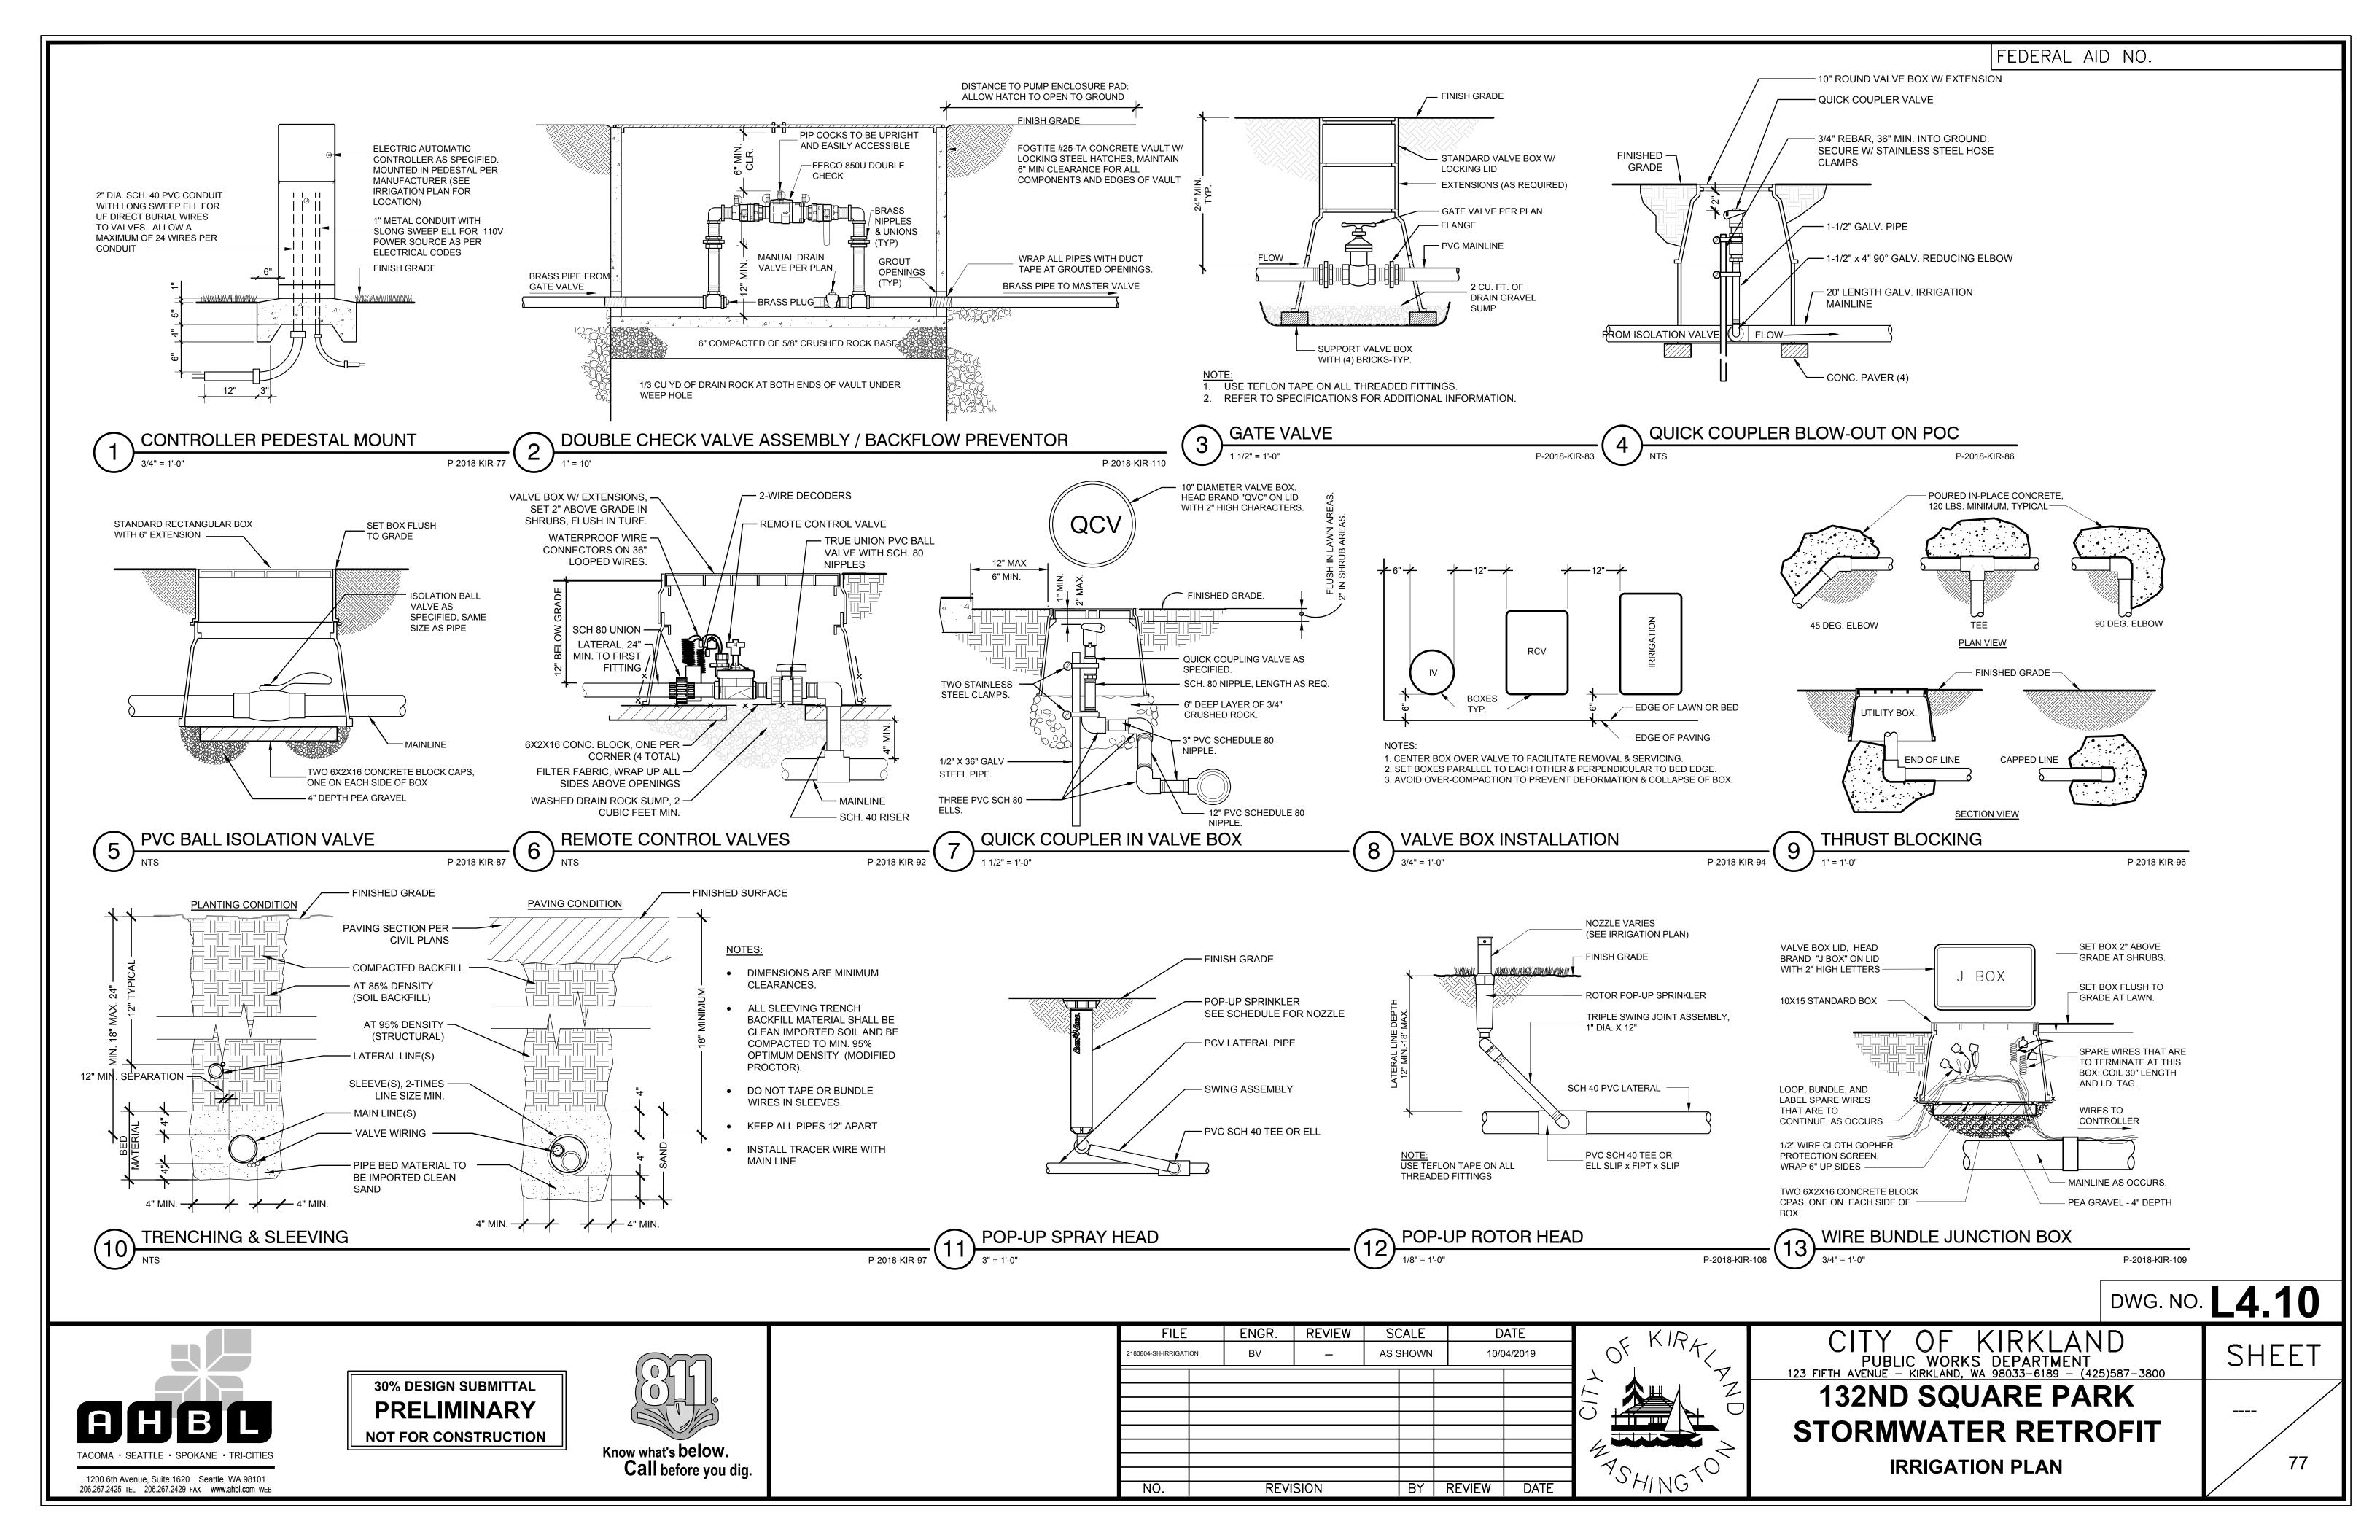
DWG. NO. **L4.09** CITY OF KIRKLAND

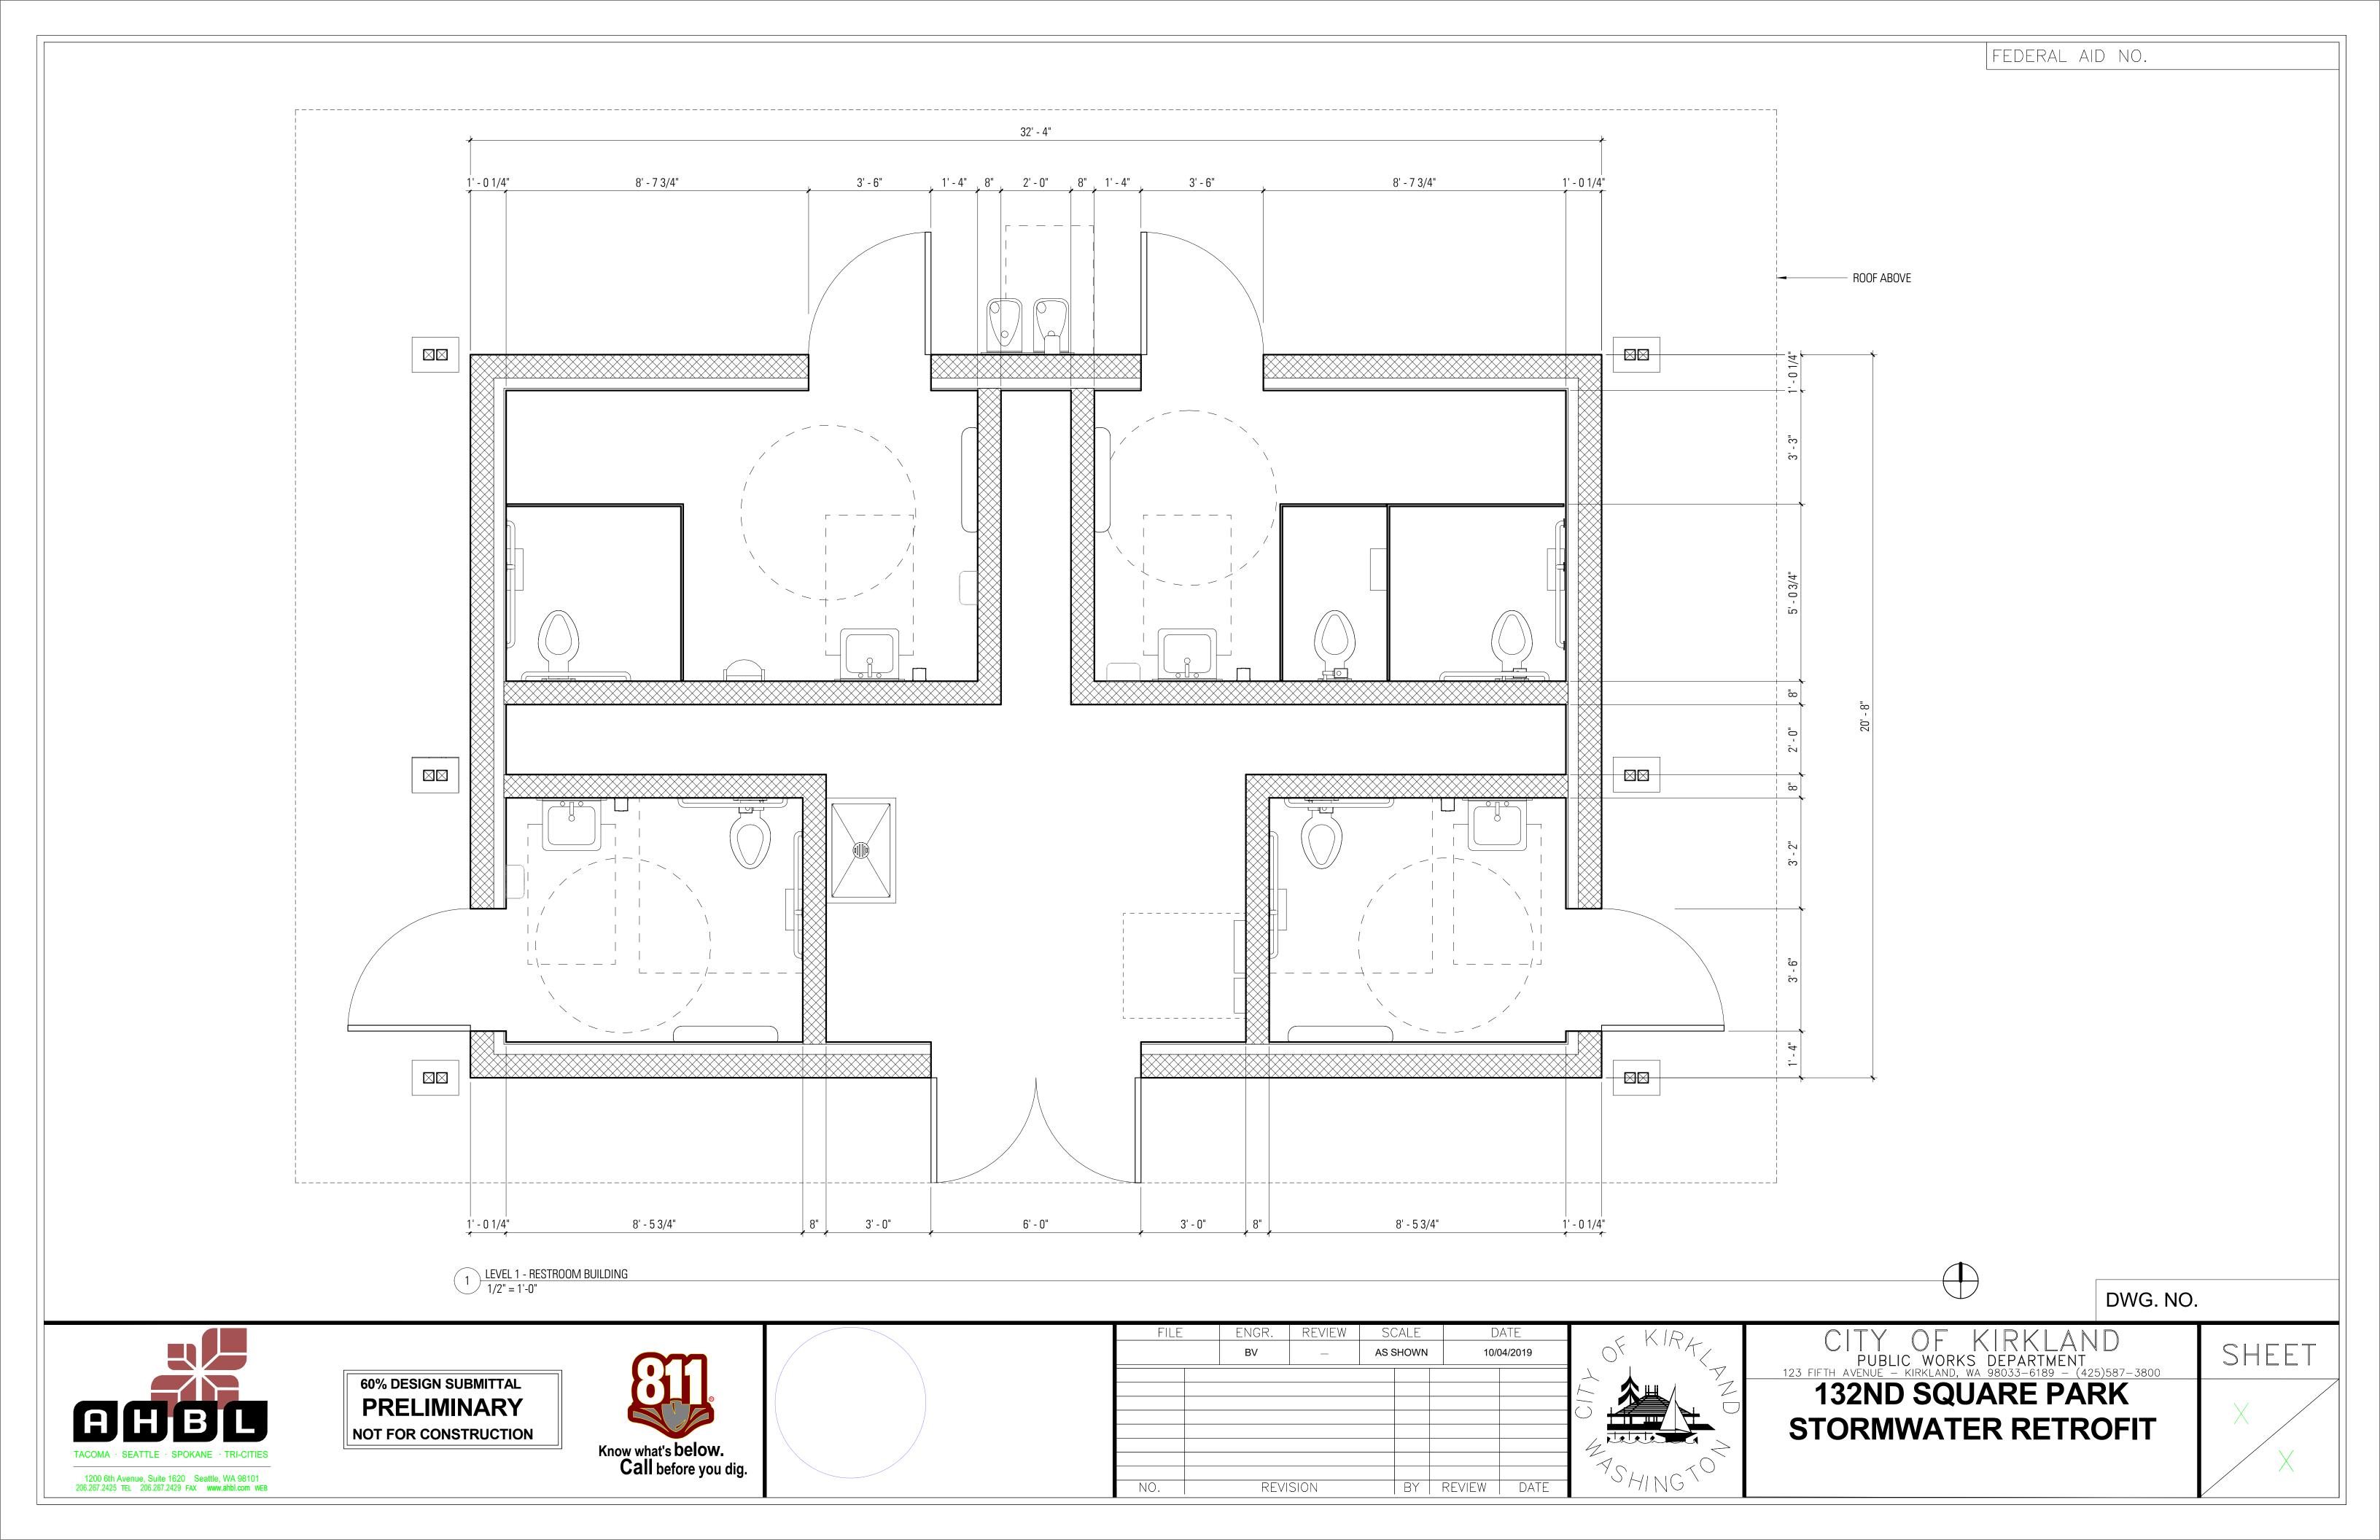
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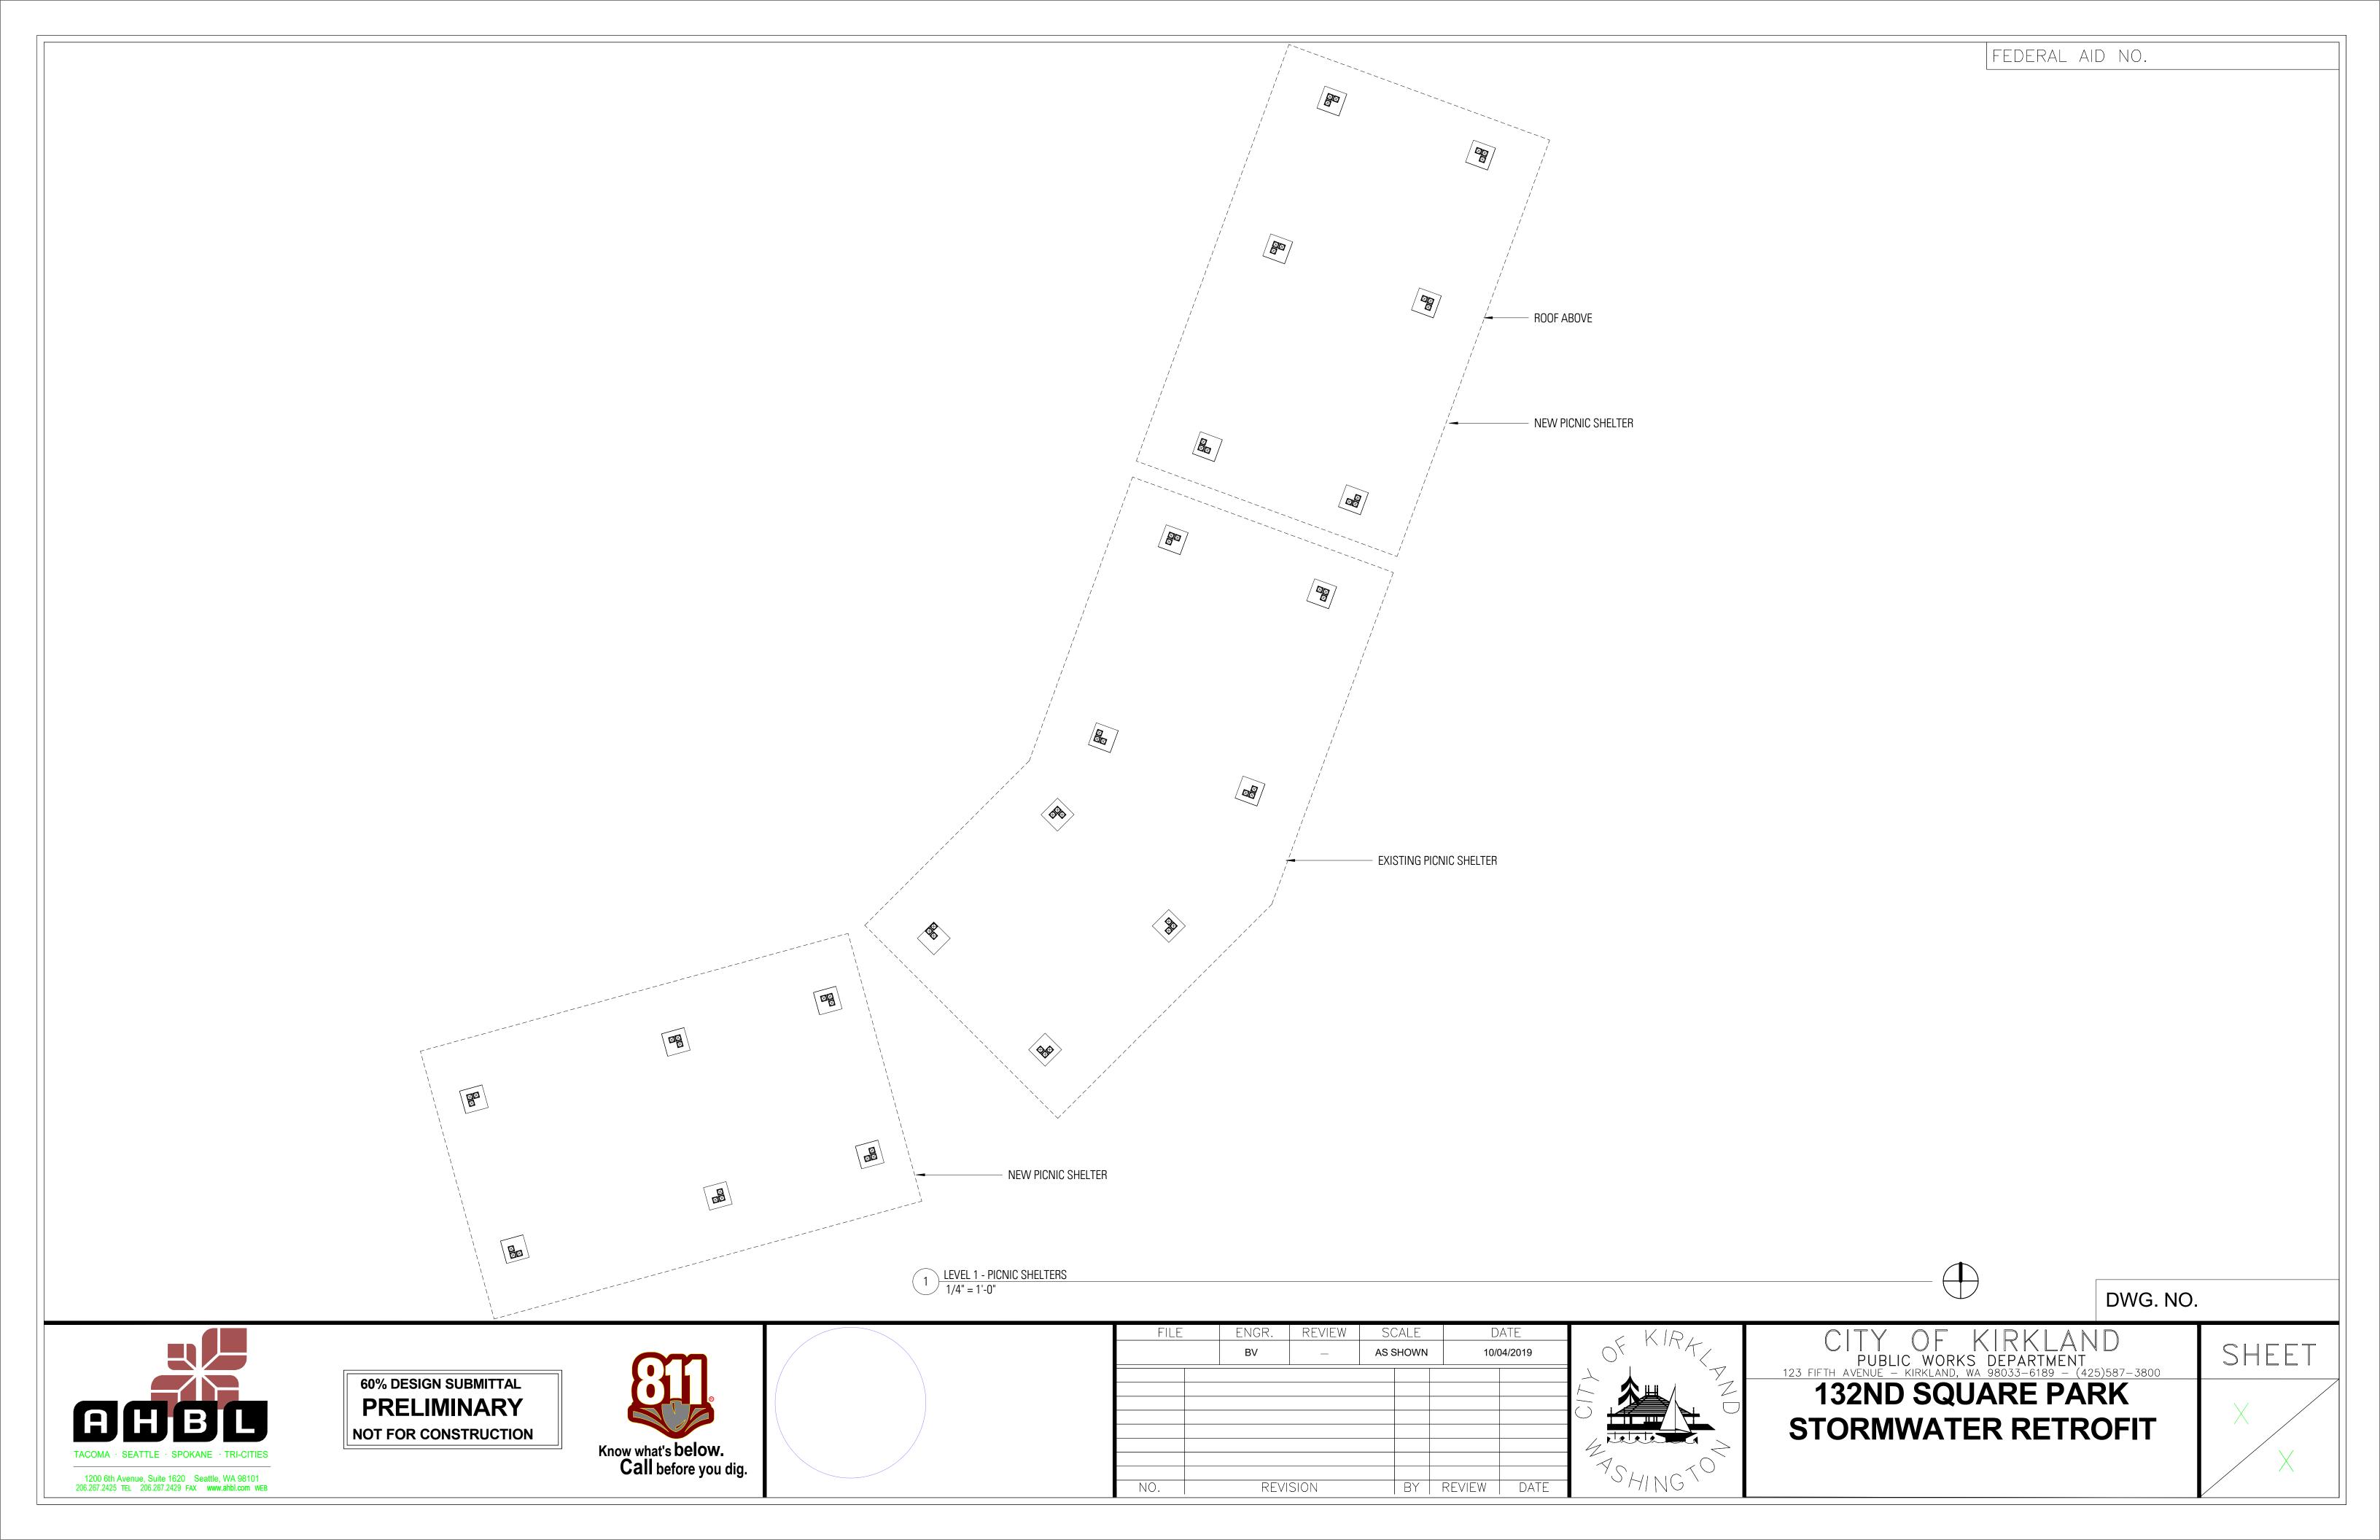
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132ND SQUARE PARK STORMWATER RETROFIT **PLANTING DETAILS**

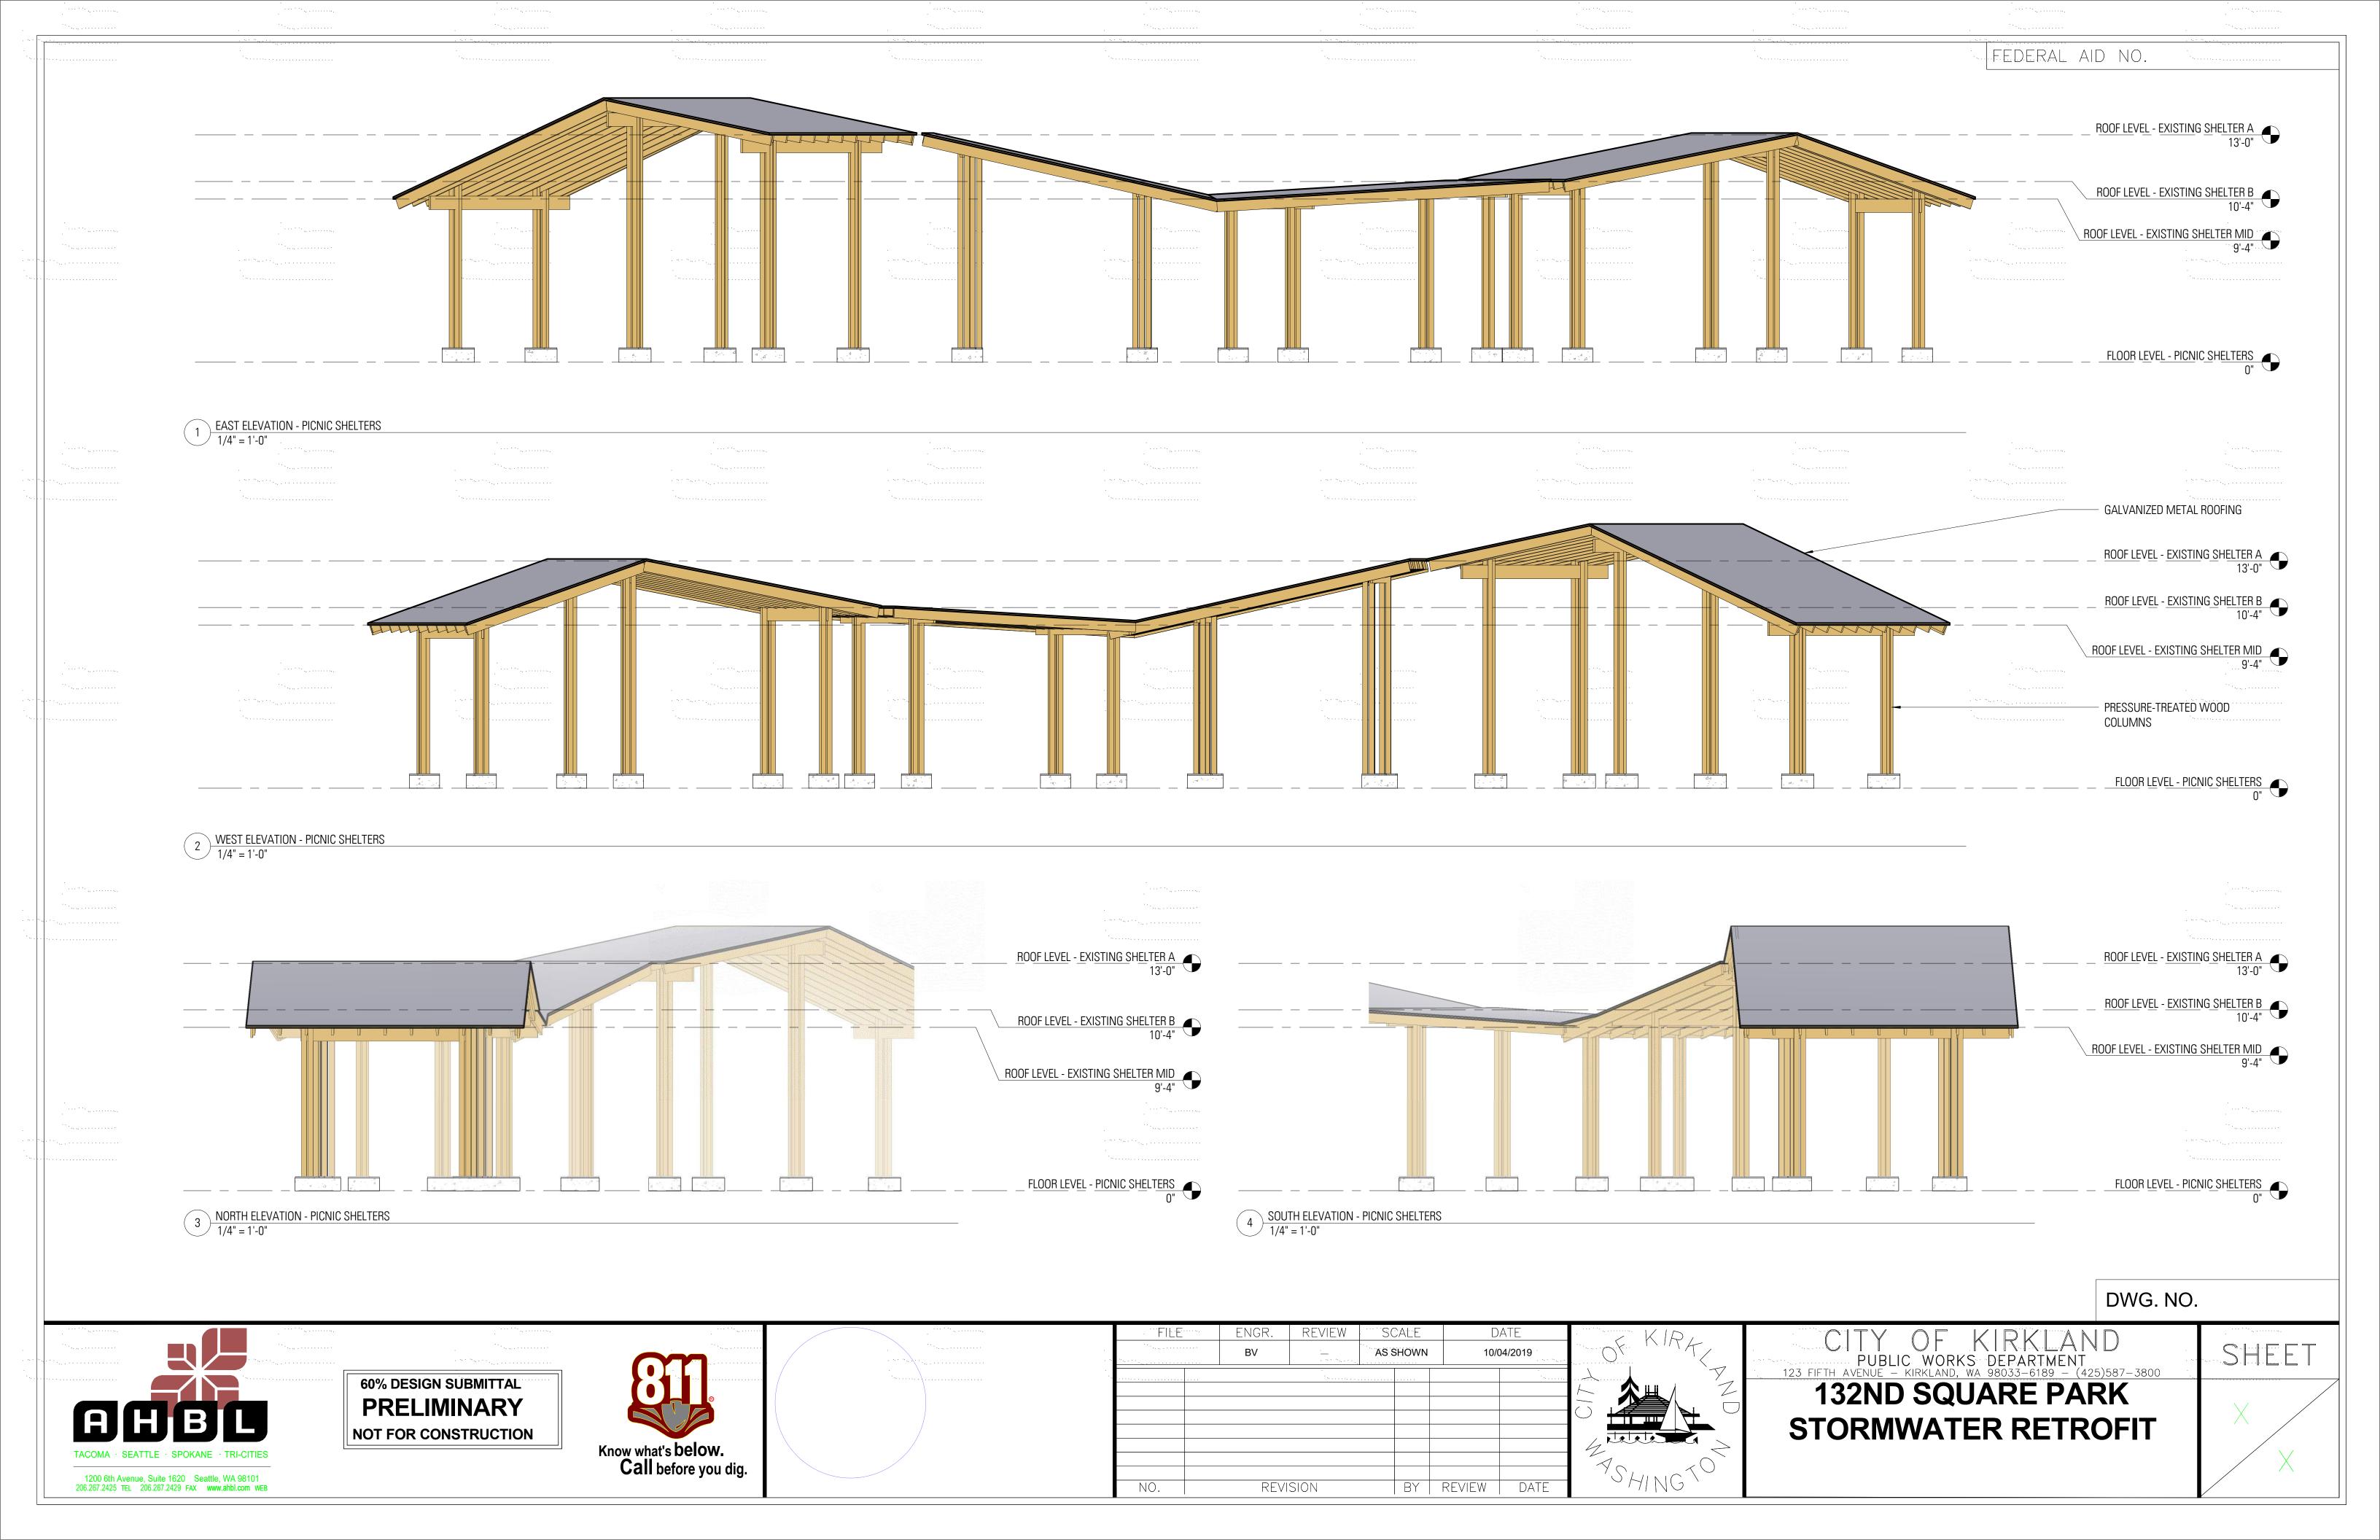
SHEET 73 77











	ELECTRICAL LEGEND
SYMBOL	DESCRIPTION
	LIGHTING/POWER CONTROL PANEL
	BRANCH CIRCUIT WIRING AND CONDUIT AS REQUIRED FOR CKTS DEVICES AND EQUIP INDICATED ON PLANS. (WIRING AND CONDUIT SIZE MAY NOT APPEAR ON PLANS). PROVIDE CONDUCTORS AND CONDUIT PER NEC CODE. #12 AWG, 1/2"C. MIN. EMT OR RIGID STEEL. INDICATES EQUIP GND. INDICATES ISOLATED GROUND.
	CONDUIT UNDER GROUND OR FLOOR
	BRANCH CIRCUIT HOME RUN 3/4" MIN.
<u> </u>	GROUNDING ELECTRODE PER CODE
	VAULT PER DESCRIPTION
••	FIELD LIGHT POLE
•	DRIVEWAY/PARKING LIGHT POLE
Ф	DUPLEX RECEPTACLE
	LIGHT FIXTURE
_	LIGHTING/POWER PANEL

GENERAL NOTES

- 1. PROVIDE COMPLETE WORK FOR REQUIREMENTS AS DESCRIBED ON THIS PAGE.
- INSTALLATION SHALL COMPLY WITH APPLICABLE CODES, INCLUDING, BUT NOT LIMITED TO THE FOLLOWING: 2017 NATIONAL ELECTRICAL CODE (NEC), WASHINGTON STATE ADMINISTRATIVE CODE (WAC), AND 2015 WASHINGTON NON-RESIDENTIAL ENERGY CODE (NREC).
- 3. PROVIDE ALL MATERIAL AND LABOR RELATED TO THE INSTALLATION OF ELECTRICAL DEVICES AND CONDUIT ROUTING UNDERGROUND.
- 4. DO NOT TAKE MEASUREMENTS FROM PLANS FOR DEVICE LOCATIONS. FIELD VERIFY EXACT DEVICE, EQUIPMENT LOCATIONS, AND MOUNTING HEIGHTS WITH OWNER'S REPRESENTATIVE FOR PROPER INSTALLATION.
- 5. RACEWAYS, WIRE SIZES AND CIRCUITS AS SHOWN REPRESENT INTENT OF INSTALLATION, BUT MAY NOT NECESSARILY REPRESENT THE COMPLETE WIRING COUNTS AND MINIMUM SIZES FOR CONNECTING THE CIRCUITS SHOWN. CONTRACTOR SHALL INCLUDE IN THE BID, ALL REQUIRED RACEWAY SIZES AND NUMBER OF CONDUCTORS IN ORDER TO PROVIDE ALL CIRCUITS SHOWN.
- 6. INCLUDE COST OF PROVIDING ALL ELECTRICAL CONNECTIONS AS REQUIRED FOR FULL OPERATION OF ALL OWNER FURNISHED, CONTRACTOR INSTALLED EQUIPMENT. SEE ARCHITECTURAL DRAWINGS TO VERIFY LOCATIONS.
- 7. VERIFY ALL LIGHT FIXTURE TYPES, VOLTAGE, AND MOUNTING METHODS TO SUIT SUPPORTING SURFACES. ALL FIXTURE MOUNTING HEIGHTS SHALL BE APPROVED OR AS DIRECTED BY THE OWNER'S REPRESENTATIVE. VERIFY CORRECT CATALOG NUMBERS PRIOR TO ORDERING OF FIXTURES. ALL SUBSTITUTE LIGHT FIXTURES MUST BE SUBMITTED FOR APPROVAL PRIOR TO BID. APPROVED SUBSTITUTES WILL BE IDENTIFIED IN AN ADDENDUM. PROVIDE ONLY THE APPROVED SUBSTITUTE FIXTURES OR THE FIXTURES AS SPECIFIED. LIGHT FIXTURES WITHOUT PRIOR APPROVALS WILL NOT BE ALLOWED FOR SUBSTITUTION AFTER BIDS.
- 8. LABEL ALL EQUIPMENT, J-BOXES, RACEWAY WITH SERVING PANEL NAME AND CIRCUIT NUMBER(S).
- 9. INSTALLATION OF UNDERGROUND WIRING SYSTEMS SHALL INCLUDE EXCAVATION, CUTTING, PATCHING, BACKFILL, AND COMPACTION. DO NOT CUT OR DAMAGE ANY EXISTING UTILITIES, STRUCTURAL MEMBERS, OR BUILDING FOUNDATIONS. VERIFY EXISTING CONDITIONS PRIOR TO EXCAVATION WORK. INCLUDE COST FOR UNDERGROUND LOCATOR SERVICE TO IDENTIFY LOCATIONS OF EXISTING COMPONENTS. HAND EXCAVATE IN LOCATIONS WHERE EXISTING UNDERGROUND COMPONENTS ARE SUBJECT TO DAMAGE. REPAIR DAMAGE TO EXISTING UTILITIES OR BUILDING STRUCTURE TO OWNER'S SATISFACTION AT THE CONTRACTORS EXPENSE.
- 10. RACEWAY ROUTING IS SCHEMATIC AND DOES NOT SHOW EXACT PHYSICAL ARRANGEMENT OF EQUIPMENT. WHERE INDICATED ON DRAWINGS, JUNCTION BOXES AND PULLBOXES ARE MINIMUM REQUIREMENTS. PROVIDE FITTINGS AND PULLBOXES OF ADEQUATE SIZE IN RACEWAY SYSTEMS WHEREVER NECESSARY OR REQUIRED BY THE NEC OR LOCAL CODES. PROVIDE EXPANSION JOINT FITTINGS FOR RACEWAY PASSING THROUGH NEW OR EXISTING EXPANSION JOINTS INSTALLED BETWEEN BUILDINGS. VERIFY EXACT LOCATIONS AND DETAILS OF EXPANSION JOINTS PRIOR TO WORK. COORDINATE ALL RACEWAY ROUTING, PULLBOXES, AND EQUIPMENT LOCATIONS WITH OTHER TRADES TO AVOID CONFLICTS OF EQUIPMENT INSTALLATIONS.
- 11. PROVIDE PULL-WIRES IN ALL EMPTY CONDUITS.
- 12. PRIOR TO PREPARATION OF BID, VISIT JOBSITE AND EXAMINE EXISTING CONDITION.

DWG. NO. **E1.00**

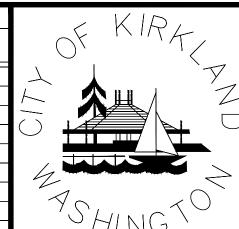


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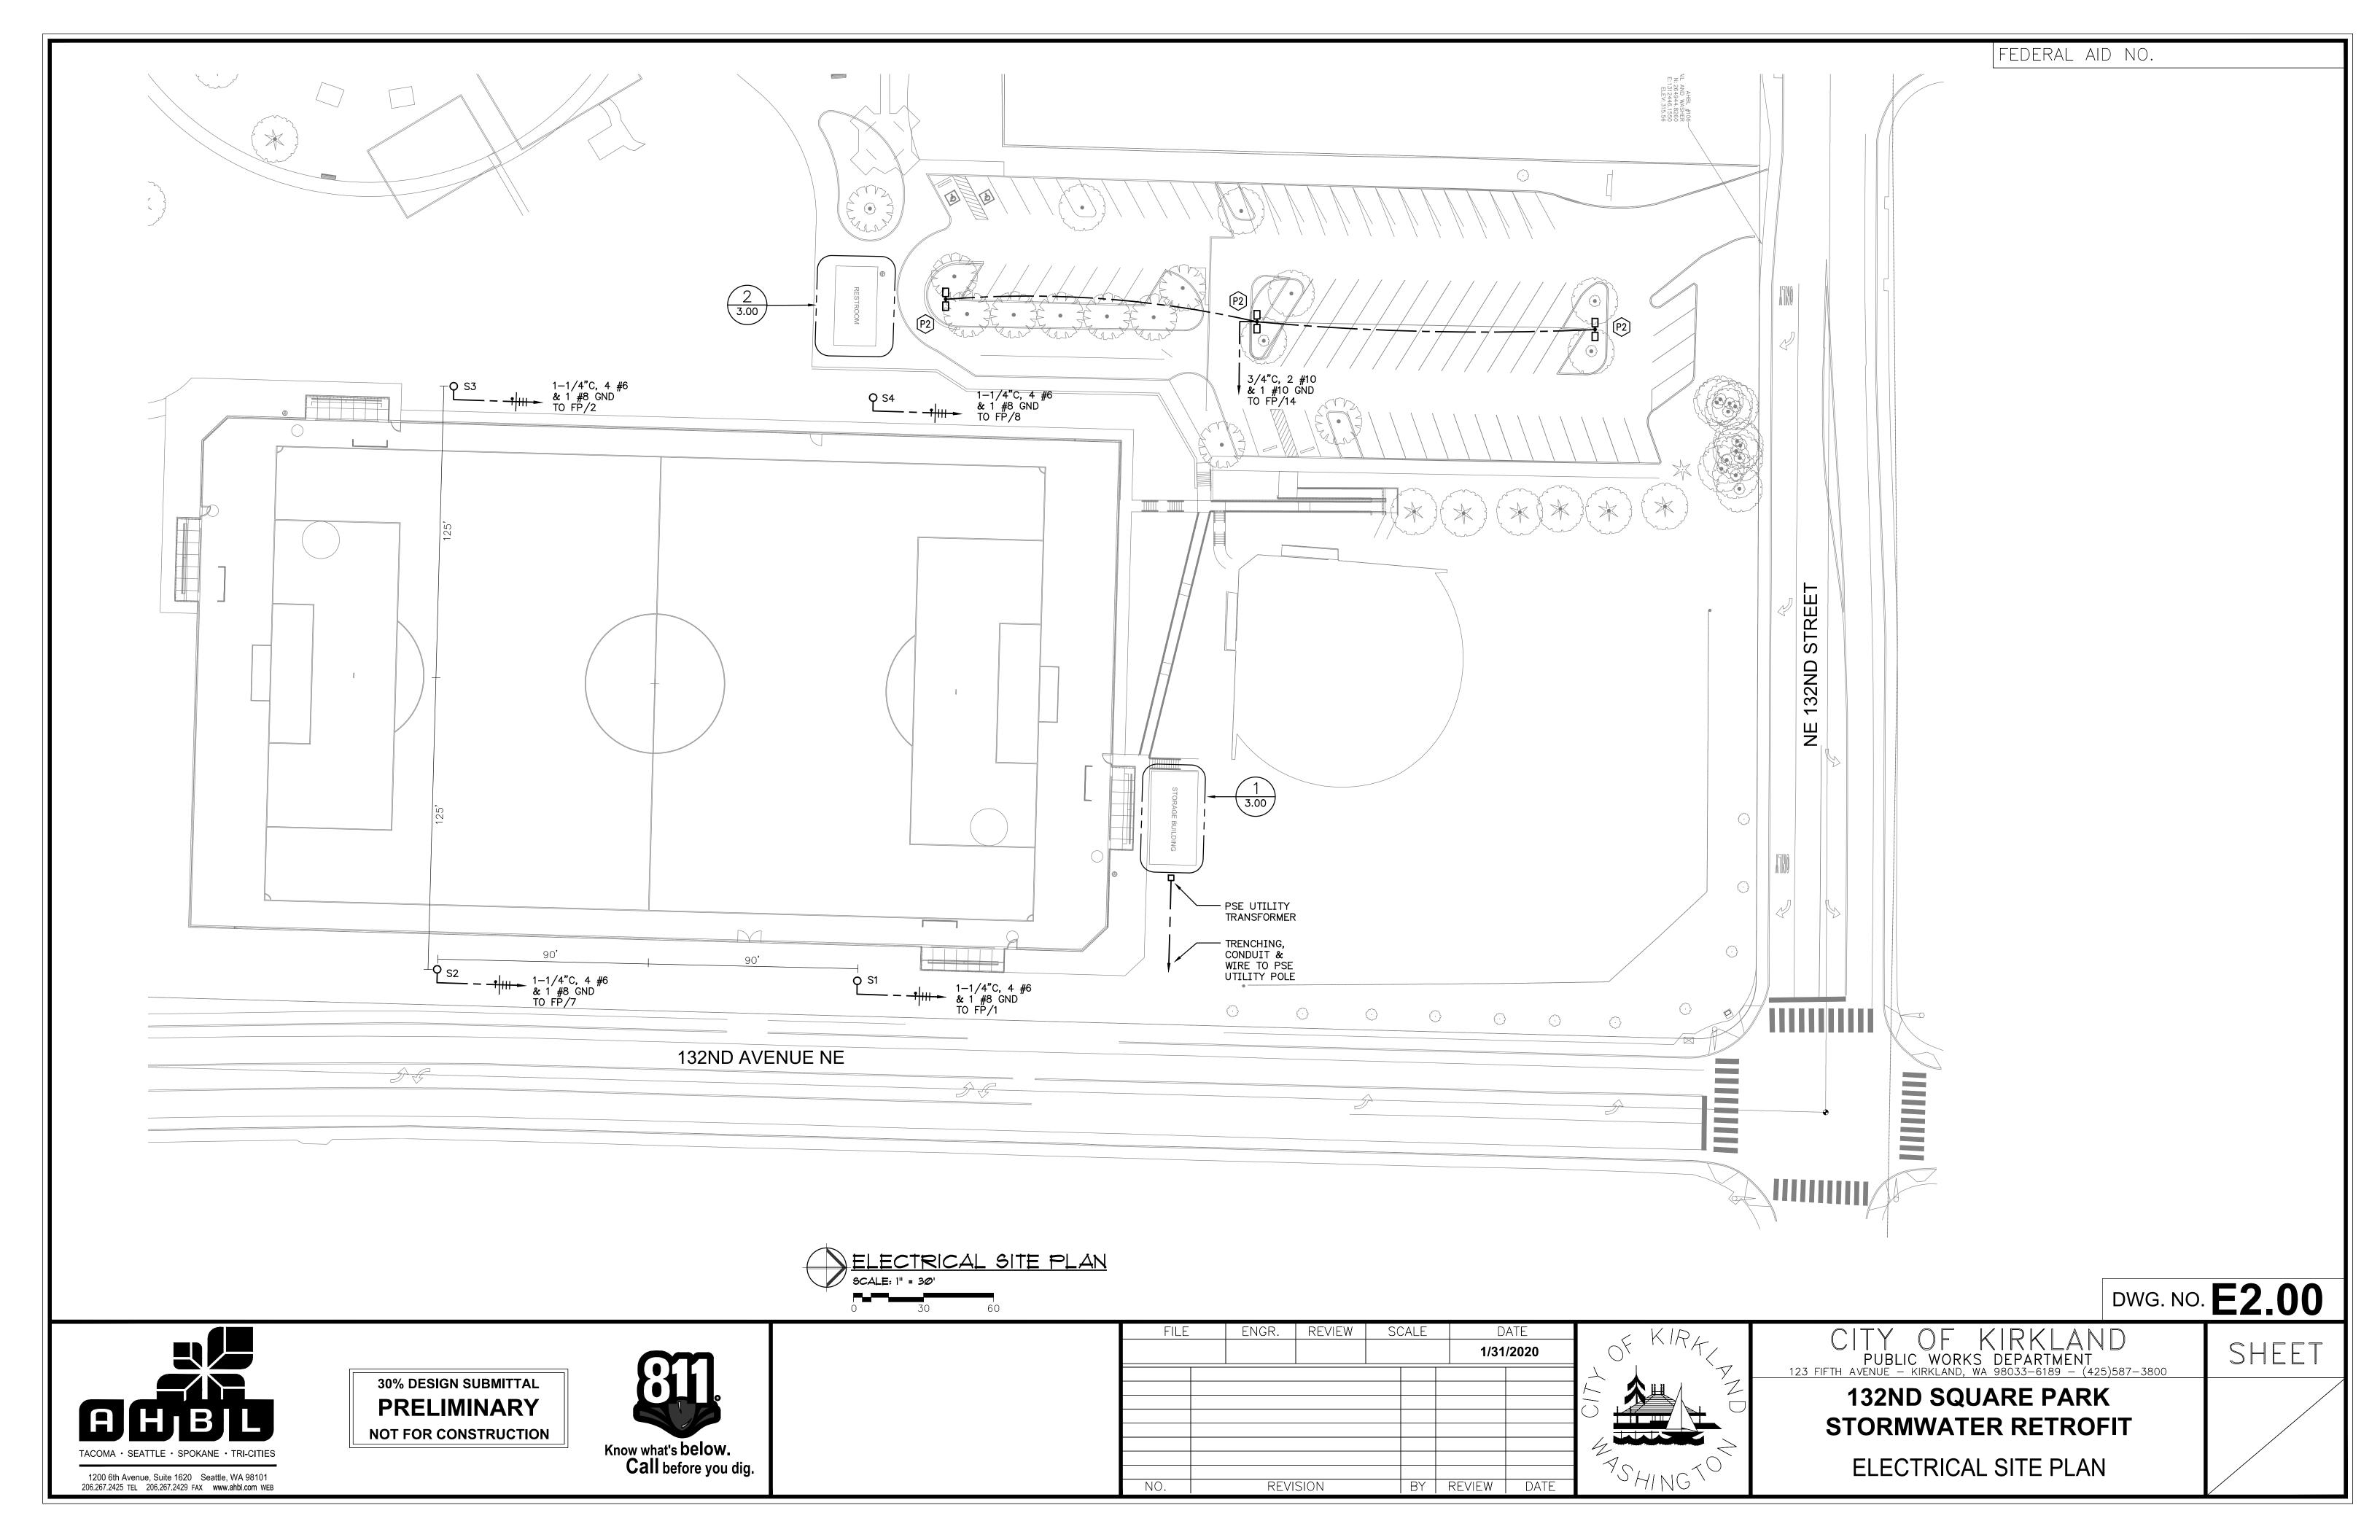
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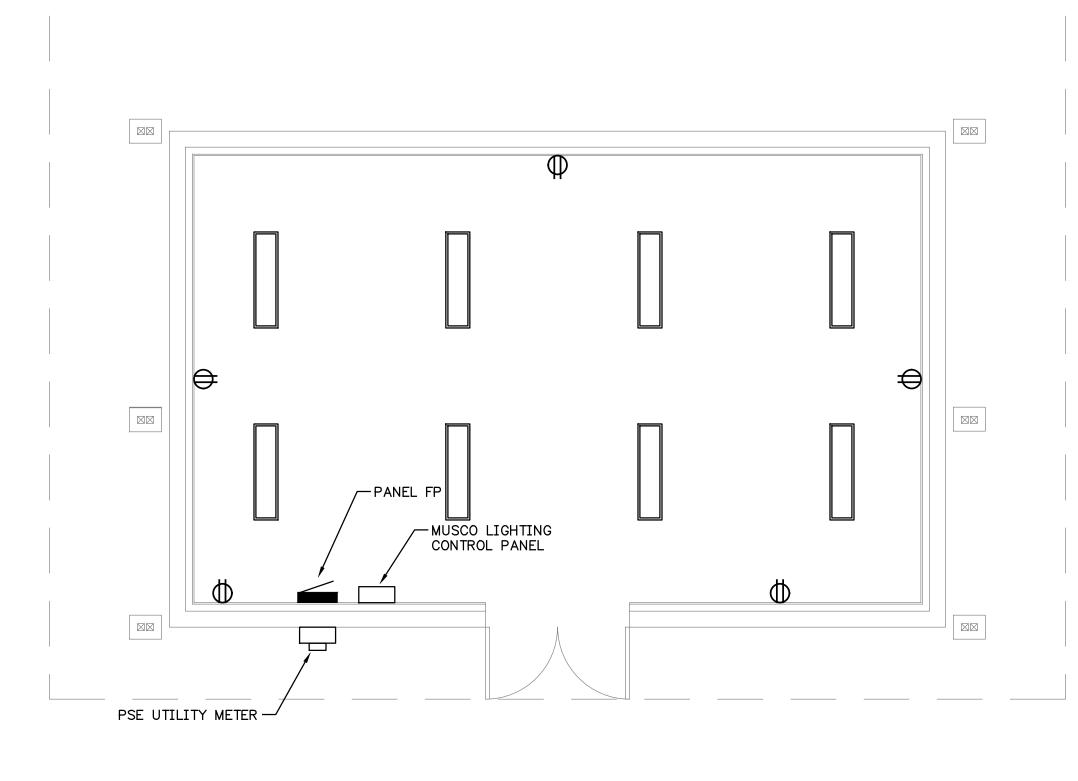
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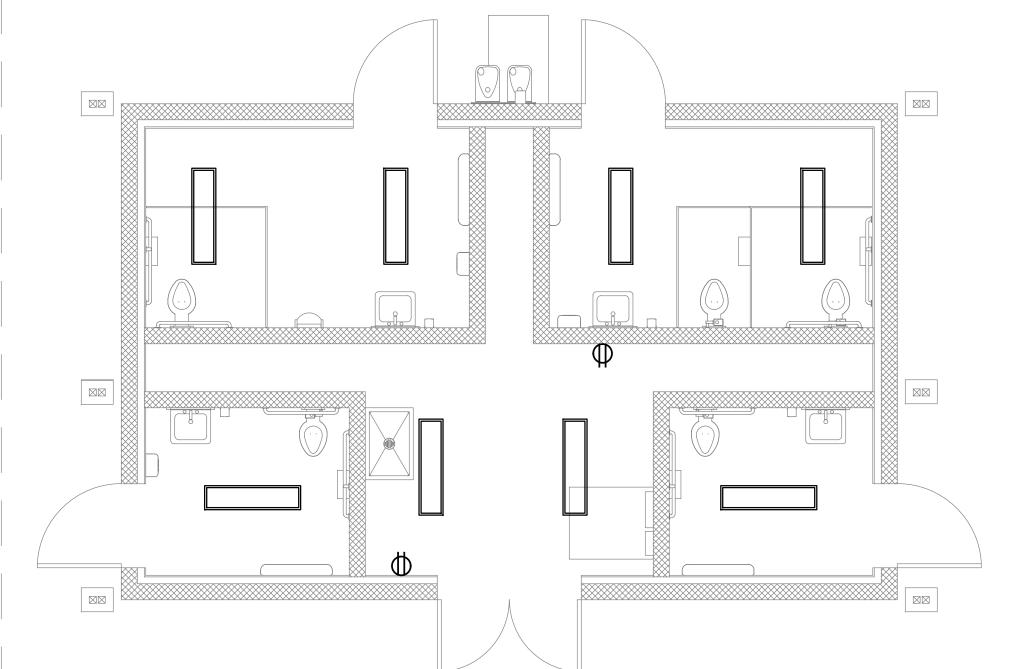
132ND SQUARE PARK STORMWATER RETROFIT

ELECTRICAL LEGEND AND NOTES









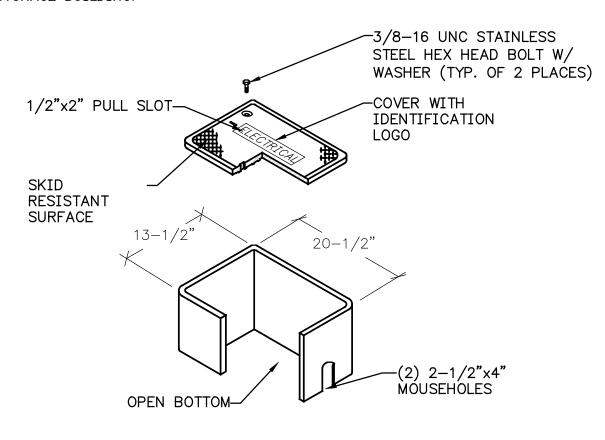
	FP			ARKING - BU MOUNT TRA	JILDINGS NSFORMER				PHASE WIRE	225 AMF	MAIN BREA	MOUNTING: S	9,000 A URFACE
СКТ	LOA	D DESCRIPTIO	N	TYPE	KVA	A/P	PHASE	A/P	KVA	TYPE	L	OAD DESCRIPTION	СКТ
1	FIELD LIGHT	POLE S1		L	7.020	30/3	Α	30/3	5.850	L	FIELD LIGH	HT POLE S3	2
3				-	-	-	В	-	-	-			4
5				-	-	-	С	-	-	-			6
7	FIELD LIGHT	POLE S2		L	7.020	30/3	A	30/3	5.850	L	FIELD LIGH	HT POLE S4	8
9				-	-	-	В	-	-	-			10
11				-	-	_	С	-	-	-			12
13	MUSCO CONT	TROL CABINET	- ""	D	1.000	20/1	Α	20/2	0.500	L	PARKING A	REALIGHTS	14
15	STORAGE BU	ILDING LIGHTS	3	L	0.240	20/1	В	-	-	-			16
17	STORAGE BU	ILDING RECEF	PTS	R	0.900	20/1	С	20/1	-	S	SPARE		18
19	RESTROOM B	UILDING LIGH	TS	L	0.240	20/1	А	20/1	-	S	SPARE		20
21	RESTROOM B	UILDING RECI	EPTS	R	0.360	20/1	В	20/1	-	S	SPARE		22
23	SPARE			S	-	20/1	С	20/1	-	S	SPARE		24
25	SPARE			S	-	20/1	A	20/1	-	S	SPARE		26
27	SPARE			S	-	20/1	В	20/1	-	S	SPARE		28
29	SPARE			S	-	20/1	С	20/1	-	S	SPARE		30
31	SPARE			S	-	20/1	A	20/1	-	S	SPARE		32
33	SPARE			S	-	20/1	В	20/1	-	S	SPARE		34
35	SPARE			S	-	20/1	С	20/1	-	S	SPARE		36
37	SPARE			S	-	20/1	A	20/1	-	S	SPARE		38
39	SPARE			S	-	20/1	В	20/1	-	S	SPARE		40
41	SPARE			S	-	20/1	С	20/1	-	S	SPARE	***************************************	42
F	PHASE LOAD	PHASE A=	10.07	KVA	PHASE B=	9.43	_KVA	PHASE C=	9.48	KVA			<u> </u>
	LOAD TYPE	L	R	M	Н	WH		D	Α	K	LM	TOTAL LO	DADS
	ONN. LOAD	26.72	1.26					1.00				28.98 KVA	80.44 AMF
	CALC. LOAD	33.40	1.26					1.00				35.66 KVA	98.98 AMF

PRE-FAB STORAGE BUILDING - ELECTRICAL PLAN

E3.00 SCALE: 1/4" = 1'-0" NOTES:

STORAGE BUILDING IS PRE-FABRICATED. APPROXIMATE SIZE SHOWN FOR REFERENCE ONLY.

ELECTRICAL EQUIPMENT SHOWN IS INTENDED TO BE PLACED IN STORAGE BUILDING.

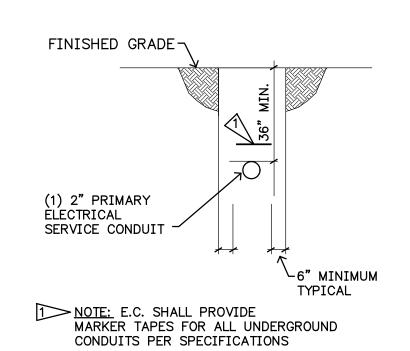


NOTES:

- 1. STANDARD MARKED WITH "ELECTRICAL".— LIGHTING CIRCUITS = "LIGHTING"
- 2. DIMENSIONS ARE APPROXIMATE.

TYPICAL HANDHOLE AND COVER

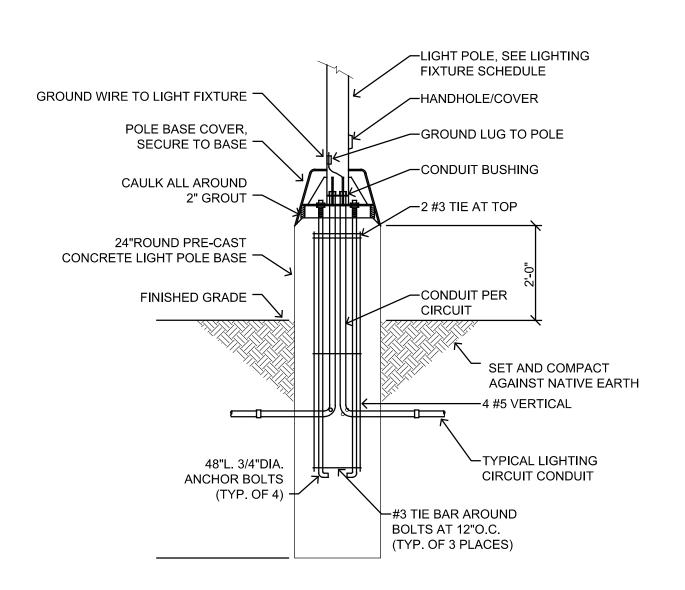




UTILITY SERVICES TRENCH DETAIL

ELECTRICAL PANEL SCHEDULE FOR PANEL 'FP'

SCALE: NONE



CONCRETE FOOTING DETAIL FOR FIXTURE TYPE 'P2'

SCALE: NONE

DWG. NO. **E3.00**



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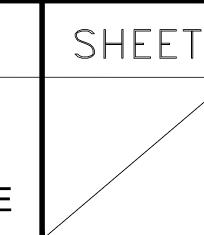
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132ND SQUARE PARK
STORMWATER RETROFIT

ELECTRICAL DETAILS AND SCHEDULE



	MECH	IANICAL LE	EGEND
SYMBOL	DESCRIPTION	SYMBOL	DESCRIPTION
	COLD WATER (CW)		SUPPLY AIR-DUCT UP
	HOT WATER (HW)		EXHAUST/RETURN AIR - DUCT UP
	HOT WATER CIRC (HWC)		OUTSIDE AIR DUCT UP
	WASTE OR SAN. SEWER		SUPPLY AIR - DUCT DOWN
	VENT (V)		EXHAUST/RETURN AIR - DUCT DOWN
G	GAS		OUTSIDE AIR DUCT DOWN
COND -	CONDENSATE PIPING		SOUNDLINED DUCT
RG	REFRIGERANT GAS	S	DUCT UP (ROUND)
	REFRIGERANT LIQUID		DUCT DOWN (ROUND)
CI	PIPE DOWN	12/12 RR 300 CFM	AIR TERMINAL SIZE, TYPE & CFM
O l	PIPE UP	12/12 DL	DOOR LOUVER W/ SIZE
	BRANCH - TOP CONNECTION		CEILING AIR TERMINAL - SQUARE
151	BRANCH - BOTTOM CONNECTION	101	CEILING AIR TERMINAL - ROUND
	BRANCH - SIDE CONNECTION	33333	FLEXIBLE DUCT
3	CAP END OF PIPE	+ + +	VOLUME DAMPER (VD)
	FLOW DIRECTION	₩ <u>₩</u>	MOTORIZED DAMPER
0	FLUSH CLEANOUT (FCO) OR SURFACE CLEANOUT (SCO) AS INDICATED		FIRE DAMPER (FI.D.)
← ——	WALL CLEANOUT (WCO)		FIRE/SMOKE DAMPER (CFSD) - COMBINATION
I 	CLEANOUT (CO)		SMOKE DAMPER (SD)
DS O	DOWNSPOUT	7 1 7	BACKDRAFT DAMPER (BDD)
J¦L	VENT THRU ROOF (VTR)		FLEXIBLE CONNECTION (DUCT)
₩	GATE VALVE (GV)		TURNING VANES (TV)
───	GLOBE VALVE	T	ROOM TEMPERATURE SENSOR/THERMOSTAT
₹	VALVE IN RISER	\oplus_{G}	ROOM TEMPERATURE SENSOR/THERMOSTAT WITH GUARD
<u> </u>	BUTTERFLY VALVE	Ç OR ⅓	DRAIN VALVE WITH HOSE CONNECTION OR HOSE BIBB
<u></u>	PRESSURE REDUCING VALVE (PRV)	——BFP—	BACKFLOW PREVENTER ASSEMBLY
~~	CHECK VALVE (CV)	O	FLOOR DRAIN (FD)
	BALL VALVE (BV)	•	FLOOR & FUNNEL DRAIN (F&FD)
	FREEZEPROOF WALL HYDRANT (FWH) HOSE BIBB (HB)	个	AUTOMATIC OR MANUAL AIR VENT (AAV, MAV)
X	TEMPERATURE/PRESSURE RELIEF VALVE (T&PV)	甲	VACUUM BREAKER
₹	GAS COCK		PRESSURE GAUGE
(AO) 1, t ₁	AQUASTAT	<u> </u>	THERMOMETER
	PUMP	M	METER
f	RELIEF VALVE	RPBP	REDUCED PRESSURE BACKFLOW PREVENTER
- ▼OR 🖾	BALANCING VALVE		POINT OF CONNECTION
─	REDUCER	1//////////////////////////////////////	DEMOLITION SCOPE OF WORK
	STRAINER		
——- — ——	UNION		

MECHANICAL GENERAL NOTES

- 1. STANDARD CURRENT TRADE PRACTICES & METHODS APPLY TO THIS PROJECT. ALL WORK IS TO MEET REQUIREMENTS OF ALL CURRENT CODE & LOCAL JURISDICTIONAL REQUIREMENTS AND AMENDMENTS. THESE CODES INCLUDE BUT ARE NOT LIMITED TO WASHINGTON STATE ENERGY CODE, INTERNATIONAL MECHANICAL CODE, INTERNATIONAL BUILDING CODE, UNIFORM PLUMBING CODE, NFPA, INTERNATIONAL FIRE CODE, & LOCAL JURISDICTIONAL REQUIREMENTS. COMPLY WITH ALL MANUFACTURER'S REQUIREMENTS. COORDINATE WITH OWNER'S REPRESENTATIVE FOR ANY VARIANCES.
- 2. DRAWINGS ARE DIAGRAMMATIC ONLY & NOT INTENDED TO SHOW ALL DETAILS OF THE WORK. VERIFY LOCATION & MEASUREMENTS OF ALL ITEMS ON THE JOB SITE PRIOR TO INSTALLATION. CONTRACTOR SHALL PROVIDE ALL OFFSETS & ADDITIONAL DUCTWORK & PIPING AS NECESSARY TO AVOID STRUCTURAL ELEMENTS ON THE PROJECT. CONTRACTOR SHALL PRODUCE SHOP DRAWINGS & COORDINATE WITH OTHER TRADES. THERE SHALL BE NO ADDITIONAL COST TO THE OWNER FOR THIS COORDINATION OR FOR EXTRA MATERIAL REQUIRED IN ORDER TO ACCOMPLISH THIS TASK.
- 3. PROVIDE COMPLETE & FULLY-OPERATING SYSTEMS.
- 4. COORDINATE LOCATIONS OF ALL EQUIPMENT & APPURTENANCES WITH OTHER TRADES.
- 5. ALL EQUIPMENT SHALL BE REGULARLY CATALOGED ITEMS OF THE MANUFACTURER & SHALL BE SUPPLIED AS A COMPLETE UNIT IN ACCORDANCE WITH THE MANUFACTURER'S STANDARD SPECIFICATIONS. ANY OPTIONAL ITEMS REQUIRED FOR PROPER INSTALLATION SHALL BE INCLUDED UNLESS OTHERWISE NOTED.
- 6. ANY CUTTING, PATCHING & PAINTING OF BUILDING ELEMENTS & FINISHED SURFACES IS TO BE DONE BY THE GENERAL CONTRACTOR.
- 7. ALL APPLIANCES DESIGNED TO BE FIXED IN POSITION SHALL BE SECURELY FASTENED IN PLACE.
- 8. ALL EQUIPMENT SHALL BE LABELED PER PLANS & THE REQUIREMENTS OF THE SPECIFICATIONS.
- 9. RATING OF ACCESS DOORS AND/OR ACCESS PANELS THROUGH FIRE-RATED WALLS, SHAFTS, CEILINGS, ETC., MUST EQUAL THE FIRE RATING OF THE MATERIAL PENETRATED.
- 10. CAULK & FLASH ALL PENETRATIONS PER CODE.
- 11. ADJUSTING & BALANCING: ADJUST EACH PART OF SYSTEM TO ENSURE PROPER FUNCTIONING OF ALL CONTROLS & SPECIFIED AIR DISTRIBUTION. LEAVE ENTIRE SYSTEM IN OPERATING CONDITION.
- 12. PROVIDE OPERATING & MAINTENANCE MANUALS (O&MS), RECORD DRAWINGS, & OWNER TRAINING PER SPECIFICATION.
- 13. PROVIDE NATIONAL ELECTRICAL CODE (NEC) MINIMUM WORKING CLEARANCE IN FRONT OF ANY ELECTRICAL PANEL, INCLUDING PANELS ON EQUIPMENT. RE-ROUTE OR OFFSET PIPING AND/OR DUCTWORK AS REQUIRED.
- 14. DOMESTIC HOT WATER CIRCULATORS SHALL BE CONTROLLED BY AN AQUASTAT, & SHALL SHUT DOWN WHEN WATER TEMPERATURE IS AT SETPOINT. DOMESTIC HOT WATER CIRCULATION SHALL HAVE SHUT-OFF CAPACITY BASED ON OCCUPANCY AND PERIODS OF DEMAND.
- 15. DOMESTIC PIPING SHALL BE INSULATED IN ACCORDANCE WITH THE WASHINGTON STATE ENERGY CODE. DOMESTIC HOT WATER PIPE INSULATION SHALL BE K=0.24, 1" THICK, EXCEPT RUNOUTS UP TO 12' SHALL BE 1/2"THICK. DOMESTIC COLD WATER PIPE INSULATION SHALL BE K=0.24, 1" THICK FOR PIPING LARGER THAN 1", & 1/2" THICK FOR PIPING 1" & LESS & RUNOUTS LESS THAN 2" DIAMETER UP TO 12'. INCREASE THICKNESS BY 1/2" FOR PIPING EXPOSED DIRECTLY TO OUTDOOR CONDITIONS.
- 16. SERVICE WATER PIPING INSULATION CONDUCTIVITY IS NOT TO EXCEED 0.27 BTU PER INCH/H*SQ.FT*DEGREE F. INSULATION THICKNESS SHALL BE PER TABLE C403.2.9.
- 17. PROTECT PIPING INSULATION PER REQUIREMENTS OF WSEC C403.2.9.1
- 18. PROVIDE COMMISSIONING OF THE HVAC SYSTEM. INCLUDE FUNCTIONAL TESTING SEQUENCE OF OPERATION & TEST PROCEDURES PER WASHINGTON STATE ENERGY CODE. SEE SPECIFICATIONS FOR SPECIFIC EQUIPMENT TESTING REQUIREMENTS. ITEMS TO BE COMMISSIONED ARE: CONTROL SYSTEMS, AIR HANDLERS, EXHAUST FANS, PUMPS, CONDENSING UNITS, MAKE-UP AIR UNITS, AND WATER HEATERS. AIR SYSTEMS SHALL BE BALANCED SO AS TO FIRST MINIMIZE THROTTLING LOSSES, THEN ADJUSTED TO MEET DESIGN FLOW CONDITIONS. PROVIDE PRELIMINARY AND FINAL COMMISSIONING REPORTS. SUBMIT FIGURE C408.1.2.1 COMPLIANCE CHECKLIST FROM WASHINGTON STATE ENERGY CODE TO AUTHORITY HAVING JURISDICTION UPON COMPLETION OF PRELIMINARY COMMISSIONING REPORT. PROVIDE CLOSEOUT DOCUMENTS IN COMPLIANCE WITH C103.6

- 19. PROVIDE AIR SYSTEM BALANCING DEVICES, INCLUDING VOLUME DAMPERS, AND ZONE DAMPERS ON TERMINALS AS SHOWN ON PLANS. TEST AND BALANCE ALL SYSTEMS
- 20. PROVIDE WATER SYSTEM BALANCING DEVICES, INCLUDING ISOLATION VALVES, BALANCING VALVES, AND FLOW MEASURING DEVICES AS SHOWN ON PLANS.
- 21. CEILING FANS, EQUIPMENT, DIFFUSERS, & GRILLES SHALL BE COORDINATED WITH PLACEMENT OF LIGHT FIXTURES.
- 22. VENTILATION SHALL BE PROVIDED PER IMC CHAPTER 4.

 MECHANICALLY VENTILATED SYSTEMS SHALL BE CAPABLE OF
 REDUCING THE OUTDOOR AIR SUPPLY TO THE MINIMUM
 REQUIRED BY CHAPTER 4 OF THE IMC.
- 23. PROVIDE COMBINATION FIRE & SMOKE DAMPERS (CFSD)
 AND/OR FIRE DAMPERS WHERE REQUIRED BY CODE.
- 24. TEMPERATURE CONTROLS SHALL BE MINIMUM OF 7-DAY PROGRAMMABLE TYPE PROVIDING SETPOINT TEMPERATURES, NIGHT SETBACK, MANUAL OVERRIDE, & MINIMUM 5-DEGREE DEADBAND. CONTROLS SHALL ALLOW FOR OPTIMUM START.
- 25. HEAT PUMPS WITH AUXILIARY ELECTRIC HEAT SHALL HAVE CONTROLS COMPLYING WITH PARAGRAPH C403.2 OF THE WASHINGTON STATE ENERGY CODE.
- 26. SEAL & TEST ALL DUCTWORK AS REQUIRED PER IMC, WSEC C403.2.8.3 LEAKAGE REQUIREMENTS, & IBC VAPOR RETARDER REQUIREMENTS. DUCTWORK DESIGN PRESSURE IS 2".
- 27. HIGH PRESSURE DUCTWORK DESIGNED TO OPERATE AT STATIC PRESSURES EXCEEDING 3" WG SHALL BE SEALED AND INSULATED IN ACCORDANCE WITH WSEC C403.2.7 AND LEAK TESTED IN ACCORDANCE WITH THE SMACNA HVAC AIR DUCT LEAKAGE TEST MANUAL. TEST RESULTS SHALL BE PROVIDED TO AUTHORITY HAVING JURISDICTION WHEN COMPLETED.
- 28. ALL SHEET METAL DUCTWORK SHALL BE INSULATED IN ACCORDANCE WITH THE WASHINGTON STATE ENERGY CODE. CONCEALED DUCTWORK LOCATED WITHIN THE CONDITIONED SPACE SHALL BE INSULATED WITH A MINIMUM OF R-3.3. DUCTWORK LOCATED IN UNCONDITIONED SPACES SHALL BE INSULATED WITH A MINIMUM OF R-6. WHERE LOCATED OUTSIDE OF THE BUILDING, DUCTWORK SHALL BE INSULATED WITH A MINIMUM OF R-8.
- 29. SOUND-LINE ALL SUPPLY, RETURN, OR EXHAUST DUCT WITHIN 10' OF FANS UNLESS NOTED OTHERWISE.
- 30. ALL SHEET METAL PRODUCTS SHALL COMPLY WITH SMACNA DUCT CONSTRUCTION STANDARDS, CURRENT EDITION.
- 31. ALL RECTANGULAR DUCTWORK SIZES SHOWN ARE GALVANIZED SHEET METAL UNLESS NOTED OTHERWISE. ROUND DUCT SHALL BE SHEET METAL. PROVIDE TURNING VANES IN ALL ROUND 2-PIECE AND RECTANGULAR 90 DEGREE ELBOWS.
- 32. ALL DUCT SIZES SHOWN ARE CLEAR INSIDE DIMENSIONS.
- 33. WHERE FLEXIBLE DUCT IS SHOWN AT GRILLES, REGISTERS, AND DIFFUSERS, PROVIDE 6' MAXIMUM LENGTH OF FLEXIBLE DUCT
- 34. PROVIDE FLEXIBLE CONNECTORS AT DUCT CONNECTIONS TO ALL AIR HANDLING EQUIPMENT.
- 35. SUPPORT FOR SUSPENDED EQUIPMENT SHALL INCLUDE APPURTENANCES AS NOTED IN ASHRAE AND REQUIRED IN CODE FOR SEISMIC/SWAY BRACING.
- 36. PROVIDE VOLUME DAMPERS AT ALL GRILLES, REGISTERS, & DIFFUSERS IN ADDITION TO OPPOSED BLADE DAMPERS.
- 37. MOTORIZED DAMPERS SHALL BE CLASS 1 AND HAVE A MAXIMUM LEAKAGE RATE OF 4 CFM/SQUARE FOOT AT 1.0" W.G.
- 38. DDC SYSTEM SHALL HAVE CONTROL POINTS AS REQUIRED FOR THE SEQUENCE OF OPERATIONS. SYSTEM SHALL TREND ALL POINTS AND UTILIZE A DEMAND RESPONSE TO ADJUST
- 39. REFERENCE BUILDING HVAC LOAD CALCULATIONS FOR EQUIPMENT CAPACITIES. NO HUMIDIFICATION PROVIDED. NO SIMULTANEOUS HEATING/COOLING ALLOWED.
- 40. CONTROLS SHALL CLOSE ALL OSA DAMPERS WHEN EQUIPMENT IS NOT RUNNING IN COMPLIANCE WITH C403.2.4.3

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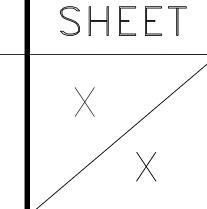
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		PLUMBING FIXTURE SCHEDULE					
ID/NO	FIXTURE	MANUFACTURER/MODEL NUMBERS		PLUMBING CC	NNECTIONS		NOTES
			WASTE	VENT	HW	CW	
P-1	WATER CLOSET	ACORN #2105-W-1-BCN-E500-FVT-SHA FLUSH VALVE: SLOAN HYDRAULIC ROYAL #952-1.6-FW HANGER: VERTICAL COMPACT SUPPORT.	4"	2"	-	1-1/4"	WALL MOUNT
P-1 A	WATER CLOSET ADA	ACORN #2105-W-1-BCN-E500-FVT-SHA FLUSH VALVE: SLOAN HYDRAULIC ROYAL #952-1.6-FW HANGER: VERTICAL COMPACT SUPPORT.	4"	2"	-	1-1/4"	WALL MOUNT
P-2	URINAL ADA	ACORN # 2165-W-1-FV FLUSH VALVE: SLOAN HYDRAULIC ROYAL #995-0.5 HANGER: VERTICAL COMPACT SUPPORT	2"	1-1/2"	1/2"	1/2"	WALL MOUNT
P-3	LAVATORY ADA	ACORN # 1652LRB-1-DMS-04-M-FP FAUCET: CHICAGO #802-665CP	2"	1-1/2"	1/2"	1/2"	WALL MOUNT
P-4	DRINKING FOUNTAIN	HEAVY-DUTY 14 GAUGE TYPE 304 STAINLESS STEEL CONSTRUCTION WITH INTEGRAL MOUNTING PLATES INCLUDE VANDAL-RESISTANT BOTTOM PLATES . HAWS MODEL H1117.8. REMOVE DRAIN TRAP AND WATER BEHIND WALL	2"	1-1/2"		1/2"	WALL MOUNT CANE GUARD
P-5	MOP SINK	FIAT #TSBC-1610 24"x24"x12" DROP FRONT FAUCET: CHICAGO #897-CP, WALL MOUNTED, DRAIN/STRAINER: FIAT COMBINATION DOME STRAINER	3"	2"	3/4"	3/4"	FLOOR MOUNT
P-6	FREEZELESS WALL HYDRANT	QUARTER-TURN, NON-FREEZE WALL HYDRANT WITH INTEGRAL VACUUM BREAKER AND STAINLESS STEEL BOX, LOOSE KEY, HINGED LOCKING COVER, ADJUSTABLE WALL CLAMP, NICKEL-BRONZE BOX FACE; JAY R SMITH 5509QT	-	-	-	3/4"	WALL MOUNT NON-FREEZE
FD	FLOOR DRAIN	JR SMITH MODEL 2005 WITH ROUND NICKEL BRONZE STRAINER, TRAP AND PRIMING CONNECTION.	3"	2"	-	-	FLOOR MOUNT

			E	LECTR	IC WAT	ΓER HEAT	TER SC	HEDU	LE			
ID/NO	MANUFACTURER	MODEL	CAPACITY (GALLONS)	HEIGHT (INCHES)	DIAMETER (INCHES)	DISCHARGE TEMP (DEG F)	MINIMUM EFF	GPH	RECOVERY TEMP RISE	 LECTRICA PHASE	WEIGHT (LBS)	NOTES
WH-1										_		

			EXPA	NSIO	N TANK S	CHEDU	LE		
15/10	055)//05	MANUELOTURED	MODEL		VOLUME (GALLONS)		ISIONS N.)	OPERATING WEIGHT	
ID/NO	SERVICE	MANUFACTURER	MODEL	TANK	ACCEPTANCE	DIAMETER	HEIGHT	(POUNDS)	NOTES
ET-1	WH-1								

			N	1IXING	VALVE	SCHE	DULE				
ID/NO	MANUFACTURER	MODEL	SERVICE	INLET SIZE (INCHES)	OUTLET SIZE (INCHES)	INLET TEMP (°F)	OUTLET TEMP (°F)	MINIMUM FLOW	GPM MAXIMUM FLOW AT SPECIFIED PRESSURE DROP	PRESSURE DROP (PSI)	NOTES
MV-1											

	HOT WATER CIRC. PUMP SCHEDULE													
ID/NO	ID/NO MANUFACTURER MODEL SERVICE TYPE GPM HEAD (FT) HP VOLT/PHASE FLA DISCONNECT BY NOTES													
CP-01														

	EXHAUST FAN SCHEDULE															
UNIT	MANUEACTURER	MODEL	ADEA OFDVED	TVDE		PERFOR	MANCE		POWER (CONNECTION	STARTER		INTERLOCK	SPEED	WEIGHT	NOTEO
NO	MANUFACTURER	MODEL	AREA SERVED	TYPE	CFM	TSP (IN)	RPM	SONES	HP	VOLT/PH	BY E.C.	BY E.C.	MOTORIZED DAMPER	CONTROLLER		NOTES
EF-1	GREENHECK		RESTROOM	ROOF												
EF-2	GREENHECK		RESTROOM	ROOF												
EF-3	GREENHECK		RESTROOM	ROOF												
EF-4	GREENHECK		CUSTODIAL ROOM	ROOF												
EF-5	EF-5 GREENHECK RESTROOM ROOF															
EF-6	GREENHECK		STORAGE ROOM	ROOF												

	WALL HEATER SCHEDULE									
UNIT	MANUFACTURER	MODEL	AREA SERVED	TYPE	POWER CONNECTION			WEIGHT		
NO					VOLT/PH	WATT	SIZE	(POUNDS)	NOTES	
EUH-1			RESTROOM							
EUH-2			RESTROOM							
EUH-3			CUSTODIAL ROOM							

- 1. PROVIDE WALL CAN, GRILL KIT AND BUILT IN THERMOSTAT. MOUNT UNIT PER MANUFACTURER RECOMMENDATION.
- 2. PROVIDE WITH BUILT-IN TAMPER RESISTANT THERMOSTAT AND DISCONNECTION SWITCH

ELECTRIC RADIANT HEATER SCHEDULE										
UNIT	MANUFACTURER	MODEL	AREA SERVED	TYPE	POWER CONNECTION			WEIGHT	NOTES	
NO					VOLT/PH	WATT	SIZE	(POUNDS)	NOTES	
RH-1			STORAGE ROOM							
	-		-							

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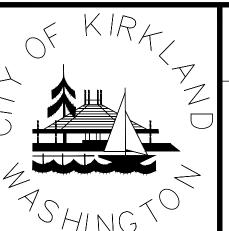


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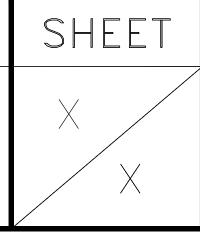
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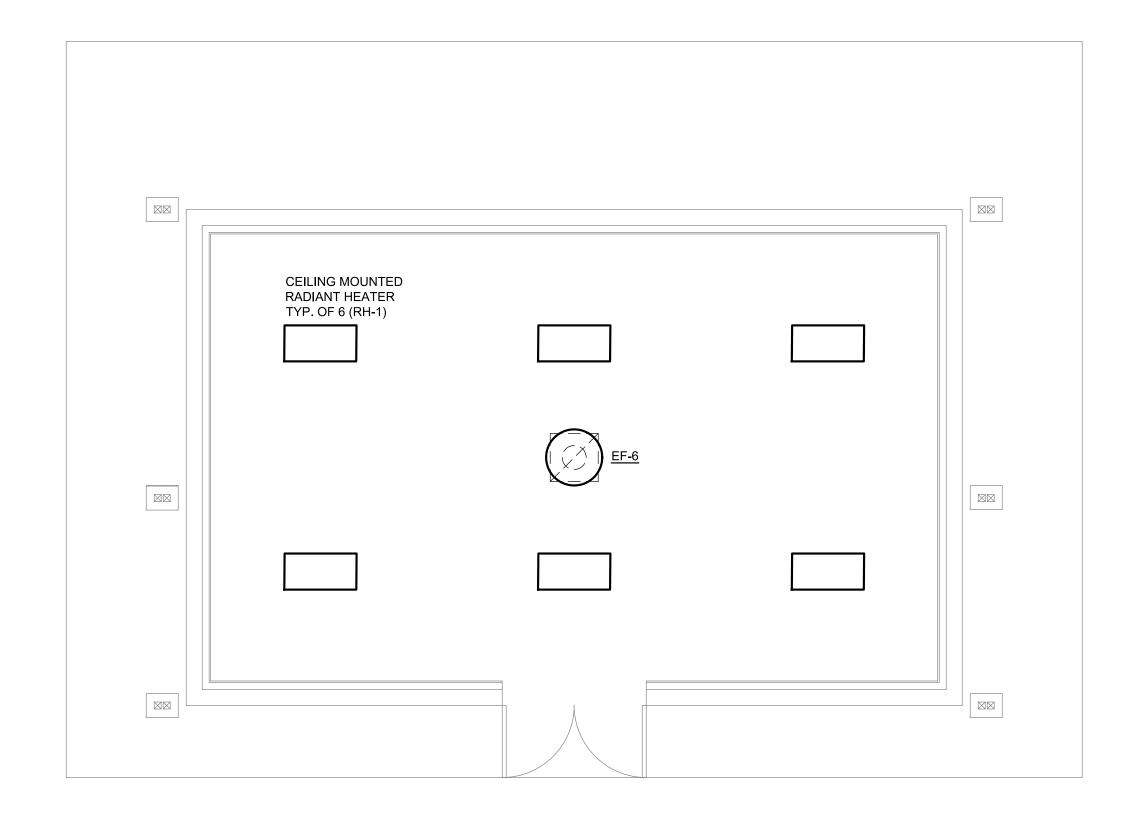


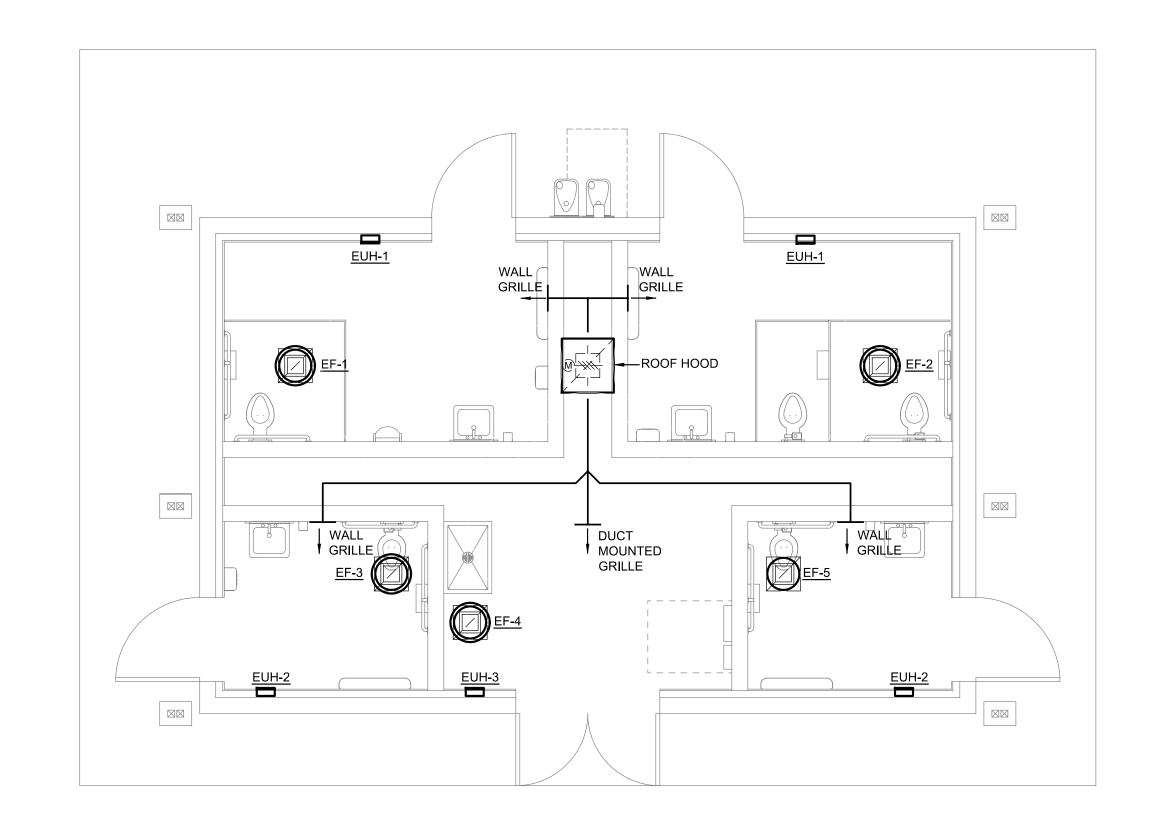
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PRE-FAB STORAGE BUILDING - MECHANICAL PLAN

SCALE: 1/4" = 1'-0"

RESTROOM BUILDING - MECHANICAL PLAN

SCALE: 1/4" = 1'-0"

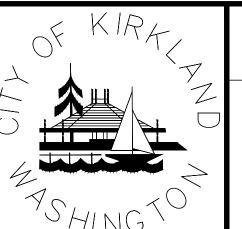
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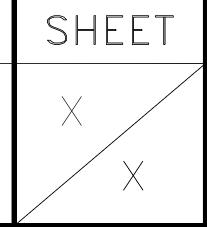


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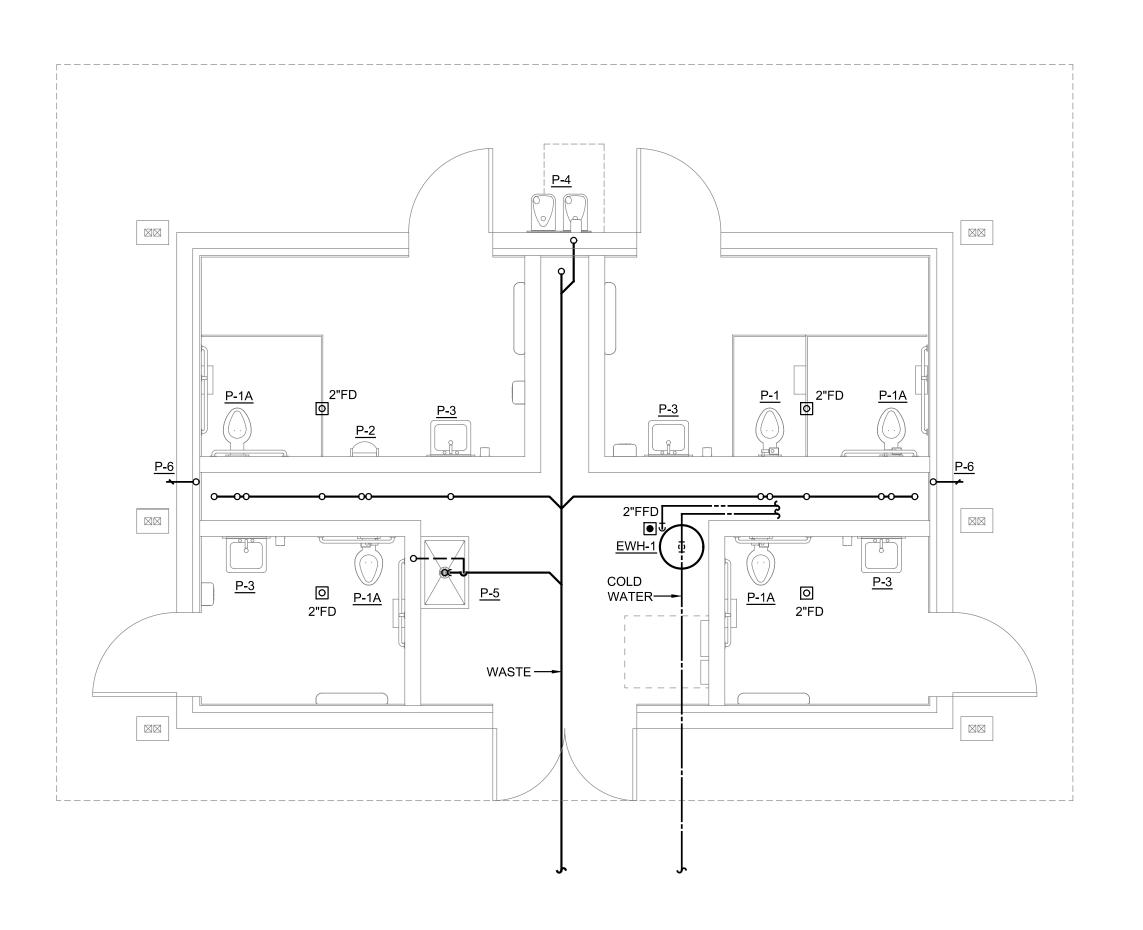
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RESTROOM BUILDING - PLUMBING PLAN

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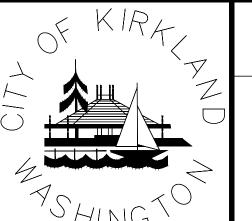
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