



LAKE ST & KIRKLAND AVE PEDESTRIAN IMPROVEMENTS

JOB NO. 62-22-PW CIP NO. TRC1370000 FEDERAL AID NO. HSIP-000S(534)

DECEMBER 2023




CITY OFFICIALS

PENNY SWEET JAY ARNOLD NEAL BLACK KELLI CURTIS AMY FALCONE

CONTACT PERSONNEL

<u>NAME</u>	<u>AGENCY</u>	<u>PHONE</u>
LAURA DRAKE, PE STEVE HOOPES RIK MAYER RYAN FOWLER JASON OSBORN CHUCK SAUNDERS	COK PROJECT ENGINEER COK FIELD REPRESENTATIVE COK FIELD REPRESENTATIVE COK STREETS & GROUNDS DEPT COK SURFACE WATER M&O COK IT	425.587.3833 425.623.5086 206.496.4265 425.587.3909 425.587.3900 425.587.3086
KIARA SKYE BIANCA CRAWFORD MICAH COMER SCOTT CHRISTENSON JASON TESDAL GLEN WILLIAMS CONST. COORDINATOR MATT PALMER	PUGET SOUND ENERGY (ELEC & GAS) COMCAST CABLE ZIPLY VERIZON BUSINESS ZAYO LUMEN NATIONAL KING COUNTY METRO LAKE WASH. SCHOOL DISTRICT	425.213.9205 253.303.2723 830.513.2366 425.471.1079 253.221.7585 503.475.9232 206.684.2732 425.936.1222
EMERGENCY POLICE MAIN LINE FIRE MAIN LINE SPILL RESPONSE HOTLINE UTILITY LOCATES	NORCOM COK COK COK ONE CALL	911 425.587.3400 425.864.3650 425.587.3900 800.424.5555

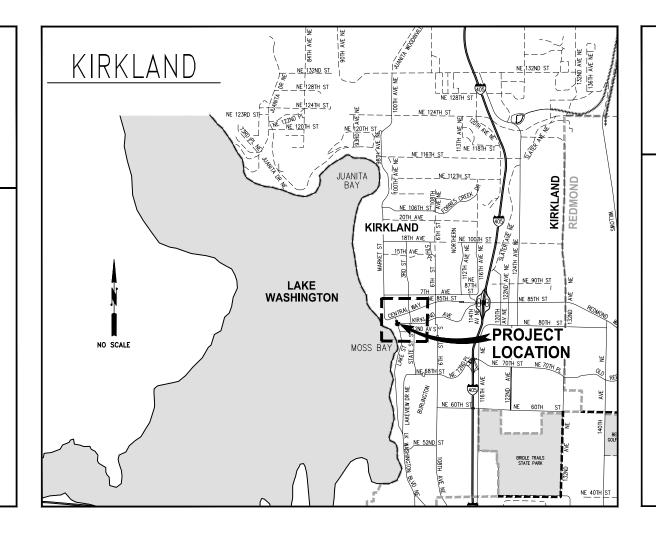


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INDEX OF DRAWINGS

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TREE CRITICAL ROOT ZONE

SIGN WHEEL STOP TRUNCATED DOME ON CEMENT CONC SLAB REMOVE ASPHALT CONCRETE PAVEMENT REMOVE CEMENT CONCRETE DO NOT INCLUDE REMOVAL AREA IF PROPERTY OWNER AGREEMENTS GET REVOKED BRICK PAVERS CEMENT CONC SIDEWALK HMA CL 1/2" PG 58H-22

CEMENT CONC ROADWAY RAMP

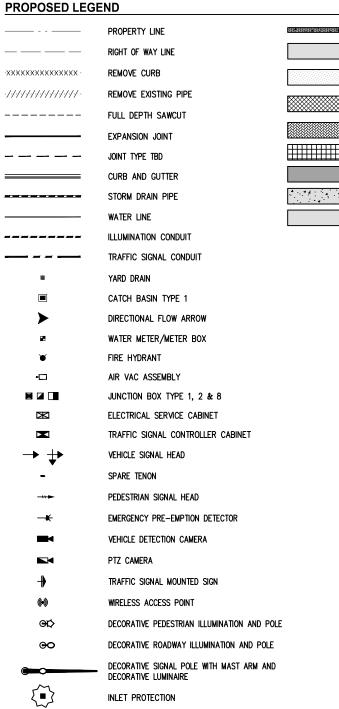RAISED CONC INTERSECTION

ASPHALT/CONCRETE ACP ASPHALT CONCRETE PAVEMENT ADA AMERICANS WITH DISABILITIES ACT ANGLE POINT APPROX APPROXIMATE BLDG BUILDING CB CATCH BASIN CCP CEMENT CONCRETE PAVEMENT CONTROLLED DENSITY FILL CDF CHLK CHAINLINK CENTERLINE CO CLEANOUT CITY OF KIRKLAND COK COLUMN CONC CSBC CSTC DI DUCTILE IRON DIA DIAMETER DW DRIVEWAY EAST OR EASTING ELEV ELEVATION EDGE OF PAVEMENT EOP EW EACH WAY ΕX **EXISTING** EXIST EXISTING FF FINISHED FLOOR

FL

F0

FOC

HMA

ID

MAX

FLOW LINE FIBER OPTIC

FACE OF CURB

HORIZONTAL

HIGH POINT

INCH/INCHES

JUNCTION BOX

LINEAR FEET

LOW POINT

MAXIMUM

MINIMUM

MANHOLE

INSIDE DIAMETER

INVERT ELEVATION

HOT MIX ASPHALT

ABBREVIATIONS

NORTH AMERICAN VERTICAL DATUM NORTHBOUND NO NTS NOT TO SCALE OC ON CENTER OD OUTSIDE DIAMETER POINT OF CURVE PCC POINT OF COMPOUND CURVATURE PCCP PERVIOUS CEMENT CONCRETE PAVEMENT POINT OF INTERSECTION POB POINT OF BEGINNING POE POINT OF ENDING CRUSHED SURFACING BASE COURSE POINT OF REVERSE CURVATURE PΤ POINT OF TANGENT CRUSHED SURFACING TOP COURSE POLYVINYL CHLORIDE OR POINT OF PVC VERTICAL CURVATURE POINT OF VERTICAL TANGENT POINT OF VERTICAL INTERSECTION RADIUS ROW RIGHT OF WAY SLOPE OR SOUTH SB SOUTHBOUND STORM DRAIN SDMH STORM DRAIN MANHOLE SDR STANDARD DIMENSIONAL RATIO SE SOUTHEAST SHT SQ SQUARE SS SANITARY SEWER SSMF SANITARY SEWER MANHOLE STA STATION STANDARD STD STCR STRUCTURE SOUTHWEST SW TYP TYPICAL TOC TOP OF CURB UNDERGROUND VERT VERTICAL WEST YD YARD DRAIN

MONUMENT IN CASE

NORTH OR NORTHING


MECHANICAL JOINT


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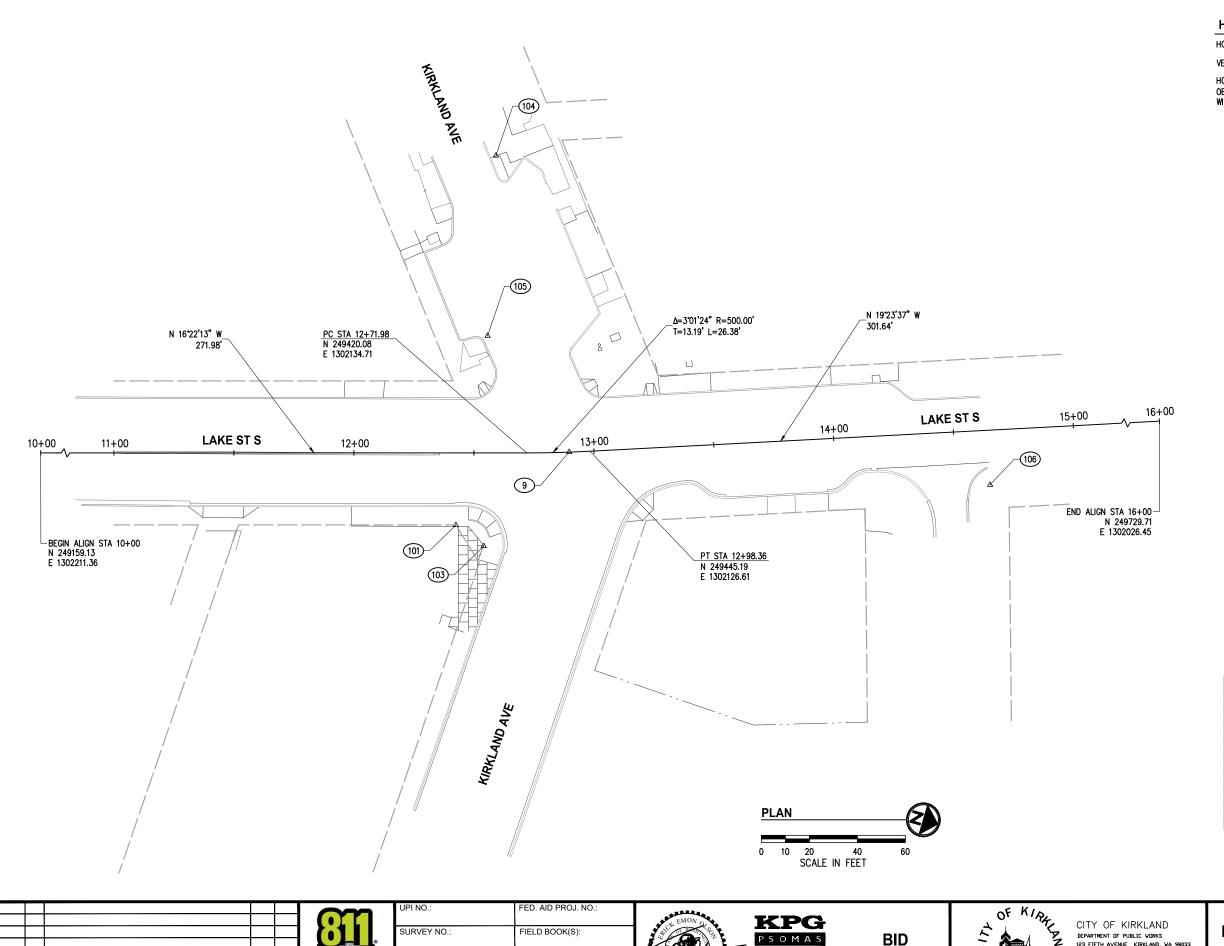


LAKE ST & KIRKLAND AVE CITY OF KIRKLAND PEDESTRIAN IMPROVEMENTS 123 FIFTH AVENUE KIRKLAND, WA 98033

REFERENC

SHEET

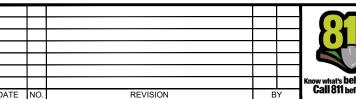LEGEND & ABBREVIATIONS

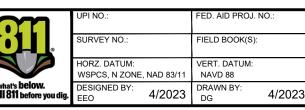

HORIZONTAL AND VERTICAL DATUM

HORIZONTAL DATUM:

NAD 83/11, NORTH ZONE

VERTICAL DATUM

HORIZONTAL AND VERTICAL DATUMS ESTABLISHED BY RTK GPS
OBSERVATION UTILIZING WSRN (WASHINGTON STATE REFERENCE NETWORK)
WITH CHECKS TO CONTROL POINTS BEL 0328 AND BEL 0441

# CONTROL POINT LIST							
PT #	DESCRIPTION	NORTHING	EASTING	ELEVATION			
9	PK	249436.96	1302129.33	33.94'			
100*	PK	249431.13	1302465.37	37.61'			
101	PK/FND	249400.22	1302171.86	33.88'			
103	PK/FND	249413.87	1302177.02	33.67			
104	PK/SET	249372.86	1302019.47	30.62			
105	PK/FND	249390.69	1302092.50	32.55'			
106	PK/FND	249609.08	1302093.04	33.71			

* POINT NOT SHOWN ON PLAN

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Know what's below. Call 811 before you di					
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	UPI NO.:	FED. AID PROJ. NO.:
	SURVEY NO.:	FIELD BOOK(S):
	HORZ. DATUM: WSPCS, N ZONE, NAD 83/11	VERT. DATUM: NAVD 88
_{rhat's} below. I l 811 before you dig.	DESIGNED BY: EEO 4/2023	DRAWN BY: DG 4/202



BID Tacoma 2502 Jefferson Avenue Tacoma, WA 98402 253.627.0720 **DOCUMENT**




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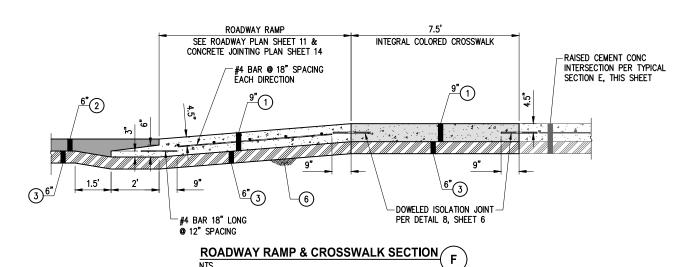
LAKE ST & KIRKLAND AVE **PEDESTRIAN IMPROVEMENTS**

SHEET

REFERENCE SHEET NO.

ALIGNMENT & SURVEY CONTROL PLAN



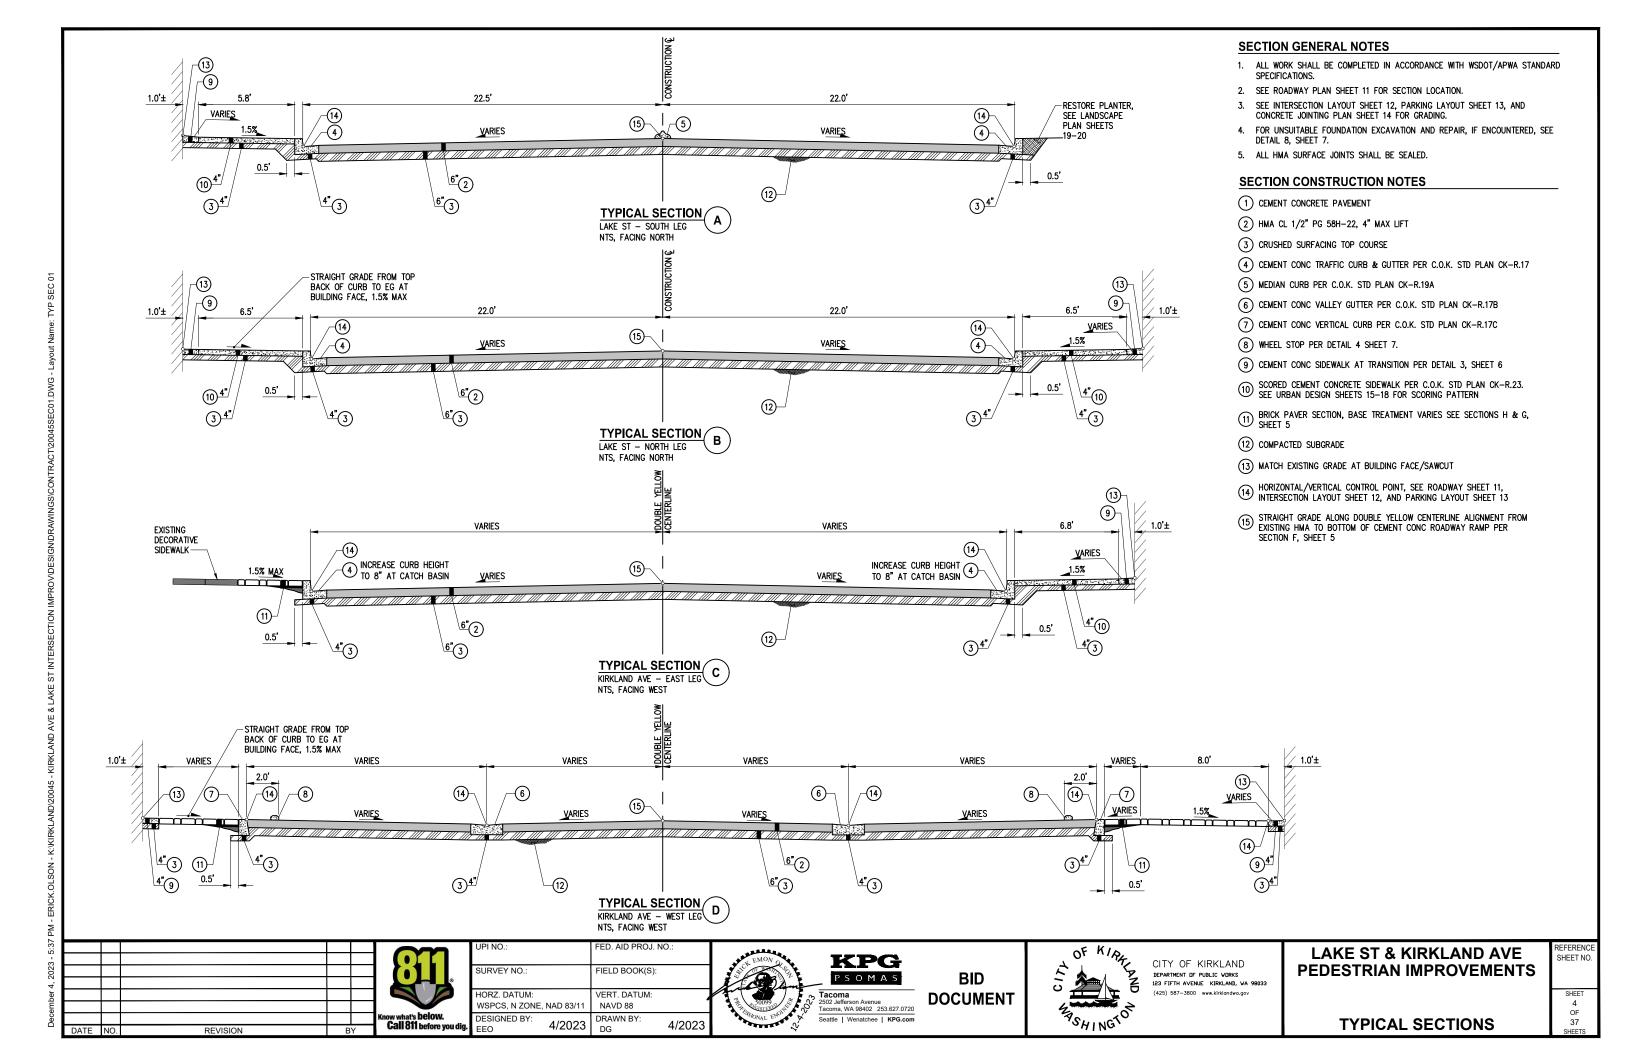


SECTION GENERAL NOTES


- ALL WORK SHALL BE COMPLETED IN ACCORDANCE WITH WSDOT/APWA STANDARD SPECIFICATIONS.
- 2. SEE ROADWAY PLAN SHEET 11 FOR SECTION LOCATION.
- 3. SEE INTERSECTION LAYOUT SHEET 12, PARKING LAYOUT SHEET 13, AND CONCRETE JOINTING PLAN SHEET 14 FOR GRADING.
- 4. FOR UNSUITABLE FOUNDATION EXCAVATION AND REPAIR, IF ENCOUNTERED, SEE DETAIL 8, SHEET 7.
- 5. ALL HMA SURFACE JOINTS SHALL BE SEALED.

SECTION CONSTRUCTION NOTES

- 1) CEMENT CONCRETE PAVEMENT
- 2) HMA CL 1/2" PG 58H-22, 4" MAX LIFT
- (3) CRUSHED SURFACING TOP COURSE
- 4 CEMENT CONC VALLEY CURB PER DETAIL 2, SHEET 6
- $\begin{tabular}{ll} \hline \begin{tabular}{ll} \hline \end{tabular} \end{tabular$
- 6 COMPACTED SUBGRADE
- 7 HORIZONTAL/VERTICAL CONTROL POINT, SEE ROADWAY SHEET 11, INTERSECTION LAYOUT SHEET 12, AND PARKING LAYOUT SHEET 13
- 8 MATCH EXISTING GRADE AT BUILDING FACE/SAWCUT
- (9) CEMENT CONC SIDEWALK AT TRANSITION PER DETAIL 3, SHEET 6
- $\ensuremath{\textcircled{10}}$ radial coated cast iron detectable warning surface on cement concrete slab

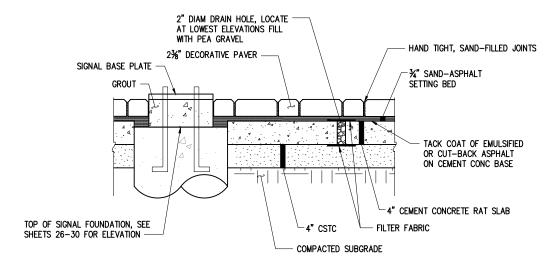



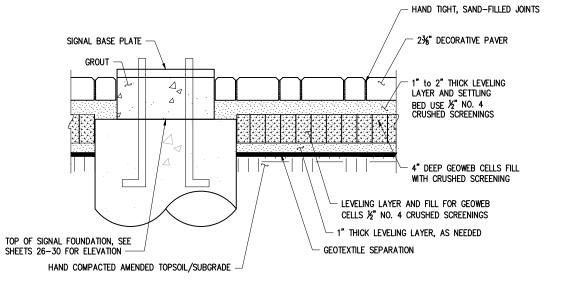

DECORATIVE PAVER WITH POLYETHYLENE WEB SYSTEM SECTION /

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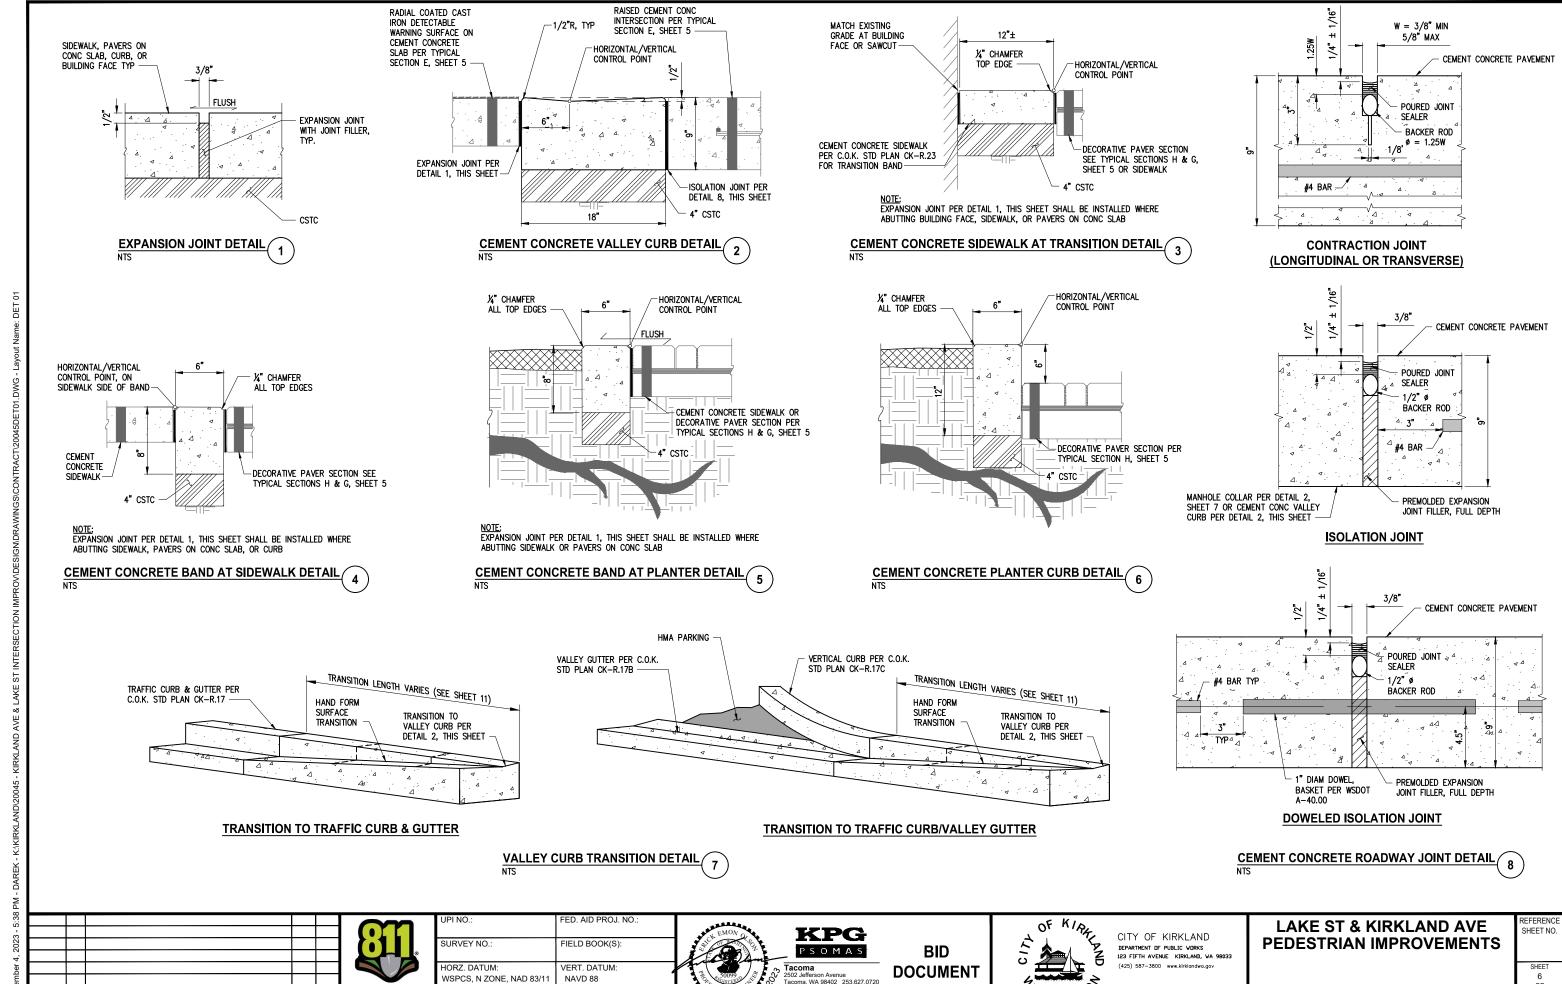
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SHEET NO

TYPICAL SECTIONS

37



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DETAILS

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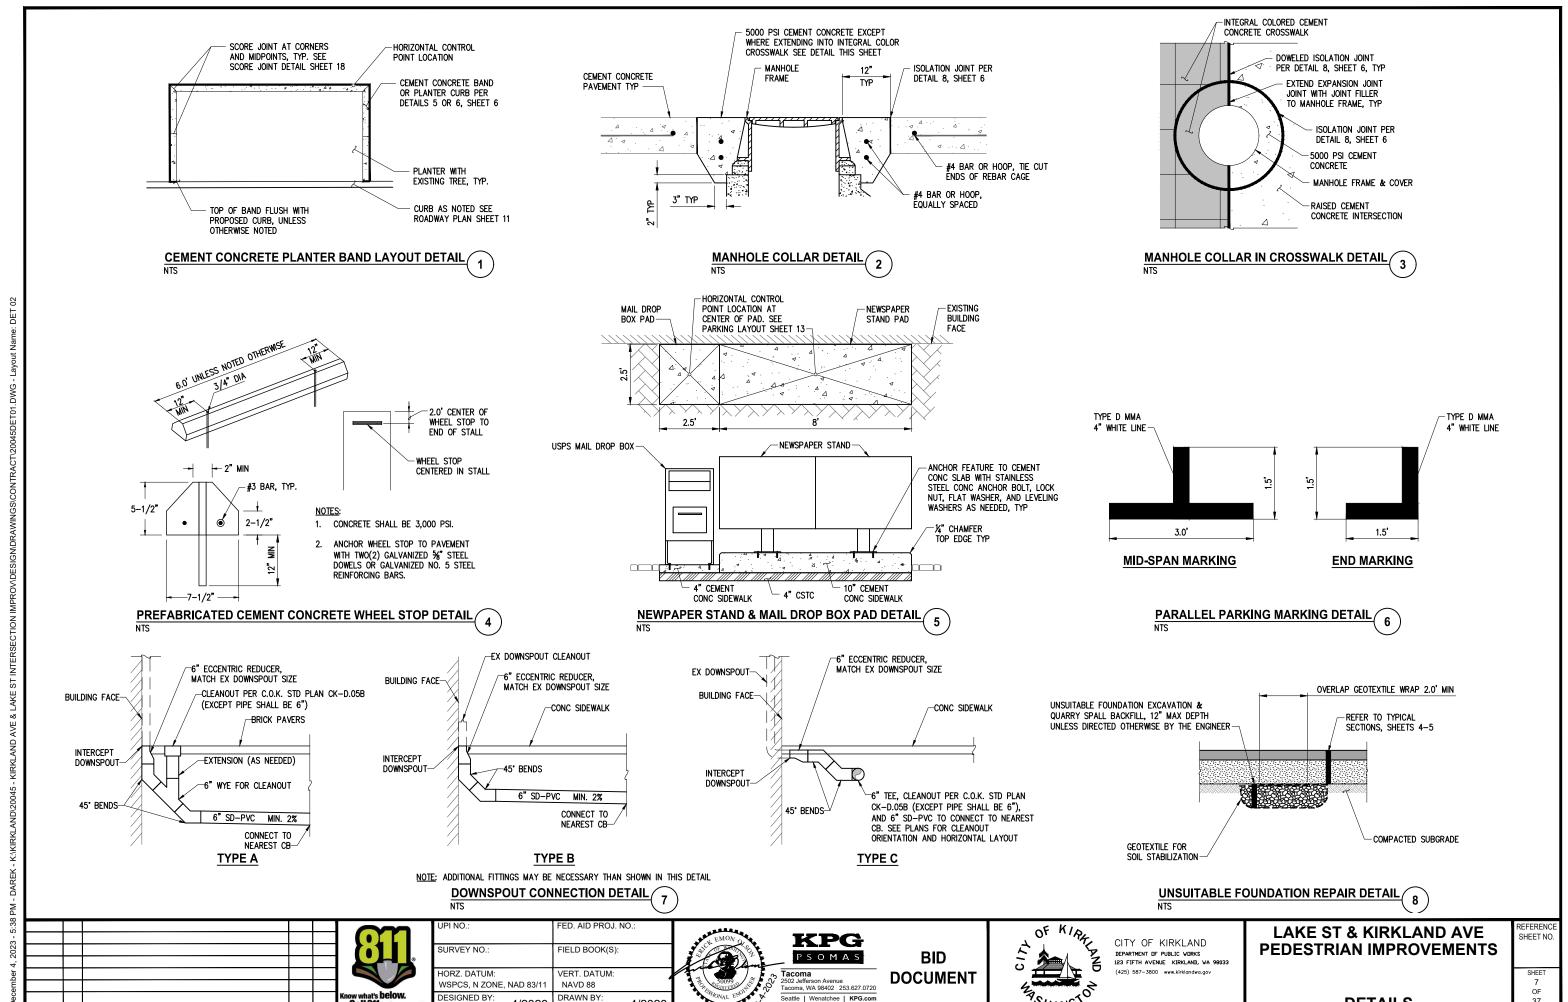
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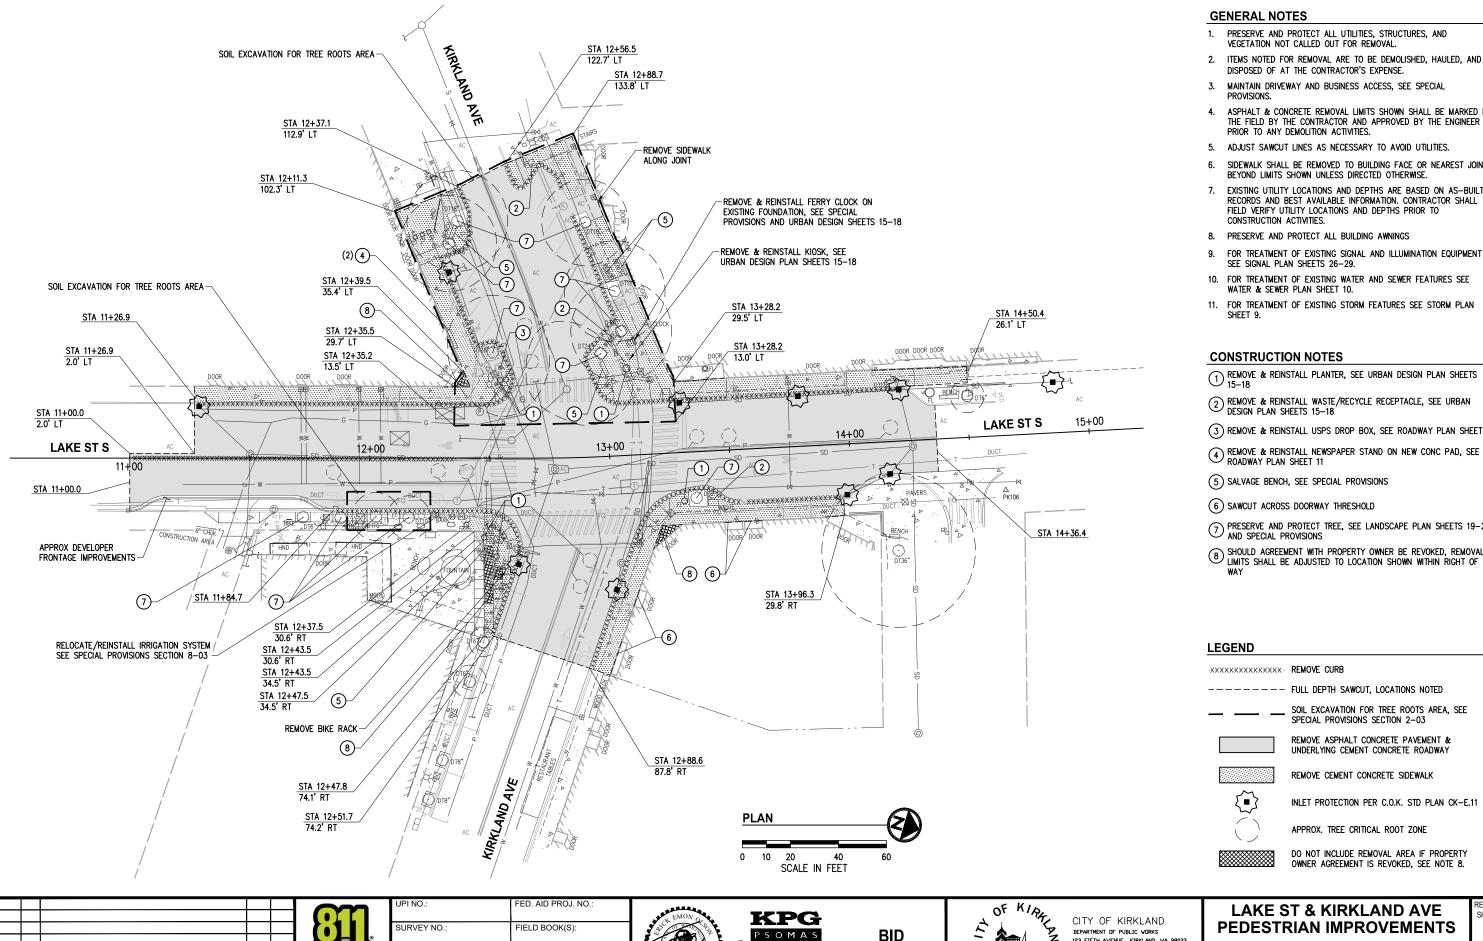
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DETAILS



- PRESERVE AND PROTECT ALL UTILITIES, STRUCTURES, AND
- 2. ITEMS NOTED FOR REMOVAL ARE TO BE DEMOLISHED, HAULED, AND
- 3. MAINTAIN DRIVEWAY AND BUSINESS ACCESS, SEE SPECIAL
- ASPHALT & CONCRETE REMOVAL LIMITS SHOWN SHALL BE MARKED IN THE FIELD BY THE CONTRACTOR AND APPROVED BY THE ENGINEER
- SIDEWALK SHALL BE REMOVED TO BUILDING FACE OR NEAREST JOINT
- 7. EXISTING UTILITY LOCATIONS AND DEPTHS ARE BASED ON AS-BUILT RECORDS AND BEST AVAILABLE INFORMATION. CONTRACTOR SHALL FIELD VERIFY UTILITY LOCATIONS AND DEPTHS PRIOR TO
- FOR TREATMENT OF EXISTING SIGNAL AND ILLUMINATION EQUIPMENT
- 10. FOR TREATMENT OF EXISTING WATER AND SEWER FEATURES SEE WATER & SEWER PLAN SHEET 10.
- 11. FOR TREATMENT OF EXISTING STORM FEATURES SEE STORM PLAN
- \bigodot REMOVE & REINSTALL WASTE/RECYCLE RECEPTACLE, SEE URBAN DESIGN PLAN SHEETS 15–18
- (3) REMOVE & REINSTALL USPS DROP BOX, SEE ROADWAY PLAN SHEET 11
- $\begin{picture}(60,0)\put(0,0){\line(1,0){10}}\put(0,0){\line(1,0){10}$
- \bigcirc Preserve and protect tree, see Landscape plan sheets 19–21 and special provisions
- $\ensuremath{\texttt{8}}$ should agreement with property owner be revoked, removal limits shall be adjusted to location shown within right of

SOIL EXCAVATION FOR TREE ROOTS AREA, SEE SPECIAL PROVISIONS SECTION 2-03

REMOVE ASPHALT CONCRETE PAVEMENT & UNDERLYING CEMENT CONCRETE ROADWAY

REMOVE CEMENT CONCRETE SIDEWALK

INLET PROTECTION PER C.O.K. STD PLAN CK-E.11

DO NOT INCLUDE REMOVAL AREA IF PROPERTY OWNER AGREEMENT IS REVOKED, SEE NOTE 8.

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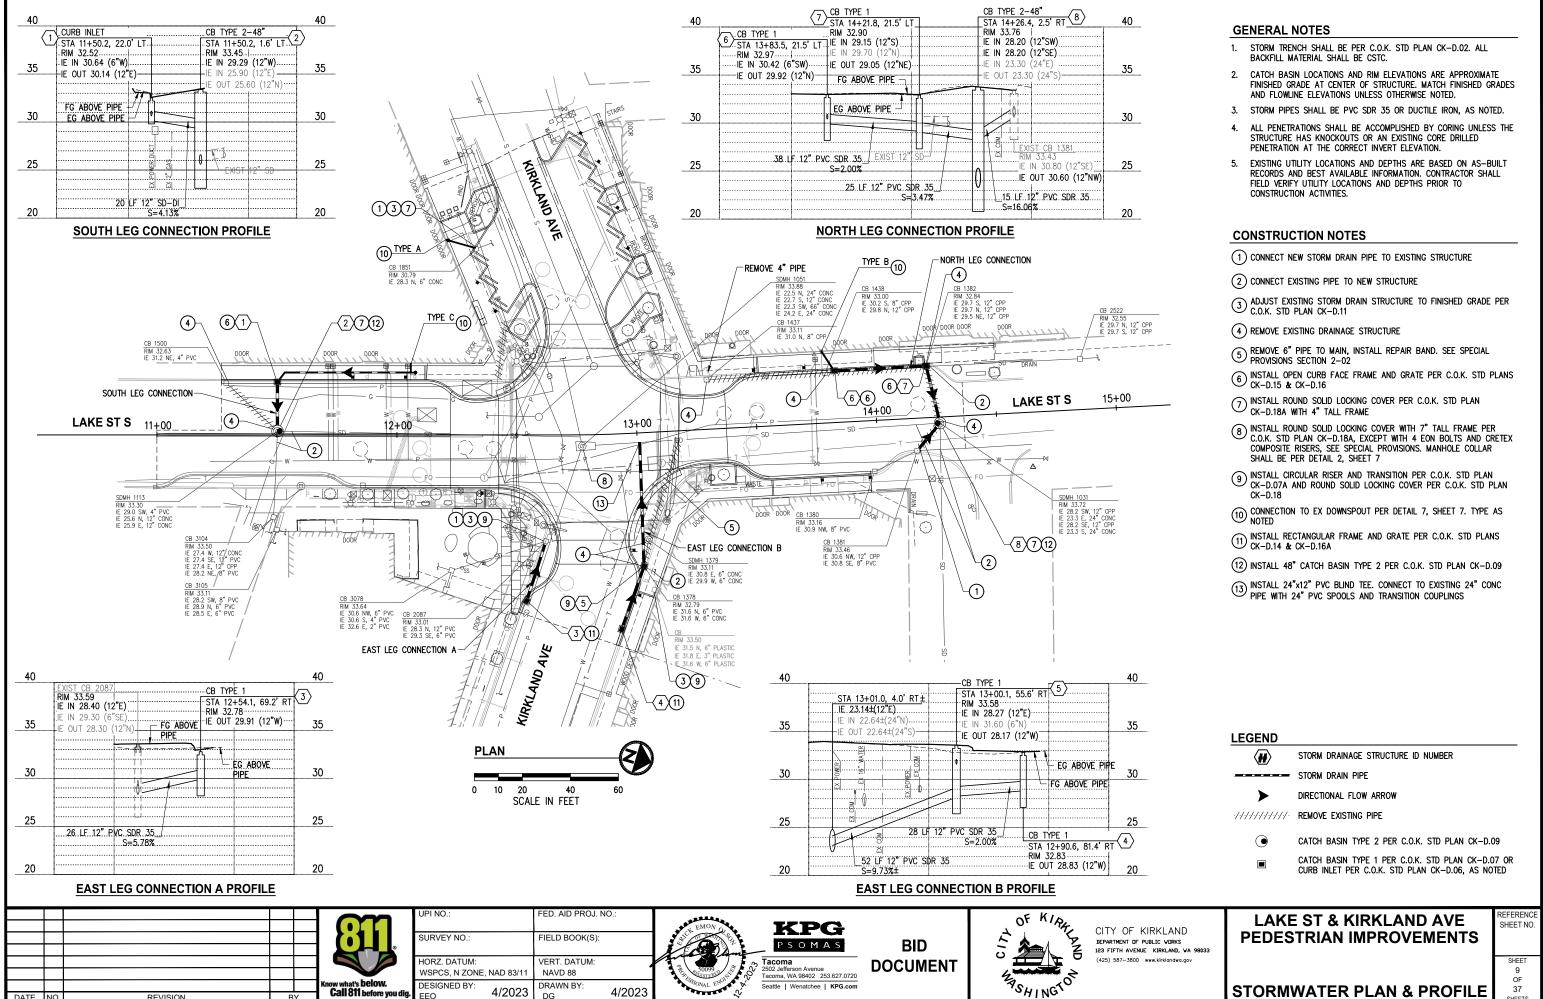
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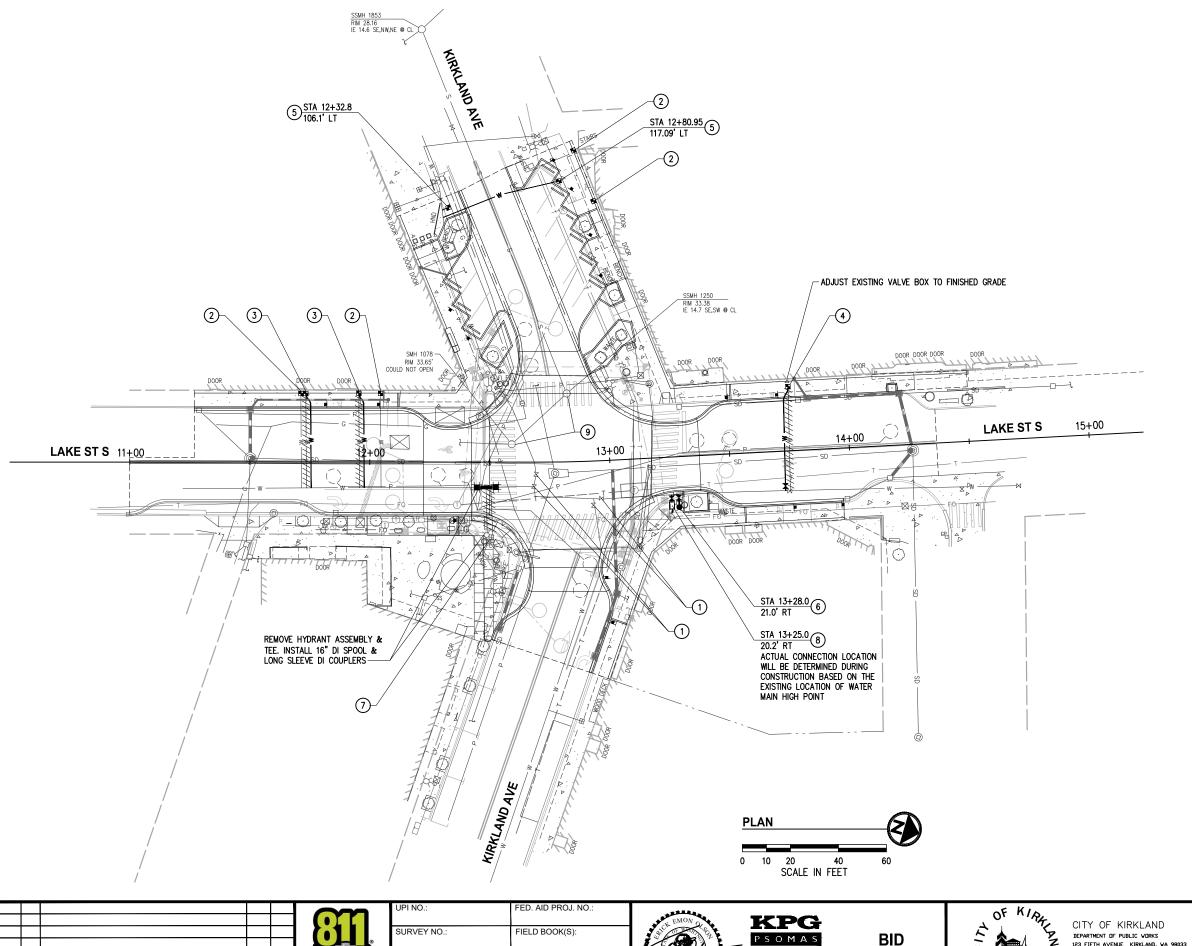
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LAKE ST & KIRKLAND AVE PEDESTRIAN IMPROVEMENTS REFERENC

SITE PREPARATION & TESC PLAN



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EXISTING UTILITY LOCATIONS AND DEPTHS ARE BASED ON AS-BUILT RECORDS AND BEST AVAILABLE INFORMATION. CONTRACTOR SHALL FIELD VERIFY UTILITY LOCATIONS AND DEPTHS PRIOR TO CONSTRUCTION ACTIVITIES.

CONSTRUCTION NOTES

- 1) REMOVE & REPLACE VALVE BOX PER CK-W.35
- 2 REMOVE & REPLACE METER BOX PER C.O.K. STD PLAN CK-W.23
- (3) REMOVE EX CORP STOP AND INSTALL REPAIR BAND AT MAIN, INSTALL NEW 1" SERVICE PER C.O.K. STD PLAN CK-W.18 AND METER BOX PER C.O.K. STD PLAN CK-W.23. REINSTALL EX METER
- 4 REMOVE EX VALVE & SADDLE AND INSTALL REPAIR BAND AT MAIN, INSTALL NEW 1.5" SERVICE PER C.O.K. STD PLAN CK-W.19 AND METER BOX PER C.O.K. STD PLAN CK-W.25. REINSTALL EX METER
- (5) INSTALL NEW 1" SERVICE FOR IRRIGATION SYSTEM PER C.O.K. STD PLAN CK-W.18 AND METER BOX PER C.O.K. STD PLAN CK-W.23, SEE IRRIGATION PLAN SHEETS 22-24
- 6 install new hydrant assembly PER c.o.k. Std Plan CK-W.14 except install 16"x6" tapping tee PER c.o.k. Std Plan CK-W.06 (IN LIEU OF 6" DI TEE)
- 7 REMOVE EXISTING 2" AIR-VAC ASSEMBLY AND INSTALL REPAIR BAND AT MAIN
- 8 INSTALL NEW 2" AIR VAC ASSEMBLY PER C.O.K. STD PLAN CK-W.09, FINAL LOCATION TO BE APPROVED BY ENGINEER
- ADJUST STRUCTURE TO FINISHED GRADE PER C.O.K. STD PLAN
 CK-S.26 EXCEPT COLLAR SHALL BE PER DETAIL 2, SHEET 7; INSTALL ROUND SOLID LOCKING COVER WITH 7" TALL FRAME PER C.O.K. STD PLAN CK-S.16A, EXCEPT WITH 4 EON BOLTS AND CRETEX COMPOSITE RISERS, SEE SPECIAL PROVISIONS

LEGEND

·////////// REMOVE EXISTING LINE PROPOSED WATER SERVICE LINE WATER METER FIRE HYDRANT AIR VAC ASSEMBLY

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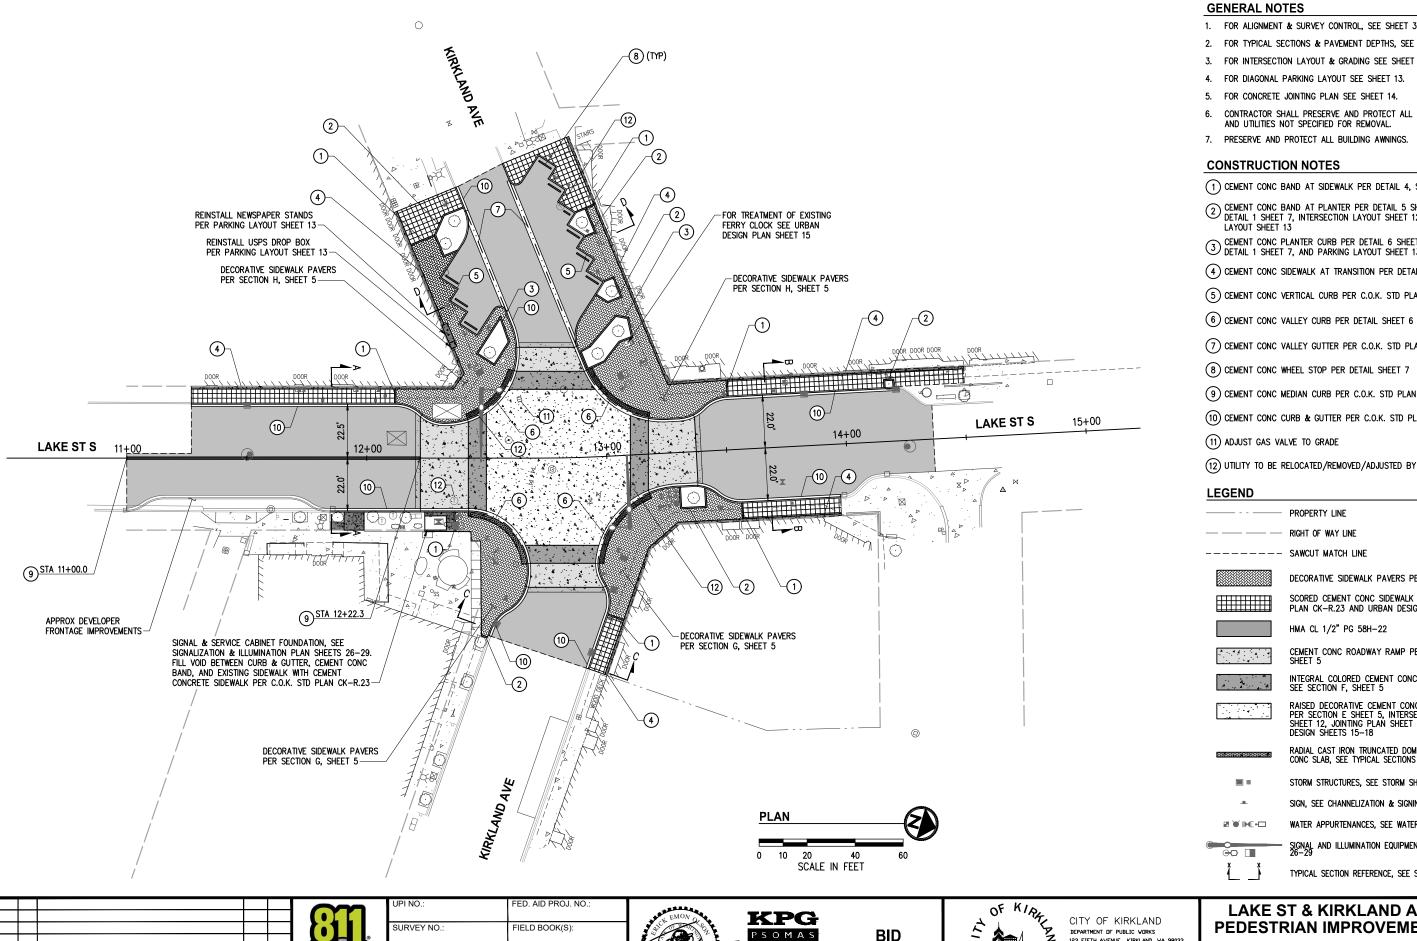
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LAKE ST & KIRKLAND AVE PEDESTRIAN IMPROVEMENTS

SHEET NO SHEET OF 37

REFERENC

WATER & SEWER PLAN



1. FOR ALIGNMENT & SURVEY CONTROL, SEE SHEET 3.

2. FOR TYPICAL SECTIONS & PAVEMENT DEPTHS, SEE SHEETS 4-5.

3. FOR INTERSECTION LAYOUT & GRADING SEE SHEET 12.

CONTRACTOR SHALL PRESERVE AND PROTECT ALL EXISTING FEATURES

1) CEMENT CONC BAND AT SIDEWALK PER DETAIL 4, SHEET 6

(2) CEMENT CONC BAND AT PLANTER PER DETAIL 5 SHEET 6, LAYOUT DETAIL 1 SHEET 7, INTERSECTION LAYOUT SHEET 12, AND PARKING

3 CEMENT CONC PLANTER CURB PER DETAIL 6 SHEET 6, LAYOUT DETAIL 1 SHEET 7, AND PARKING LAYOUT SHEET 13

4 CEMENT CONC SIDEWALK AT TRANSITION PER DETAIL 3. SHEET 6

(5) CEMENT CONC VERTICAL CURB PER C.O.K. STD PLAN CK-R.17C

7 CEMENT CONC VALLEY GUTTER PER C.O.K. STD PLAN CK-R17B

(8) CEMENT CONC WHEEL STOP PER DETAIL SHEET 7

9 CEMENT CONC MEDIAN CURB PER C.O.K. STD PLAN CK-R.19A

10 CEMENT CONC CURB & GUTTER PER C.O.K. STD PLAN CK-R.17

(12) UTILITY TO BE RELOCATED/REMOVED/ADJUSTED BY OTHERS

DECORATIVE SIDEWALK PAVERS PER SECTION NOTED

SCORED CEMENT CONC SIDEWALK PER C.O.K. STD PLAN CK-R.23 AND URBAN DESIGN SHEETS 15-18

HMA CL 1/2" PG 58H-22

CEMENT CONC ROADWAY RAMP PER SECTION F SHEET 5

INTEGRAL COLORED CEMENT CONCRETE CROSSWALK, SEE SECTION F, SHEET $5\,$

RAISED DECORATIVE CEMENT CONC INTERSECTION PER SECTION E SHEET 5, INTERSECTION LAYOUT SHEET 12, JOINTING PLAN SHEET 14, AND URBAN DESIGN SHEETS 15—18

RADIAL CAST IRON TRUNCATED DOME PAD ON CEMENT CONC SLAB, SEE TYPICAL SECTIONS SHEET 4

STORM STRUCTURES, SEE STORM SHEET 9

SIGN, SEE CHANNELIZATION & SIGNING SHEET 25

WATER APPURTENANCES, SEE WATER SHEET 10

SIGNAL AND ILLUMINATION EQUIPMENT, SEE SHEETS

TYPICAL SECTION REFERENCE, SEE SHEET 4

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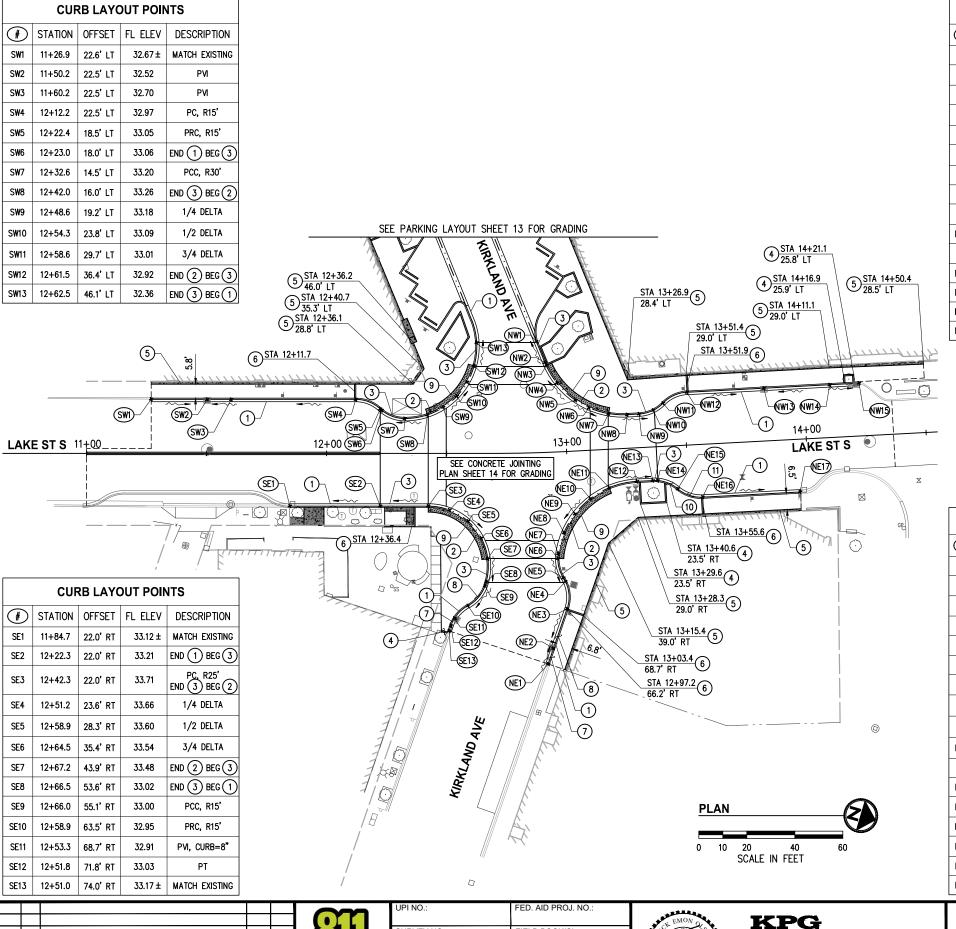
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LAKE ST & KIRKLAND AVE PEDESTRIAN IMPROVEMENTS

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REFERENC

ROADWAY PLAN



	CURB LAYOUT POINTS						
#	STATION	OFFSET	FL ELEV	DESCRIPTION			
NW1	12+89.0	46.3' LT	32.61	BEG 3			
NW2	12+92.5	37.4' LT	33.45	PC, R35'			
NW3	12+93.0	36.2' LT	33.57	END 3 BEG 2			
NW4	12+97.4	28.7' LT	33.62	1/4 DELTA			
NW5	13+04.9	21.1' LT	33.67	PVI			
NW6	13+10.3	17.7' LT	33.62	3/4 DELTA			
NW7	13+18.3	14.9' LT	33.56	END 2 BEG 3			
NW8	13+26.0	14.0' LT	33.42	PT			
NW9	13+31.0	14.0' LT	33.32	PC, R15'			
NW10	13+37.0	15.2' LT	33.18	END 3 BEG 1			
NW11	13+41.2	18.0' LT	33.15	PRC, R15'			
NW12	13+51.4	22.0' LT	33.10	PT			
NW13	13+83.5	22.0' LT	32.94	PVI			
NW14	14+10.9	22.0' LT	33.08	PVI			
NW15	14+23.2	22.0' LT	32.96 ±	MATCH EXISTING			

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- 1. FOR TYPICAL SECTIONS AND PAVEMENT DEPTHS SEE SHEET 4.
- 2. FOR CONCRETE JOINTING PLAN SEE SHEET 14.
- 3. FOR PARKING LAYOUT SEE SHEET 13.
- 4. STRAIGHT GRADE HMA ROADWAY FROM SAWCUT TO CEMENT CONCRETE ROADWAY RAMP ALONG CONSTRUCTION CENTERLINE OR DOUBLE YELLOW CENTERLINE UNLESS OTHERWISE NOTED.

CONSTRUCTION NOTES

- ① CURB & GUTTER PER C.O.K. STD PLAN CK-R.17. CURB HEIGHT SHALL BE PER STD PLAN UNLESS OTHERWISE NOTED
- 2 CEMENT CONC VALLEY CURB PER DETAIL 2, SHEET 6
- (3) VALLEY CURB TRANSITION PER DETAIL 7, SHEET 6
- (4) CEMENT CONC BAND AT PLANTER PER DETAIL 5, SHEET 6 AND LAYOUT DETAIL 1, SHEET 7
- (5) CEMENT CONC SIDEWALK AT TRANSITION PER DETAIL 3, SHEET 6
- (6) CEMENT CONC BAND AT SIDEWALK PER DETAIL 4, SHEET 6
- 7 TRANSITION FROM 8" CURB AT CB TO MATCHING EXISTING CURB AT SAWCUT LOCATION
- (8) TRANSITION FROM 8" CURB AT CB TO 6" CURB AT BOTTOM OF ROADWAY RAMP
- $\begin{tabular}{lll} \end{tabular}$ Radial detectable warning surface on cement conc slab per typical section E, sheet 5
- TRANSITION FROM 6" CURB AT BOTTOM OF ROADWAY RAMP (POINT #NE14) TO 5" CURB AT PRC (POINT #NE15)
- 11) TRANSITION FROM 5" CURB AT PRC (POINT #NE15) TO 6" CURB AT PT (POINT #NE16)

	CURB LAYOUT POINTS						
#	STATION	OFFSET	FL ELEV	DESCRIPTION			
NE1	12+89.3	88.1' RT	32.97±	MATCH EXISTING			
NE2	12+91.4	81.7' RT	32.83	PVI, CURB=8"			
NE3	12+96.9	65.5' RT	32.97	PC, R15'			
NE4	12+96.8	54.1' RT	33.05	END 1 BEG 3			
NE5	12+96.1	52.6' RT	33.12	PRC, R15'			
NE6	12+94.4	44.4' RT	33.54	END 3 BEG 2			
NE7	12+94.6	42.4' RT	33.55	PCC, R35'			
NE8	12+97.2	33.8' RT	33.60	1/4 DELTA			
NE9	13+02.1	26.2' RT	33.64	1/2 DELTA			
NE10	13+08.8	20.1' RT	33.69	3/4 DELTA			
NE11	13+16.9	16.0' RT	33.74	END 2 BEG 3			
NE12	13+28.6	14.0' RT	33.53	PT			
NE13	13+35.2	14.0' RT	33.42	PC, R15'			
NE14	13+37.3	14.1' RT	33.37	END 3 BEG 1			
NE15	13+45.4	18.0' RT	33.33	PRC, R15'			
NE16	13+55.6	22.0' RT	33.27	PT			
NE17	13+96.2	22.0' RT	33.10 ±	MATCH EXISTING			

CITY OF KIRKLAND

123 FIFTH AVENUE KIRKLAND, WA 98033

LAKE ST & KIRKLAND AVE PEDESTRIAN IMPROVEMENTS

SHEET 12 OF

REFERENC

INTERSECTION LAYOUT PLAN

Know what's below.

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UPI NO.: FED. AID PROJ. NO.:

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HORZ. DATUM: VERT. DATUM: NAVD 88


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CURB LAYOUT POINTS



GENERAL NOTES

- 1. FOR SECTION & PAVEMENT DEPTHS SEE TYPICAL SECTION D, SHEET 4.
- 2. FOR INTERSECTION LAYOUT & GRADING SEE SHEET 12.
- 3. PRESERVE & PROTECT ALL TREES, SEE LANDSCAPE PLAN SHEETS 19-20 AND SPECIAL PROVISIONS FOR REQUIREMENTS.


CONSTRUCTION NOTES

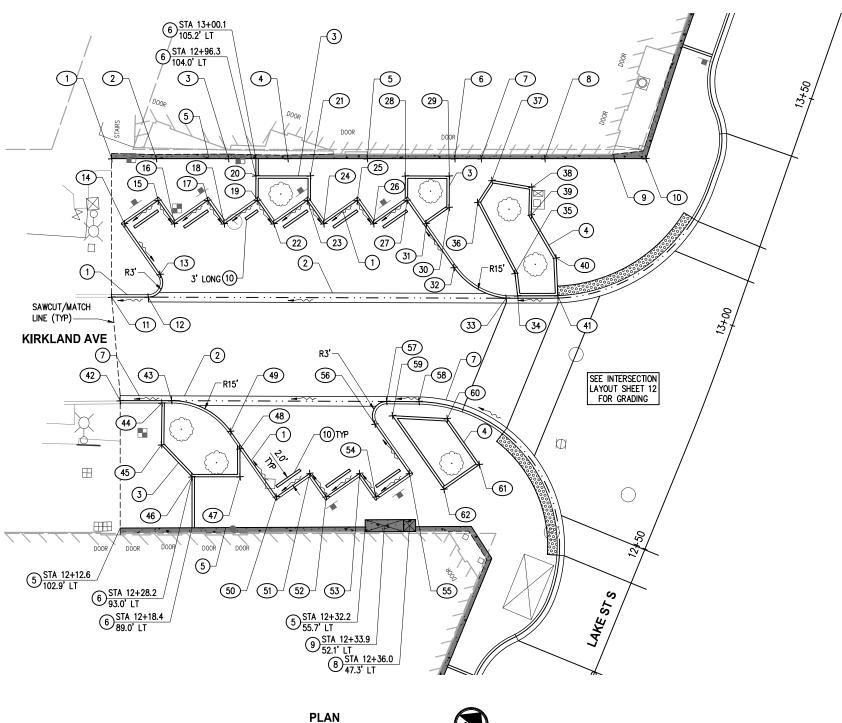- 1) VERTICAL CURB PER C.O.K. STD PLAN CK-R.17C
- 2 VALLEY GUTTER PER C.O.K. STD PLAN CK-R17B
- 3 CEMENT CONC BAND AT PLANTER PER DETAIL 5, SHEET 6 AND LAYOUT DETAIL 1, SHEET 7
- $\begin{picture}(4)\put(0.05)(0$
- (5) CEMENT CONC SIDEWALK AT TRANSITION PER DETAIL 3, SHEET 6
- (6) CEMENT CONC BAND AT SIDEWALK PER DETAIL 4, SHEET 6
- (7) CEMENT CONC CURB & GUTTER PER C.O.K. STD PLAN CK-R.17
- (8) MAIL DROP BOX PAD PER DETAIL 5, SHEET 7
- (9) NEWSPAPER STAND PAD PER DETAIL 5, SHEET 7
- (10) WHEEL STOP PER DETAIL 4, SHEET 7

CURB LAYOUT POINTS								
#	STATION	OFFSET	ELEV	DESCRIPTION				
42	12+37.2	112.9' LT	30.40±	MATCH EXIST (7)				
43	12+41.3	103.0' LT	30.68	FLOWLINE 2 7 PC 1 ,TOC EL 30.26				
44	12+40.0	104.7' LT	31.21	AP (3)				
45	12+32.0	101.5' LT	31.35	AP ③				
46	12+28.2	93.0' LT	31.50	AP (3)				
47	12+32.0	83.8' LT	31.63	AP ③				
48	12+37.4	86.0' LT	31.60	AP (3)				
49	12+40.0	89.2' LT	31.52	PT (1)				
50	12+31.0	75.2' LT	31.95	AP (1)				
51	12+38.1	70.6' LT	32.12	AP (1)				
52	12+34.9	65.6' LT	32.31	AP (1)				
53	12+42.1	61.0' LT	32.49	AP (1)				
54	12+38.8	56.0' LT	32.68	AP (1)				
55	12+46.0	51.4' LT	32.86	AP (1)				
56	12+52.8	61.9' LT	32.55	PC 1				
57	12+58.1	61.4' LT	31.91	FLOWLINE 2 7 PT 1 ,TOC EL 32.33				
58	12+60.6	55.2' LT	32.10	PC (7)				
59	12+55.8	59.2' LT	33.06	AP 4				
60	12+59.5	48.4' LT	33.32	AP 4				
61	12+53.2	38.6' LT	33.56	AP 4				
62	12+45.7	43.5' LT	33.59	AP (4)				

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SCALE IN FEET

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CITY OF KIRKLAND

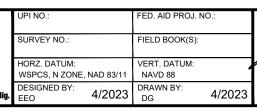DEPARTMENT OF PUBLIC VORKS

123 FIFTH AVENUE KIRKLAND, VA 98033


LAKE ST & KIRKLAND AVE PEDESTRIAN IMPROVEMENTS

SHEET 13 OF 37

REFERENC

SHEET NO

PARKING LAYOUT PLAN

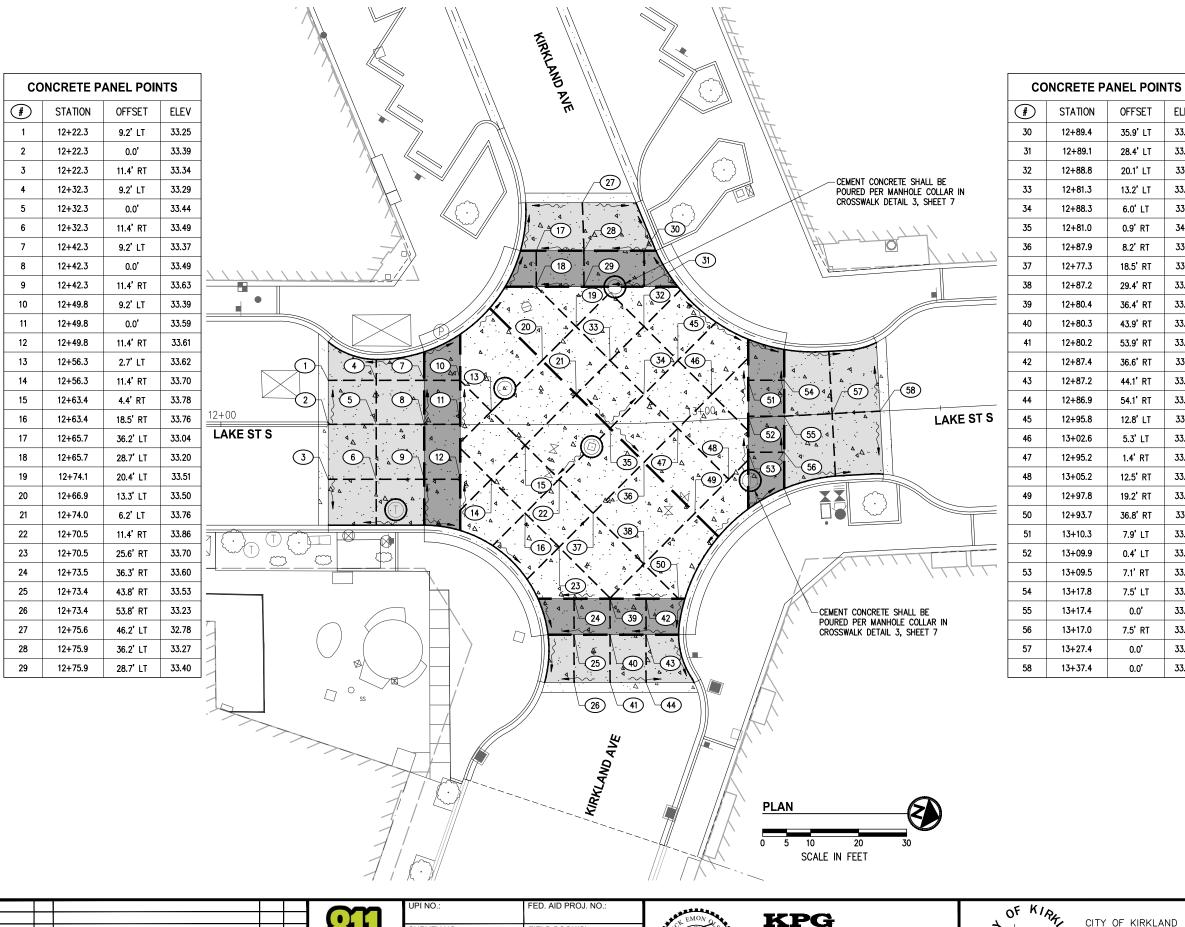

ELEV

33.56

33.56

33.71

33.75

33.91

34.01

33.91 33.81

33.69

33.63

33.55

33.39

33.61

33.56

33.28

33.81

33.88

33.97

33.82

33.76

33.61

33.82

33.94

33.87

33.75

33.93

33.85

33.76

33.57

OFFSET

35.9' LT

28.4' LT

20.1' LT

13.2' LT

6.0' LT

0.9' RT

8.2' RT

18.5' RT

29.4' RT

36.4' RT

43.9' RT

53.9' RT

36.6' RT

44.1' RT

54.1' RT

12.8' LT

5.3' LT

1.4' RT

12.5' RT

19.2' RT

7.9' LT

7.1' RT

7.5' LT

7.5' RT

0.0'

0.0'

STATION

12+89.4

12+89.1

12+88.8

12+81.3

12+88.3

12+81.0

12+87.9

12+77.3

12+87.2

12+80.4

12+80.3

12+80.2

12+87.4

12+87.2

12+86.9

12+95.8

13+02.6

12+95.2

13+05.2

12+97.8

12+93.7

13+10.3

13+09.9

13+09.5

13+17.8

13+17.4

13+17.0

13+27.4

13+37.4

- CONCRETE PANEL JOINT LAYOUT IS FOR REFERENCE ONLY. CONTRACTOR TO SUBMIT PLACING AND JOINTING PLAN TO ENGINEER FOR APPROVAL PRIOR TO CONSTRUCTING FORMS, ALIGN PROPOSED PANEL JOINTS WITH URBAN DESIGN DECORATIVE SCORING LAYOUT. SEE URBAN DESIGN PLAN SHEETS 15-18 FOR SCORE JOINT LAYOUT
- CLEAN JOINTS BY SAWCUT OR HAND TOOL. NO RADIUS ON EDGE. NO SMOOTH FLANGE TOOLING ON EITHER SIDE OF JOINT.
- LENGTH TO WIDTH RATIO BETWEEN JOINTS SHALL NOT EXCEED 1.5:1. JOINT SPACING SHALL NOT EXCEED 15'.
- CONCRETE PANELS TO BE FLUSH WITH ADJACENT CONCRETE PANELS WITH VERTICAL TOLERANCES LESS THAN 1/4"

LEGEND	
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EXPANSION JOINT PER CEMENT CONC ROADWAY JOINT DETAIL SHEET 6

DOWELED EXPANSION JOINT PER CEMENT CONC ROADWAY JOINT DETAIL SHEET 6

CONTRACTION JOINT PER CEMENT CONC ROADWAY JOINT DETAIL SHEET 6

CEMENT CONC ROADWAY RAMP PER SECTION F, SHEET 5

INTEGRAL COLORED CEMENT CONC CROSSWALK PER SECTION F, SHEET 5

RAISED CEMENT CONCRETE INTERSECTION PER SECTION E, ΄, Δ

REVISION

URVEY NO.: FIELD BOOK(S): HORZ, DATUM: VERT. DATUM: WSPCS, N ZONE, NAD 83/11 NAVD 88 DESIGNED BY: DRAWN BY: EEO



4/2023

PSOMAS BID DOCUMENT Tacoma, WA 98402 253.627.0720




CITY OF KIRKLAND 123 FIFTH AVENUE KIRKLAND, WA 98033

LAKE ST & KIRKLAND AVE PEDESTRIAN IMPROVEMENTS

REFERENC

CONCRETE JOINTING PLAN

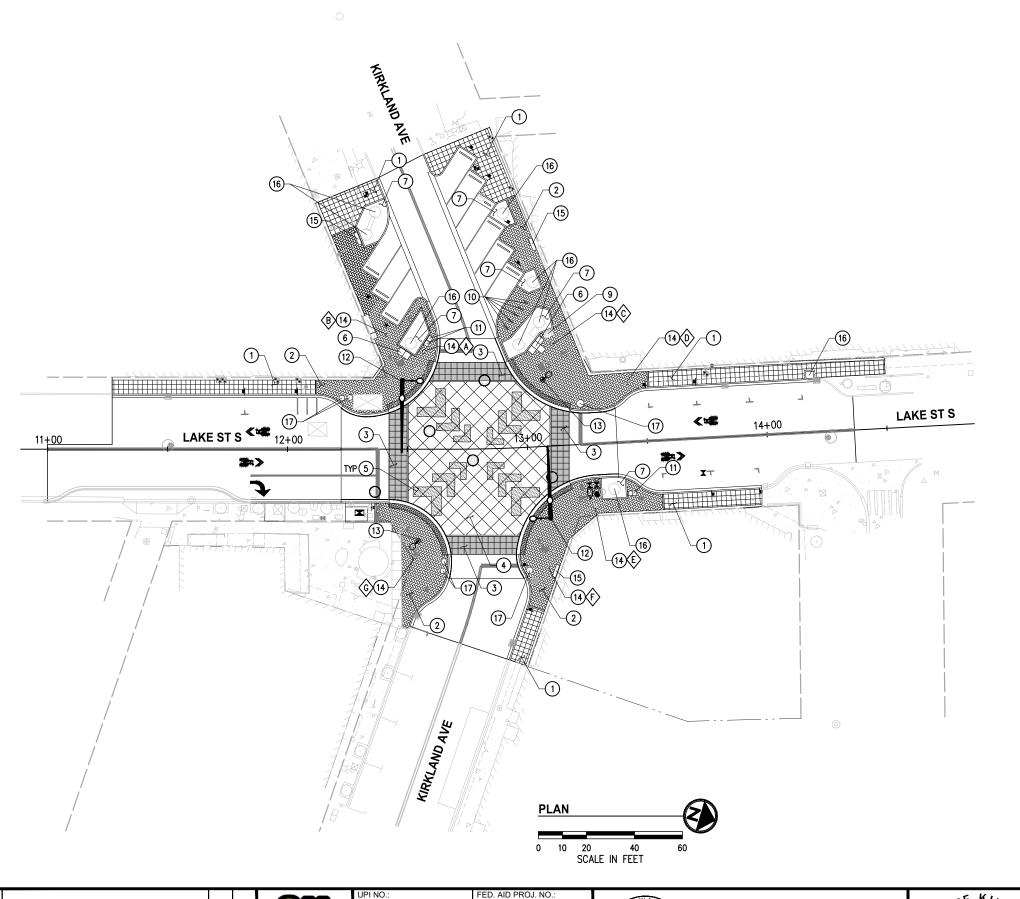

- EXISTING PLANTER POTS TO BE REMOVED, SALVAGED, AND STORED BY CONTRACTOR, SEE SITE PREPARATION SHEET 8. REINSTALL TO LOCATIONS AS SPECIFIED ON PLANS.
- 2. ALL STATION/OFFSETS ARE CENTER OF URBAN DESIGN FEATURE, UNLESS OTHERWISE NOTED.

CONSTRUCTION NOTES

- 1) SCORED CEMENT CONC SIDEWALK, SEE DETAIL SHEET 18.
- 2 DECORATIVE PAVERS, SEE DETAIL SHEET 7.
- $\ensuremath{ \begin{tabular}{lll} \begin{tabular}$
- $\begin{picture}(60,0)\put(0,0){\line(0,0){10}}\put(0,0){\line(0,0){10}$
- 5 DECORATIVE SURFACE TREATMENT, SEE DETAIL SHEET 18.
- 6 BLOCK BENCH, SEE DETAIL SHEET 16.
- 7 PLANTING AREA, SEE LANDSCAPE PLANS SHEET 19.
- (9) HISTORIC CLOCK, SAVE AND PROTECT EXISTING FOUNDATION, REMOVE CLOCK AND STORE DURING CONSTRUCTION. REINSTALL ON EXISTING FOUNDATION.
- 10 BIKE RACK, SEE DETAIL SHEET 16.
- (11) REINSTALL WASTE/RECYCLE RECEPTACLE.
- $\stackrel{\hbox{\scriptsize (12)}}{}$ decorative signal pole with mast arm and decorative roadway luminaire, see sheets 26–29.
- (13) DECORATIVE PEDESTRIAN LUMINAIRE AND POLE, SEE SHEETS 26-29.
- DECORATIVE MEDALLION INLAY, SEE DETAIL, SHEET 16 & SHEET 17 (7).
- (15) STANDARD BENCH, SEE DETAIL SHEET 16.
- $\ensuremath{\textcircled{16}}$ Preserve & protect existing tree, see Landscape plan sheets 19–20.
- (17) RELOCATE EXISTING PLANTER PLOT.


STANDARD BENCH SCHEDULE				
STATION	OFFSET			
13+09.2	52.0' RT			
13+06.5	84.3' LT			
12+29.2	87.8' LT			

13+06.5	84,3' LT		12+41.5	47.6' L
10.00.0	04.0 2.1	4	12+56.8	40.7 L
12+29.2	87.8' LT			
			12+53.0	45.1' R
			13+05.6	50.5' R
			13+05.6	50.5 K
BLOCK BENC	H SCHEDULE		13+27.1	26.1' R
STATION	OFFSET		13+42.0	24.5' L
			10.42.0	24.0 L
13+05.7	42.3' LT		13+15.8	41.2 L
			L	

DECORATIVE MEDALLION INLAY SCHEDULE			WASTE/R RECEPTACLE	
STATION OFFSET			STATION	OFFSET
12+41.5	47.6' LT		13+19.4	17.2' RT
12+56.8	40.7' LT		13+21.6	16.5' RT
12+53.0	45.1' RT	,		
13+05.6	50.5' RT			

PLANTER SCHEDULE				
STATION	OFFSET			
12+25.9	21.5' LT			
12+22.6	21.3' LT			
13+22.9	17.1' LT			
12+98.3	51.3' RT			
12+65.2	46.9' RT			
12+64.8	50.8' RT			

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Gall 811 before you d	Υ	В	N	REVISION	NO.	DATE

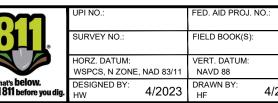












LAKE ST & KIRKLAND AVE PEDESTRIAN IMPROVEMENTS

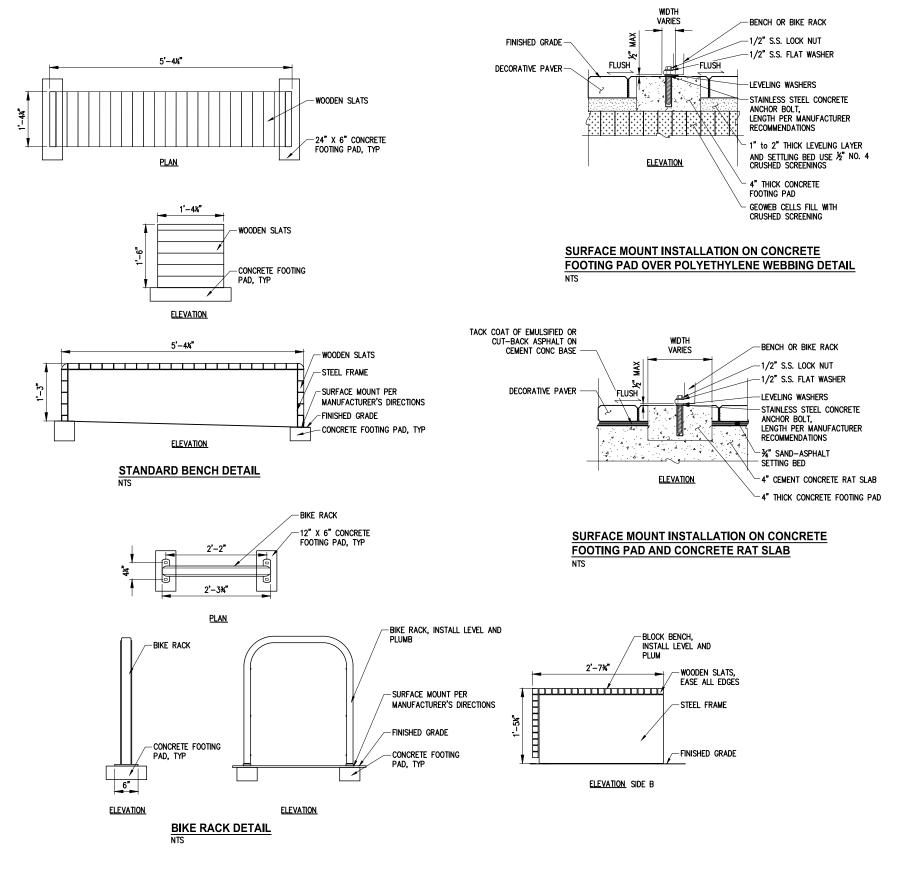

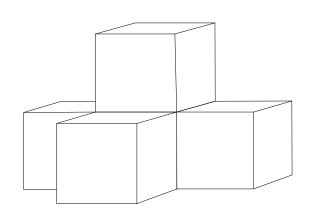


5 BLOCK BENCH UNITS (4 AT BASE AND ONE AT TOP).

<u>ISOMETRIC</u>

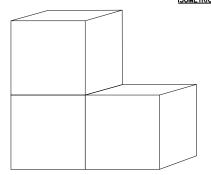

3 BLOCK BENCH UNITS (2 AT BASE AND ONE AT TOP).

<u>ISOMETRIC</u>

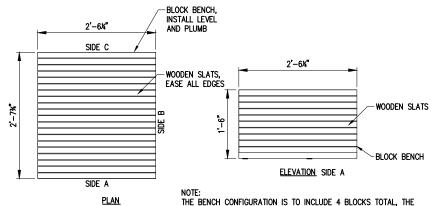

THE BENCH CONFIGURATION IS TO INCLUDE 4 BLOCKS TOTAL, THE MIDDLE BLOCK BEING (2) BLOCKS STACKED ON ANOTHER. SEE MANUFACTURERS SPECIFICATION FOR ATTACHING AND STACKING THE BLOCK BENCH.

BLOCK BENCH DETAIL

DATE NO. REVISION

ED. AID PROJ. NO. URVEY NO.: FIELD BOOK(S): HORZ. DATUM: VERT. DATUM: WSPCS, N ZONE, NAD 83/11 NAVD 88 DRAWN BY: DESIGNED BY: 4/2023 4/2023



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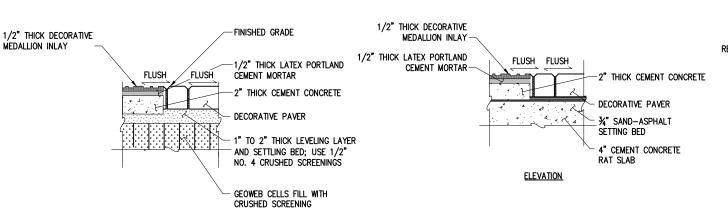



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LAKE ST & KIRKLAND AVE PEDESTRIAN IMPROVEMENTS


URBAN DESIGN DETAILS

SHEET NO SHEET OF 37




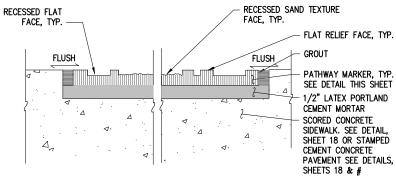

SECTION AT SCORED CONCRETE SIDEWALK

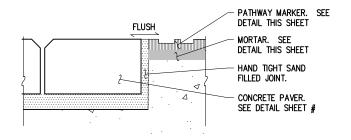

SECTION AT CONCRETE PAVERS

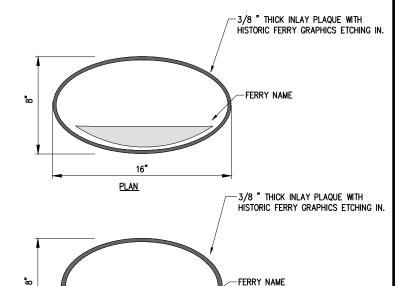

DECORATIVE MEDALLION INLAY DETAIL

<u>PLAN</u>

DECORATIVE MEDALLION INLAY OVER CONCRETE RAT SLAB DETAIL



ELEVATION

DECORATIVE MEDALLION INLAY OVER POLYETHYLENE WEBBING DETAIL





TYPE B LAYOUT



TYPE © LAYOUT



TYPE D LAYOUT







TYPE 🕏 LAYOUT

TYPE (F) LAYOUT

TYPE © LAYOUT

DECORATIVE MEDALLION INLAY GRAPHICS NTS

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	DESIGNED BY:	1/2023	DRAWN BY:	4/2023
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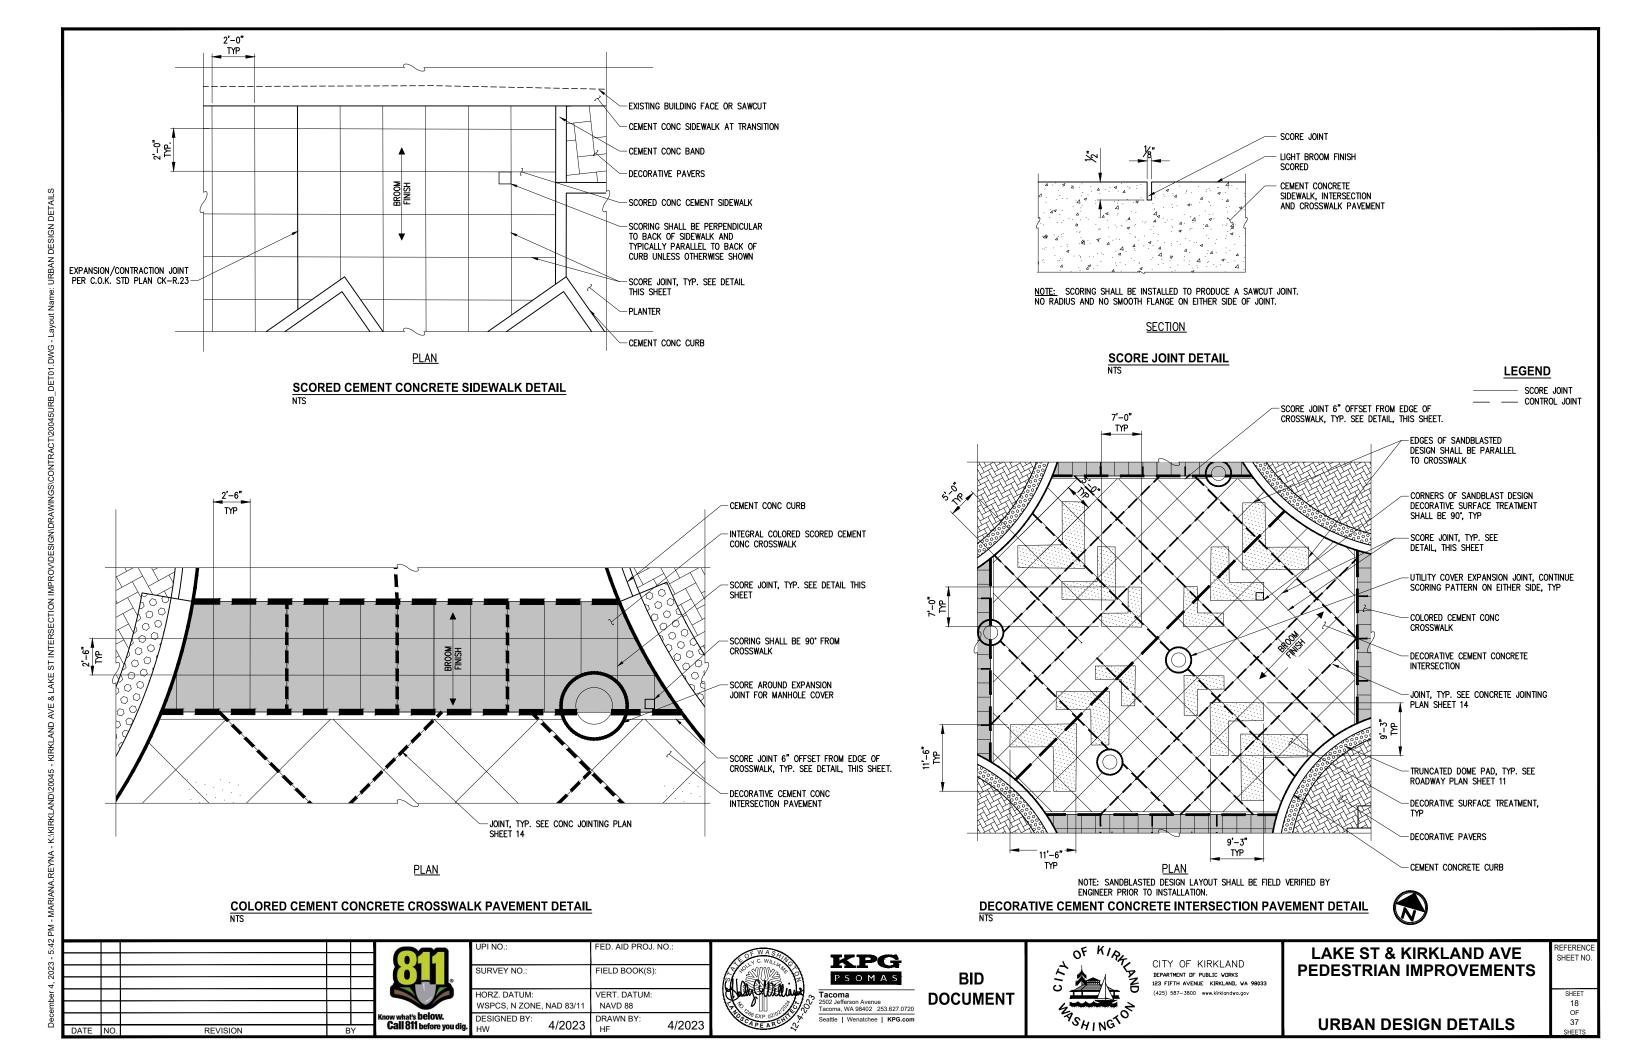
LAKE ST & KIRKLAND AVE PEDESTRIAN IMPROVEMENTS


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17 OF 37







PLANT SCHEDULE

SYMBOL		BOTANICAL NAME/COMMON NAME		SIZE	REMARKS
	SHRU	BS, GRASSES, AND GROUNDCOVERS			
\bigcirc	S1	SARCOCOCCA HOOKERIANA VAR. HUMILIS / DWARF HIMALAYAN SWEETBOX	13	1 GAL. CONT.	42" O.C. TRI. SP. TYP.
	GC1	EPIMEDIUM X PERRALCHICUM 'FROHNLEITEN'/ BARRENWORT	85	QUART CONT.	18" O.C. TRI. SP. TYP.
	GC2	HELLEBORUS 'ANNA'S RED' / ANNA'S RED HELLEBORE*	40	1 GAL. CONT.	24" O.C. TRI. SP. TYP.
	GC3	HEMEROCALLIS X 'STELLA DE ORO'/ STELLA DE ORO DWARF DAYLILY**	19	1 GAL. CONT.	24" O.C. TRI. SP. TYP.
+	G1	LIRIOPE MUSCARI 'BIG BLUE'/ BIG BLUE LILYTURF	32	QUART CONT.	18" O.C. TRI. SP. TYP.
•	G2	ACORUS GRAMINEUS 'OGON'/GOLDEN VARIEGATED SWEET FLAG	78	QUART CONT.	15" O.C. TRI. SP. TYP.
	B1	GALANTHUS NIVALIS / SNOWDROPS*	50	BULB	8" O.C. TRI. SP. TYP.
	B2	CROCUS 'BLUE PEARL' / SNOW CROCUS**	35	BULB	8" O.C. TRI. SP. TYP.

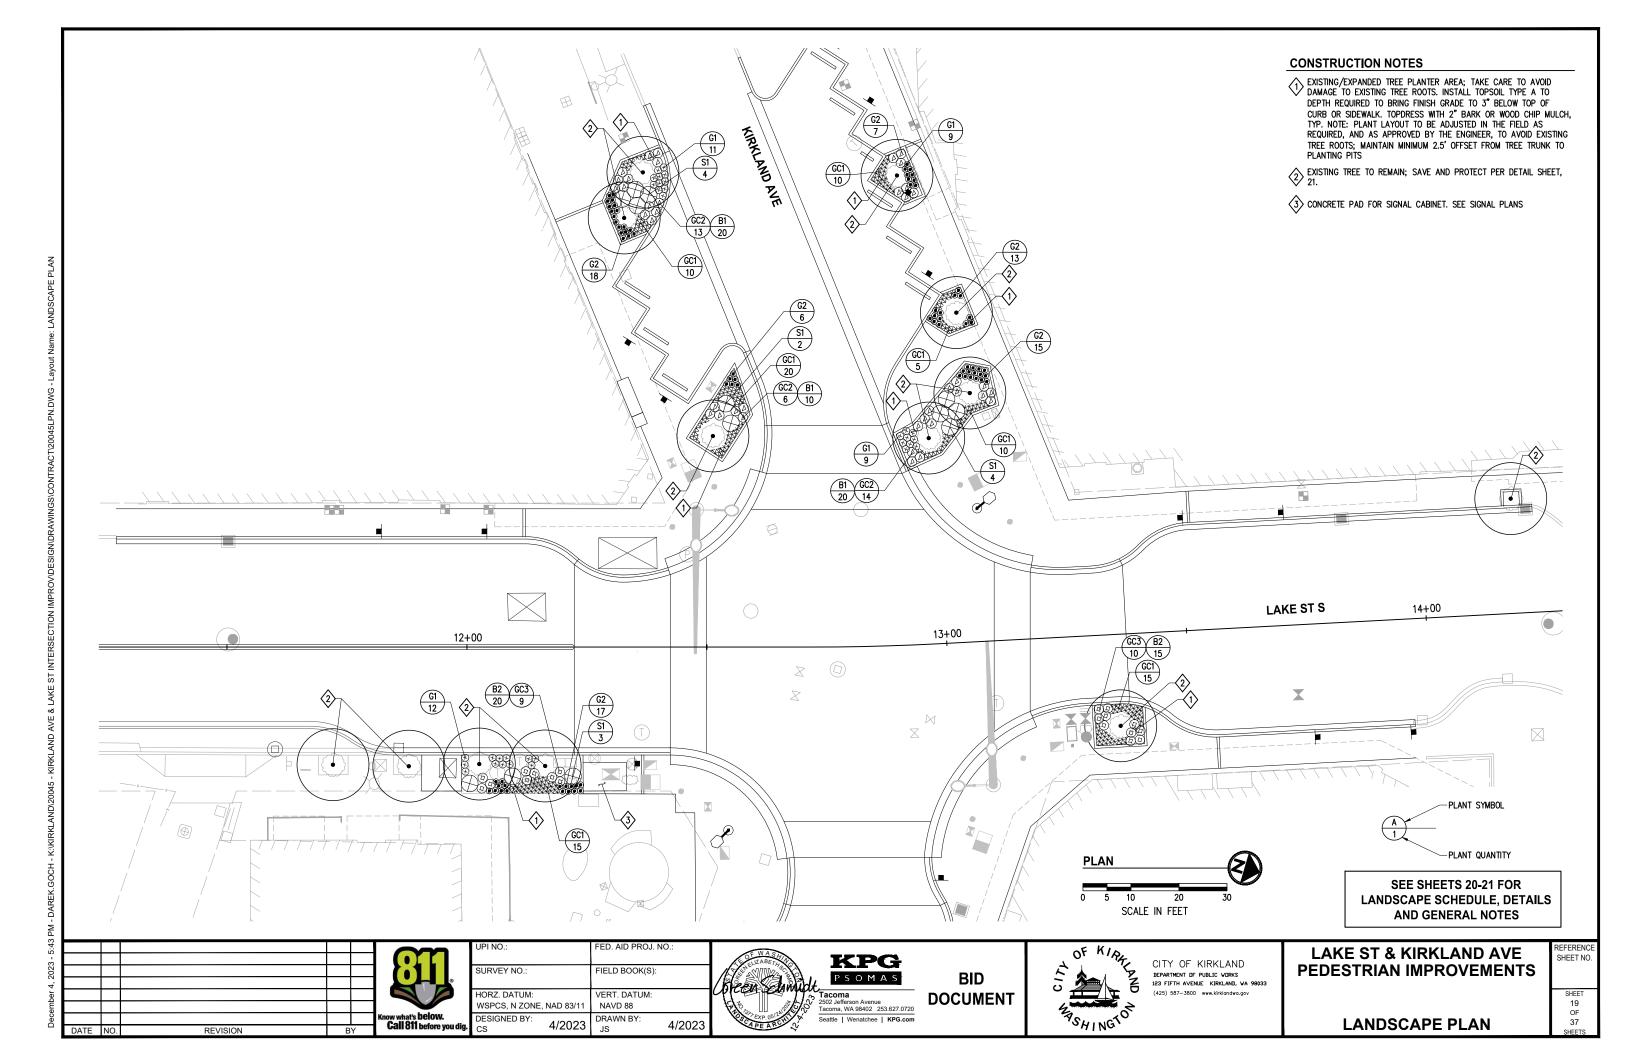
*UNDER-PLANT HELLEBORUS WITH GALANTHUS NIVALIS
**UNDER-PLANT HEMEROCALLIS WITH CROCUS

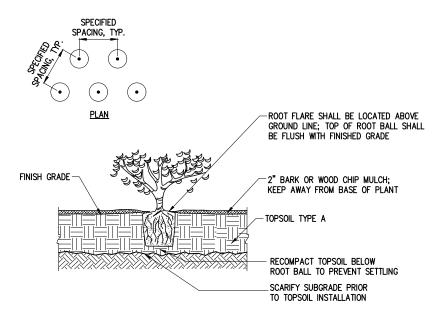

TYPICAL SHRUB/GROUNDCOVER PLANTING DETAIL
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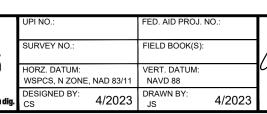
TRIANGULAR SPACING PLAN

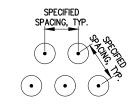

TYPICAL BULB PLANTING DETAIL
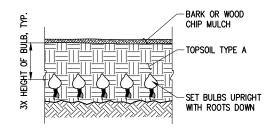
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LAKE ST & KIRKLAND AVE PEDESTRIAN IMPROVEMENTS

GENERAL NOTES

1. ALL PLANT MATERIALS SHALL MEET THE AMERICAN STANDARD FOR NURSERY STOCK, ANSI Z60.1 MOST CURRENT VERSION.
2. PLANT, MAINTAIN AND WARRANTY AS PER SPECIAL PROVISIONS.
3. DO NOT SUBSTITUTE SPECIES WITHOUT THE APPROVAL OF ENGINEER.
4. INSTALL 2" BARK OR WOOD CHIP MULCH OVER ALL DISTURBED AREAS NOT BEING PLANTED OR SEEDED, UNLESS OTHERWISE NOTED. FEATHER


5. PROPERTY RESTORATION TO BE DONE AS DIRECTED BY THE PROJECT


MULCH TO EDGE OF PAVEMENT OR BACK OF CURB.

LANDSCAPE SCHEDULE & DETAILS

REFERENCE SHEET NO.

SHEET
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37
SHEETS

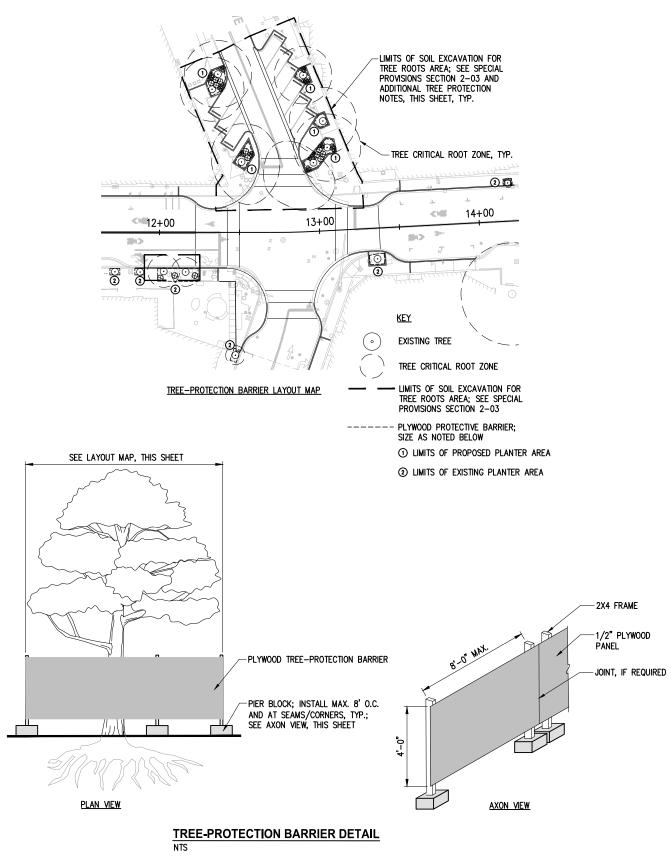

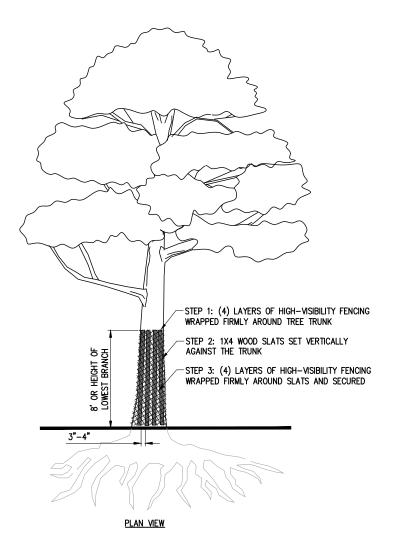

TRUNK-PROTECTION DETAIL

ED. AID PROJ. NO. URVEY NO.: FIELD BOOK(S): HORZ. DATUM: VERT. DATUM: WSPCS, N ZONE, NAD 83/11 NAVD 88 DESIGNED BY: DRAWN BY: 4/2023 4/2023 REVISION



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CITY OF KIRKLAND 123 FIFTH AVENUE KIRKLAND, WA 98033

LAKE ST & KIRKLAND AVE PEDESTRIAN IMPROVEMENTS

TREE PROTECTION GENERAL NOTES

2. PRIOR TO THE START OF CONSTRUCTION ACTIVITIES.

ROOTS ARE COVERED.

WITH SOIL AS SOON AS POSSIBLE.

MEASURES SHALL APPLY.

ALL TREES TO REMAIN SHALL BE TAGGED FOR APPROVAL BY THE ENGINEER PRIOR TO THE START OF CONSTRUCTION ACTIVITIES.

TREE-PROTECTION BARRIER SHALL BE INSTALLED WHERE SHOWN IN

INSTALLATION. SEE ADDITIONAL REQUIREMENTS FOR EXISTING TREES WITHIN LIMITS OF SOIL EXCAVATION FOR TREE ROOTS AREA, THIS

TREE-PROTECTION BARRIER SHALL CONSIST OF ½" PLYWOOD INSTALLED ON A 2X4 FRAME ANCHORED TO PIER BLOCKS, AS DETAILED, THIS SHEET. DO NOT DRIVE POSTS OR STAKES INTO THE GROUND. DO NO BLOCK PEDESTRIAN ACCESS ROUTE.

4. MULCH ENTIRE AREA WITHIN TREE-PROTECTION BARRIER LIMITS WITH 6" DEPTH ARBORIST WOOD CHIP MULCH. MULCH SHALL REMAIN IN PLACE UNTIL PLANTER AREA IS BACKFILLED WITH TOPSOIL AND TREE

5. TREATMENT OF ROOTS EXPOSED DURING CONSTRUCTION: FOR ROOTS

OVER 1" IN DIAMETER DAMAGED DURING CONSTRUCTION; MAKE A

CLEAN, STRAIGHT CUT TO REMOVE DAMAGED PORTION OF ROOT. FOR ROOTS OVER 2" DIAMETER, SEE SPECIAL PROVISIONS, SECTION 2-03. ALL ROOTS TEMPORARILY EXPOSED DURING CONSTRUCTION SHALL BE COVERED WITH DAMP BURLAP TO PREVENT DRYING, AND COVERED

WORK WITHIN TREE-PROTECTION BARRIER SHALL BE DONE MANUALLY. NO STOCKPILE OF MATERIALS, VEHICULAR TRAFFIC, OR STORAGE OF EQUIPMENT OR MACHINERY SHALL BE ALLOWED WITHIN THE LIMITS OF

7. MAINTAIN TREE-PROTECTION BARRIER IN PLACE UNTIL THE CITY

AREA INSIDE OF THE BARRIER IS NOT TO BE DISTURBED UNLESS PRIOR APPROVAL HAS BEEN OBTAINED FROM THE ENGINEER.

ADDITIONAL TREE PROTECTION NOTES WITHIN

FOR ALL EXISTING TREES WITHIN LIMITS OF SOIL EXCAVATION FOR

AGAINST THE TRUNK AT 3"-4" INTERVALS, THEN AN ADDITIONAL

THE WOOD SLATS AND SECURED TO HOLD THEM IN PLACE.

4. FOLLOWING COMPLETION OF PAVEMENT REMOVAL AND EXCAVATION ACTIVITIES, TRUNK PROTECTION SHALL BE REMOVED AND

PROTECTION GENERAL NOTES, THIS SHEET.

FOUR LAYERS OF HIGH-VISIBILITY FENCING WRAPPED FIRMLY AROUND

TREE-PROTECTION BARRIER SHALL BE INSTALLED WHERE SHOWN IN

THE LAYOUT MAP, THIS SHEET, AND SHALL REMAIN IN PLACE FOR

THE REMAINING DURATION OF CONSTRUCTION ACTIVITIES. SEE TREE

TREE ROOTS AREA, THE FOLLOWING ADDITIONAL PROTECTION

SOIL EXCAVATION FOR TREE ROOTS AREA

2. PRIOR TO THE START OF CONSTRUCTION ACTIVITIES, TRUNK PROTECTION SHALL BE INSTALLED AND SHALL REMAIN IN PLACE UNTIL PAVEMENT REMOVAL AND EXCAVATION ACTIVITIES HAVE BEEN COMPLETED. TRUNK PROTECTION SHALL BE APPROVED BY THE ENGINEER PRIOR TO THE START OF CONSTRUCTION ACTIVITIES. TRUNK PROTECTION SHALL CONSIST OF A MINIMUM OF FOUR LAYERS OF HIGH-VISIBILITY FENCE, WRAPPED FIRMLY AROUND THE TRUNK TO A HEIGHT OF 8' OR TO THE LOWEST BRANCH IF (WHICHEVER IS LOWER), THEN A LAYER OF 1X4X8' WOOD SLATS SET VERTICALLY

AUTHORIZES REMOVAL OR A FINAL APPROVAL IS ISSUED. SIGNS SHALL BE ATTACHED TO THE TREE-PROTECTION BARRIER STATING THAT THE TREE IS DESIGNATED FOR PROTECTION AND THE


THE LAYOUT MAP, THIS SHEET. LAYOUT OF TREE PROTECTION

FENCING SHALL BE APPROVED BY THE ENGINEER PRIOR TO

SHEET

REFERENC

TREE PROTECTION DETAILS

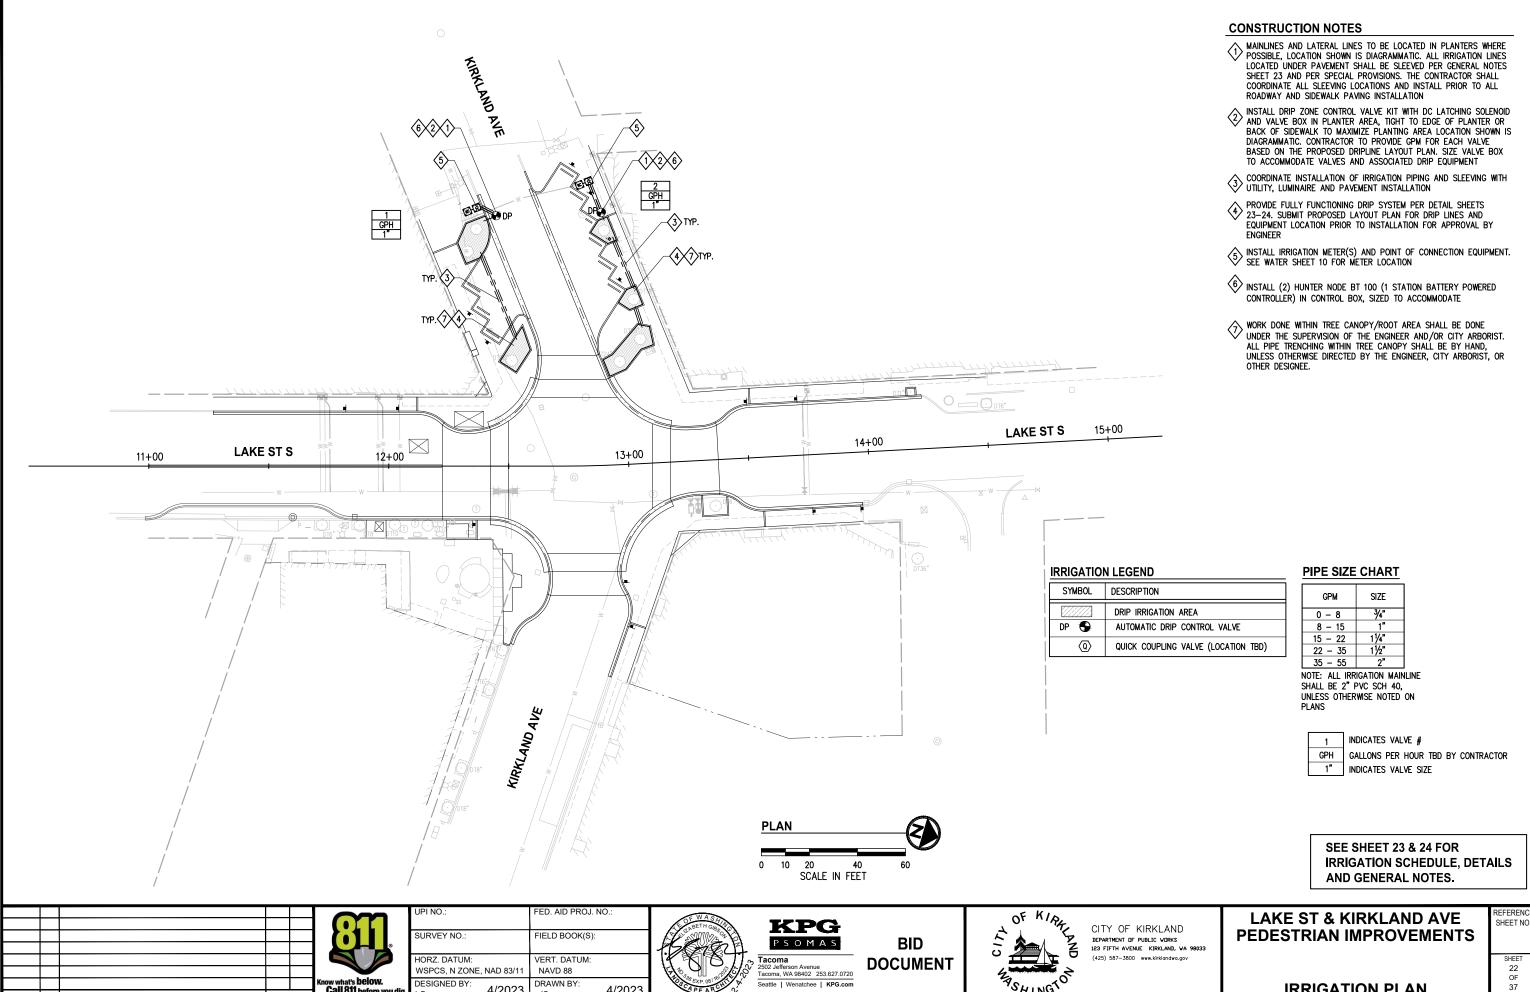

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REVISION


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4/2023

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IRRIGATION PLAN

- 4 COILED WIRE TO BATTERY OPERATED CONTROLLER
- 5 FINISH GRADE AT ADJACENT SURFACE (TURF OR MULCH)
- (6) SCH. 80 CLOSE NIPPLE, MATCH SIZE TO VALVE
- (7) PVC SLIP X FPT UNION



- (12) IRRIGATION LATERAL
- MAINLINE LATERAL AND FITTINGS

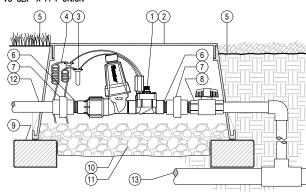



VALVE BOX

FINISHED GRADE

QUICK COUPLER

- 3' #4 REBAR STAKE


PVC PRESSURE MAIN

PVC NIPPLE


(2) STAINLESS STEEL CLAMPS TO STAKE

360° PVC TRIPLE SWING JOINT

- COORDINATE INSTALLATION OF IRRIGATION SYSTEM WITH INSTALLATION OF OTHER UTILITIES. LOCATE AND PROTECT ALL UNDERGROUND UTILITIES DURING INSTALLATION OF IRRIGATION SYSTEM.
- 2. CONTRACTOR MUST COORDINATE SLEEVING, ROAD CROSSING AND PIPE LOCATIONS WITH INSTALLATION OF UNDERGROUND UTILITIES (INCLUDING ELECTRICAL, SEWER, WATER AND GAS), SIDEWALK, URBAN DESIGN FEATURES AND ILLUMINATION.
- 3. IRRIGATION SYSTEM SHALL BE INSTALLED, TESTED, MAINTAINED AND GUARANTEED AS PER SPECIFICATIONS.
- LOCATION OF IRRIGATION MAINLINE, LATERALS, SLEEVING AND VALVES INDICATED ON DRAWING ARE DIAGRAMMATIC ONLY. ADJUST LOCATIONS AS NECESSARY. DO NOT OVERSPRAY ONTO PAVED
- 5. MAINLINE SHALL BE BURIED AT A DEPTH OF 24" BELOW FINISH GRADE. LATERAL LINES SHALL BE BURIED TO A DEPTH OF 18" BELOW FINISH GRADE.
- SLEEVE UNDER ALL PAVED SURFACES AND CONCRETE SIDEWALK. SEE IRRIGATION PLANS FOR LOCATION OF PVC SLEEVING, SLEEVING SHALL BE 2 TIMES THE DIAMETER OF THE INSERT PIPE AND WIRES.
- CONTROLLER WIRES SHALL BE TAPED TO IRRIGATION MAIN OR LATERAL LINES WHERE POSSIBLE. IF NOT AVAILABLE, WIRES TO CONTROLLER SHALL BE PLACED IN 1" /1.5" SLEEVE, USE 3M DBY
- ALL EQUIPMENT SHALL BE AS SPECIFIED OR APPROVED EQUAL. SYSTEM IS SPECIFICALLY DESIGNED FOR IRRIGATION EQUIPMENT SHOWN ON PLANS AND SUBSTITUTION WILL REQUIRE REDESIGN AND RECALCULATION OF IRRIGATION ZONES.

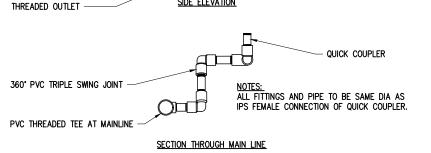

SIDE ELEVATION

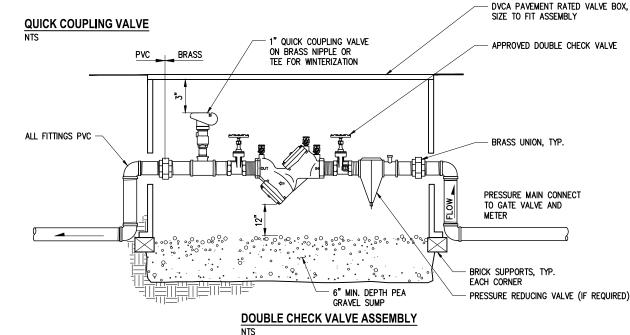

REVISION

	UPI NO.:		FED. AID PROJ. N	0.:
8	SURVEY NO.:		FIELD BOOK(S):	
'	HORZ. DATUM: WSPCS, N ZONE,	NAD 83/11	VERT. DATUM: NAVD 88	
u dig.	DESIGNED BY: LG	4/2023	DRAWN BY: JS	4/2023



KPG BID DOCUMENT Tacoma, WA 98402 253.627.0720



CITY OF KIRKLAND 123 FIFTH AVENUE KIRKLAND, WA 98033


NOTE: INSTALL ASSEMBLY IN ACCORDANCE WITH CURRENT CITY STANDARDS.

LAKE ST & KIRKLAND AVE PEDESTRIAN IMPROVEMENTS

SHEET

REFERENC

IRRIGATION SCHEDULE & DETAILS

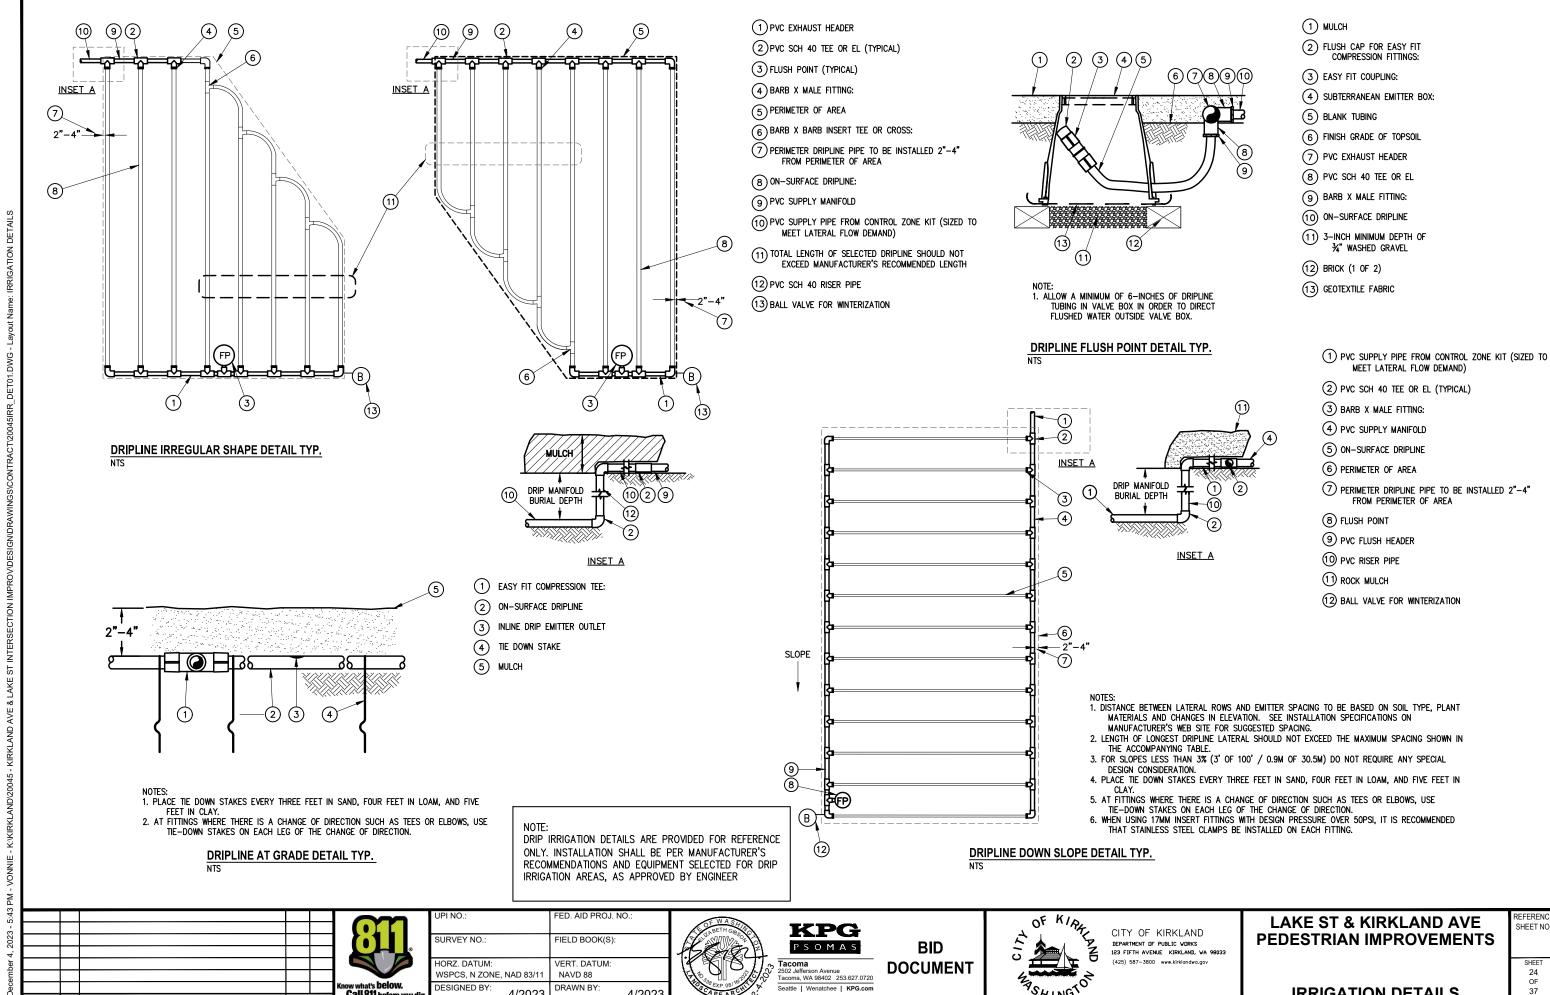

Seattle | Wenatchee | KPG.com


Call 811 before you dig

REVISION

4/2023

4/2023

IRRIGATION DETAILS

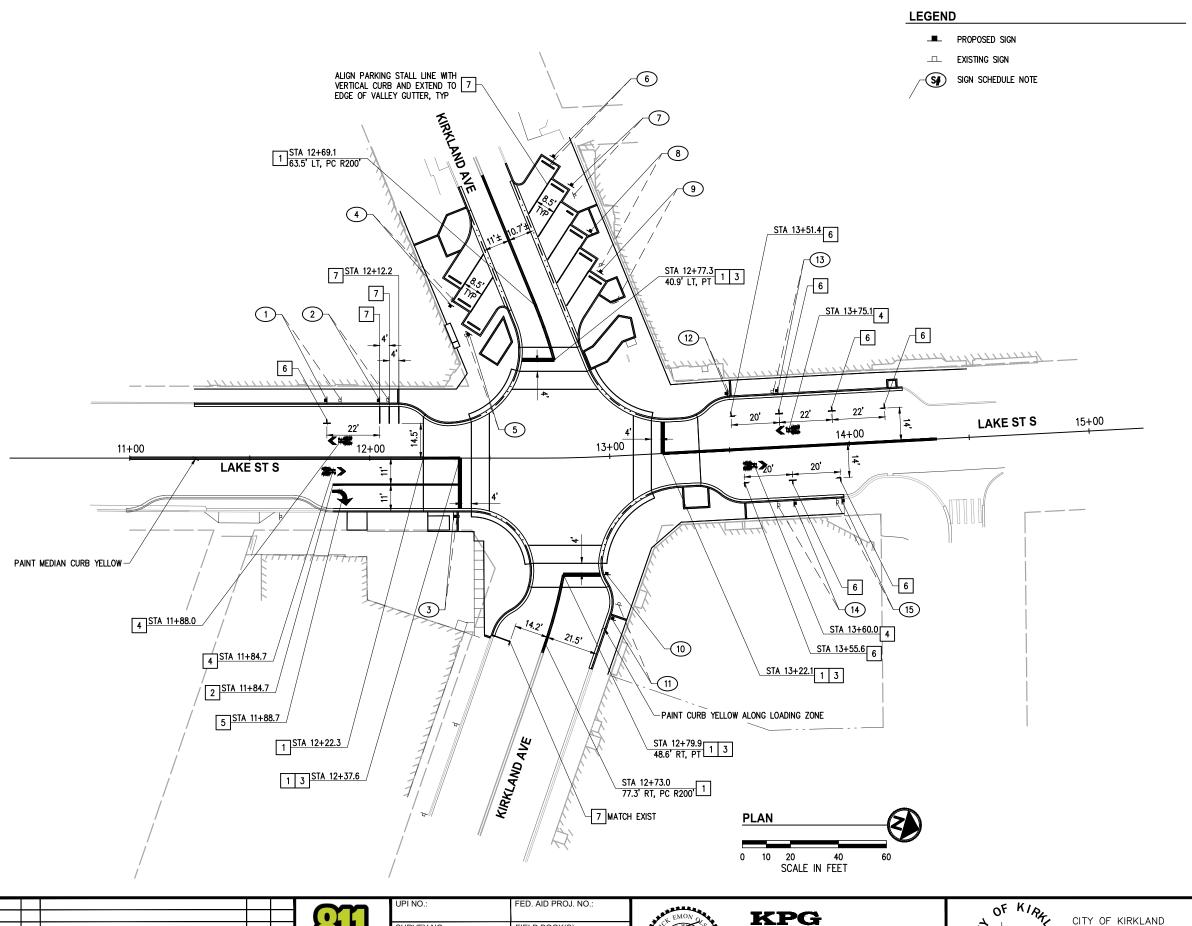

- ALL EXISTING STRIPING, MARKINGS, AND SIGNS IN CONFLICT WITH THE IMPROVEMENTS SHALL BE REMOVED.
- CONTRACTOR SHALL PRESERVE AND PROTECT ALL SIGNS NOT SPECIFICALLY CALLED OUT FOR REMOVAL OR RELOCATION, UNLESS DIRECTED OTHERWISE BY ENGINEER.
- 3. ALL SIGNAGE AND MARKINGS SHALL CONFORM TO THE LATEST EDITION OF THE MUTCD.
- STA/OFF CALLOUTS ARE TO CENTER OF LINE.
- 5. ARROWS AND SYMBOLS SHALL BE CENTERED IN LANE.
- ALL NEW AND RELOCATED SIGNS SHALL BE INSTALLED PER C.O.K. STD PLAN CK-R.43.
- 7. SEE SIGNAL SHEETS 26-29 FOR ADDITIONAL SIGNING.

CONSTRUCTION NOTES

- $\hfill \hfill \hfill$
- 2 TYPE D MMA 8" WHITE GORE STRIPE PER C.O.K. STD PLAN CK-R.31
- 3 TYPE D MMA STOP BAR PER C.O.K. STD PLAN CK-R.28
- 4 TYPE D MMA SHARED LANE MARKING PER C.O.K. STD PLAN CK-R.46
- 5 TYPE D MMA TRAFFIC ARROW PER WSDOT STD PLAN M-24.40
- 6 PARALLEL PARKING STALL MARKING PER DETAIL 6, SHEET 7
- 7 TYPE D MMA 4" WHITE LINE

SIGN SCHEDULE							
#	STATION	OFFSET	DESIGNATION	REMARKS			
S1	11+82.2	24.1' LT	TAKE-OUT PARKING, CURBSIDE PICKUP*	NEW*			
S2	12+04.2	24.1' LT	MOTORCYCLE PARKING	NEW			
S3	12+35.0	24.3' RT	R3-7R	NEW			
S4	12+33.8	63.9' LT	R7-108 "2 HR", NO BACK IN PARKING	NEW			
S5	12+41.3	52.0' LT	R7-108 "30 MIN", NO BACK IN PARKING	NEW			
S6	12+77.8	125.4' LT	R7-108 "30 MIN", NO BACK IN PARKING	NEW			
S7	12+87.3	113.3' LT	R7-108 "2 HR", NO BACK IN PARKING	NEW			
S8	12+96.2	93.8' LT	R7-108 "2 HR", NO BACK IN PARKING	NEW			
S9	13+00.0	76.7' LT	TAKE-OUT PARKING, NO BACK IN PARKING	NEW			
S10	12+96.4	49.2' RT	R10-11	NEW			
S11	12+97.6	68.0' RT	LOADING ZONE	NEW			
S12	13+50.4	23.6' LT	R7-108 "30 MIN"	NEW			
S13	13+71.4	23.6' LT	R7-108 "2 HR"	NEW			
S14	13+75.6	23.6' RT	R7-108 "2 HR"	NEW			
S15	13+95.6	23.6' RT	R7-108 "2 HR"	NEW			
REINSTA	LL EXISTING	CUSTOM PL	AQUE				

REINSTALL EXISTING CUSTOM PLAQUE

REVISION

SURVEY NO.: FIELD BOOK(S): HORZ. DATUM: VERT. DATUM: WSPCS, N ZONE, NAD 83/11 NAVD 88 DESIGNED BY: DRAWN BY: 4/2023 4/2023



PSOMAS BID **DOCUMENT** Tacoma, WA 98402 253.627.0720





CITY OF KIRKLAND DEPARTMENT OF PUBLIC WORKS
123 FIFTH AVENUE KIRKLAND, WA 98033

LAKE ST & KIRKLAND AVE PEDESTRIAN IMPROVEMENTS

REFERENCE

CHANNELIZATION & SIGNING PLAN

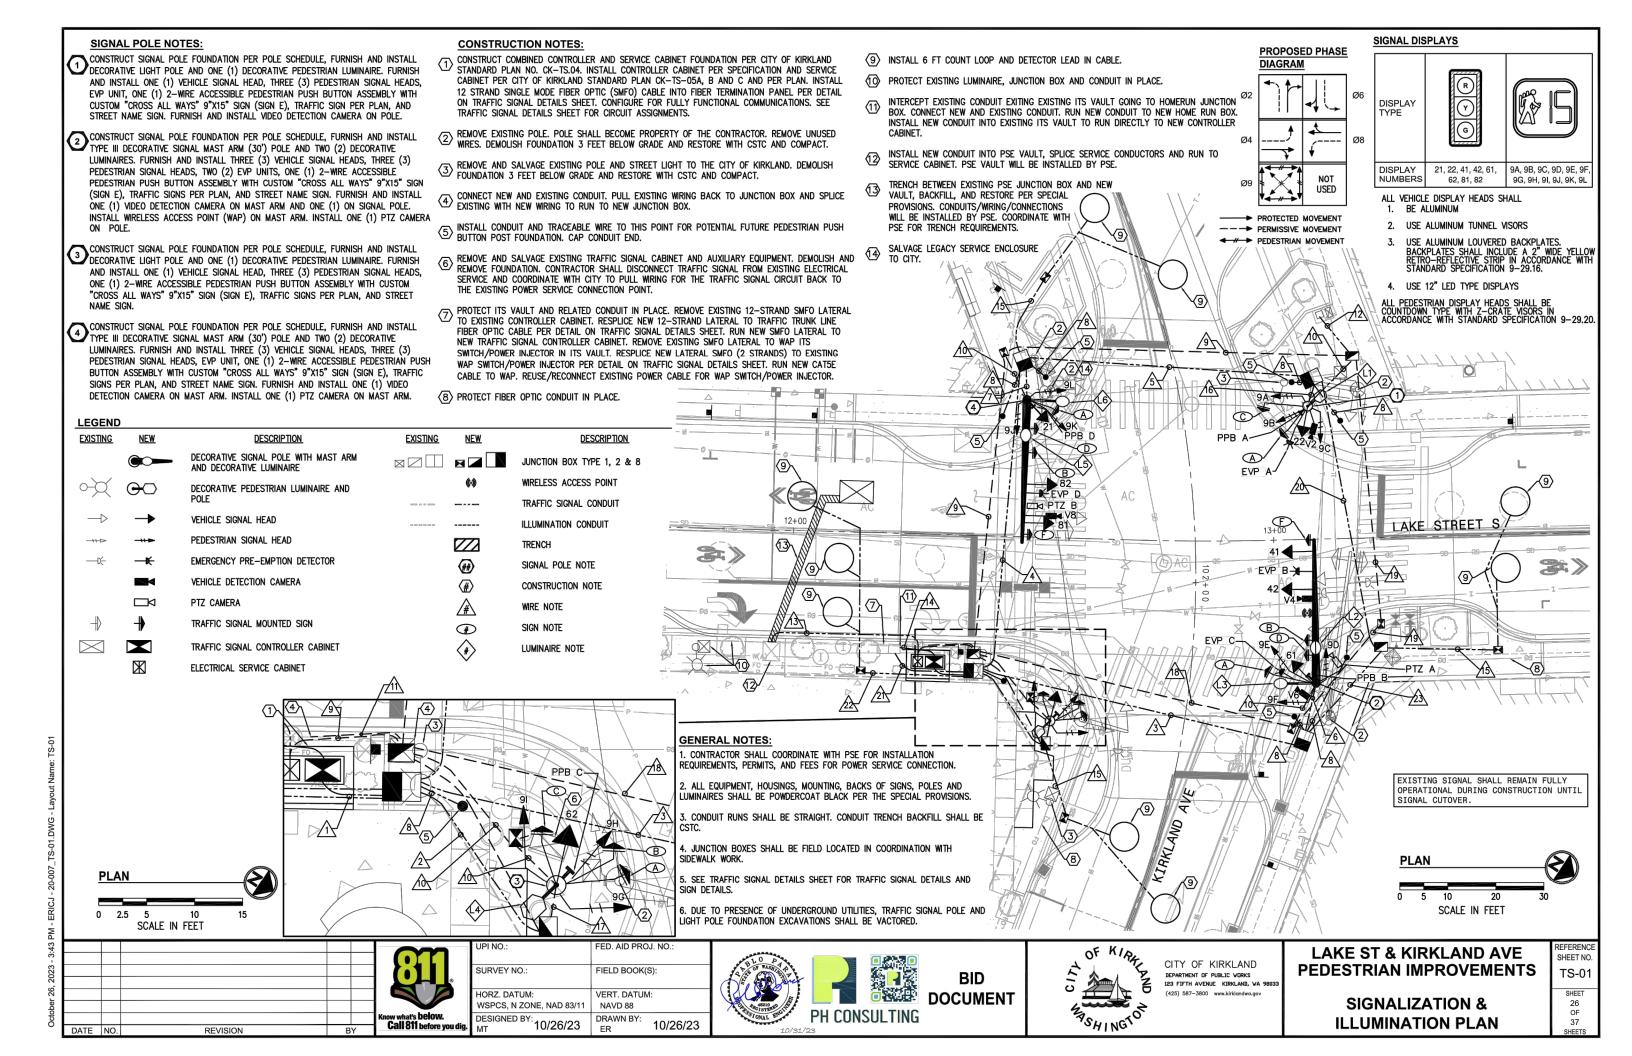

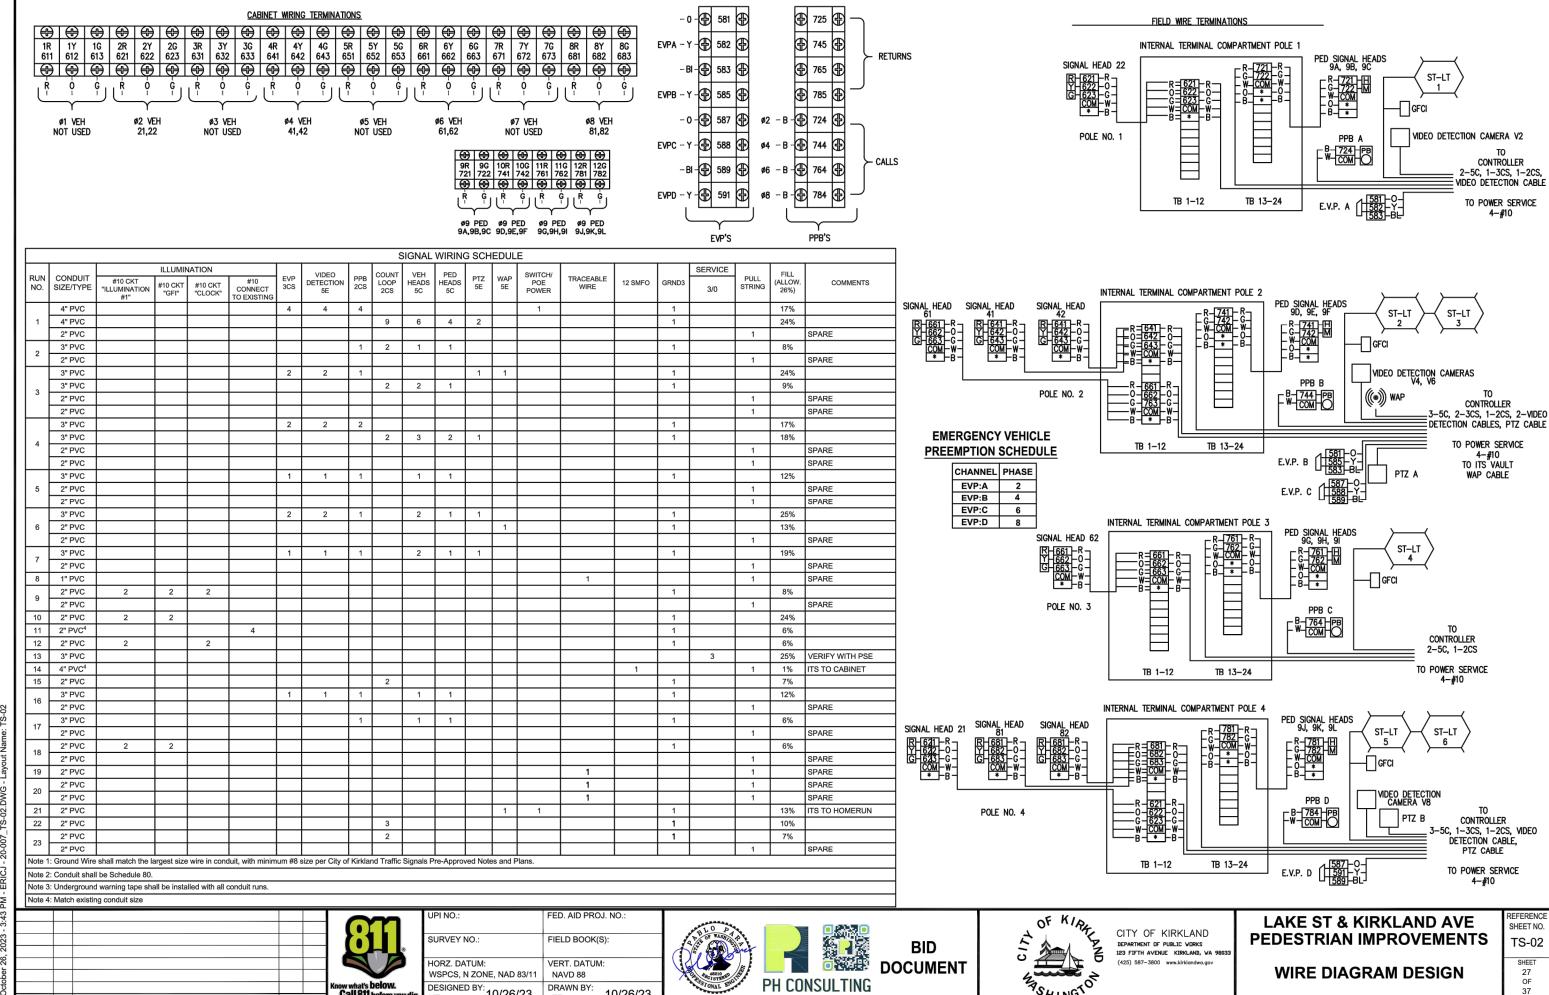

10/26/23


ER

10/26/23

DATE NO.

REVISION

BY

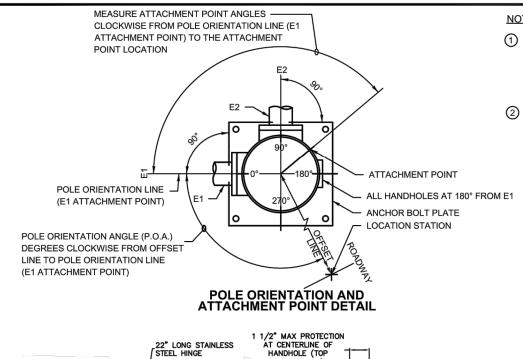

AND BOTTOM)

-24 SECTION TERMINAL BLOCK

6"x29" (I.D.) TERMINAL -COMPARTMENT 1/2"x4" STEEL FRAME

3/8" THICK BACKPLATE
16 1/2" TALL

NEUTRAL BUSS BAR

5/16"-18 TAPPED HOLE. -IN PLATE WITH 5/16"x1" GROUNDING BOLT

1" WIDE FLANGE__

(6 POSITIONS)

22" LONG STAINLESS | STEEL HINGE

BLACK POWDERCOAT STEEL COVER 30-1/2"x 30-3/4"x

6- 1"x 3/16" BLACK POWDERCOAT

STEEL SCREWS W/ BOLT AND WASHER

"BEST" BRAND_ SLAMLOCK

1"x 1/2" NEOPRENE GASKET

NOTES:

- 1 MOUNTING TENON FOR TYPE M MOUNT INSTALLED AT OFFSET DISTANCE INDICATED IN CHART. INSTALL PLUMBIZER BETWEEN RED AND YELLOW SIGNAL FACES. FOR TYPE N MOUNTS ONLY, DRILL 1" DIA. HOLE IN MAST ARM AND INSTALL PLASTIC SPLIT BUSHING FOR CABLE
- 2 FIELD INSTALLED.ALL SIGNAL POLES, MAST ARMS, LUMINAIRES, TERMINAL CABINETS, SIGNAL HEADS, MOUNTING HARDWARE, VIDEO, AND PTZ CAMERAS AND OTHER EQUIPMENT SHALL BE POWDER COATED BLACK PER SPECIAL PROVISIONS.

LUMINAIRE SCHEDULE

ROADWAY

PEDESTRIAN


ROADWAY

L4

- 3 1' 0" MIN. TO 2' 6" MAX. FROM POLE CENTERLINE TO SIGN EDGE
- FOR POST MOUNTED SIGNS THERE SHALL BE 2' - 0" MIN. FROM THE FACE OF THE CURB OR THE EDGE OF THE SHOULDER TO THE EDGE OF THE SIGN

LEGEND

- VEHICLE DISPLAY
- SIGN
- STREET NAME SIGN PRE-EMPTION DETECTOR
- POLE MOUNTED SIGN
- LUMINAIRE PEDESTRIAN DISPLAY
- INTERNAL TERMINAL COMPARTMENT
- PED PUSH BUTTON M HANDHOLE
- ITS CAMERA VIDEO DETECTION CAMERA
- WAP

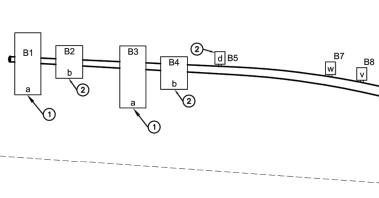

SIGNAL DISPLAY VERTICAL CLEARANCE TO ROADWAY

		MIN.		M/	٩X.	
HORIZON FROM STO	TAL DISTANCE OP LINE	ALL	40'	45'	50'	53' - 180'
3 SECTION 5 SECTION	N 12" N CLUSTER 12"	16.5'	17.5'	19.2'	20.9'	22.0'
4 SECTION	N 12"	16.5'	17.0'	18.0'	19.7'	20.8'
5 SECTION	N 12"	16.5'	17.0'	17.5'	18.5'	19.6'
М	EASURED FROM BOTTOM	OF SIGNAL I	HEAD HO	USING T	O ROADV	VAY

ROADWAY

LIMITS OF VERTICAL CLEARANCE TYPE II, III & SD SIGNAL STANDARD

CURB OR EDGE OF SHOULDER -TOP OF FOUNDATION ELEVATION PER TABLE AND SPECIAL PROVISIONS

FINISHED GRADE TO CENTER OF PUSHBUTTON-

INTERNAL TERMINAL COMPARTMENT DETAIL

STD	, I							МО	UNTIN	IG L									SIGNA	L MAS	T ARM	DATA																						\neg	FC	OUNDAT	TION DE	SIGN		
No.		FIE	ELD LOCA	TION			TYPE		SHT (F				OFFS	ET DIS	TANCES	(FT) (Z))				٧	VINDLO	DAD AR	REAS (FT ²) (X	(Y)		LUN	MINAIR	(X)(POLE	ATTACI	HMENT F	POINT	ANGLE	S (de	3)				SOIL	DEPTH (FT)	DEPTH (FT)	H DEPT (FT)	H REN	IARKS
	STREET	STATION	OFFSE	T LT. R	T. ELEV.	P.O.A		A1 ⁶	A2	V1	B1 B	2 B	B4	B5	B6 E	7 B8	В9	B10	B11	B1 B	2 B3	В4	B5 B	36 B7	7 B8	В9 В	10 B11	5 AR	EA C	(F		01 [)2 E	Fa	Fe(A)	Fe(B)	Fe(C,)) G1	G2	G3	Н		к	٧	PSF	3' RD.	3' SQF	R 4'RD).	
1	Lake Street	13.07.76	27.77	Х	33.37	90	LIGHT		15.5	22																		3.	3 3	\Box	10 1	35		0	315		0	90	45	180	135	315		0	1000	10	8	8		
2	Lake Street	13+08.11	29.94]]	33.44	0	III	17.5	32	22	27 29	.8 19	10.5	23		5 17.	0		5.5	9.2 6.	0 9.2	5.0		1.0	0		36.	0 3.	3 6	8	87	0 2	70 0	270	315			90	45	180	180	315	F	270	000	N/A	9	9		
3	Lake Street	12+54.48	38.17		33.39	90	LIGHT		15.5								\Box				\top	П						3.	3 3	T	10 1	35		0	315	270	0	90	45	180	135	315		\Box	1000	10	8	8		
4	Lake Street	12+47.78	28.69	Х	32.90	0	III	17.5	32		26 29	.0 17	5 10.5	19.5		24	22	Π	5.5	9.2 6.	0 9.2	5.0					36.	0 3.	3 6	8	340	0 2	70 0	270	315			90	45	180	180	315		$\Box \top$	1000	N/A	9	9		

FAMAR36

FAMAR72

FAMAR36

FAMAR72

FAMAR72

TE 1: FOUNDATION PER WSDOT STD J-26.10. GROUT PAD SHALL BE TALLER AND ANCHOR BOLTS SHALL BE 4 INCHES LONGER THAN TYPICAL. SEE "DECORATIVE PAVER ON CEMENT CONCRETE SLAB SECTION" AND THE "DECORATIVE PAVER WITH POLYETHYLENE WEB SYSTEM SECTION" DETAILS ON SHEET 5 FOR TOP OF FOUNDATION, PAVER, AND

NOTE 2: POA FOR LIGHT POLES IS ASSUMED TO BE AT 90 DEGREES CLOCKWISE FROM PERPENDICULAR LINE DRAWN TO ROADWAY CENTERLINE (AS IF THERE WERE A MAST ARM ON THE POLE)

NOTE 3: POLE ATTACHMENT POINT "F" MEANS FIELD VERIFIED BY ENGINEER

NOTE 4: VERIFY TOP OF FOUNDATION ELEVATION WITH ENGINEER PRIOR TO INSTALLATION, TOP OF FOUNDATION SHALL BE BELOW FINISHED GRADE TO ALLOW FOR UNINTERRUPTED FINISHED GRADE PAVER MATERIAL. SEE SPECIAL PROVISIONS FOR FOUNDAATION REQUIREMENTS.

NOTE 5: STREET NAME SIGN WINDLOAD AREA IN TABLE (B11) USED FOR CONSERVATIVE WIND LOAD CALCULATION, ACTUAL STREET NAME SIGN SIZE SHOWN IN DETAILS ON SHEET TS-04

NOTE 6: VERIFY MAST ARM MOUNTING HEIGHT WITH POLE MANUFACTURER BASED ON CURVATURE OF MAST ARM AND REQUIRED SIGNAL HEAD CLEARNACE MINIMUM OF 16.5' AND MAXIMUM OF 22

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Know what's below. Call 811 before you di						
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	UPI NO.:	FED. AID PROJ. NO.:
	SURVEY NO.:	FIELD BOOK(S):
	HORZ. DATUM: WSPCS, N ZONE, NAD 83/11	VERT. DATUM: NAVD 88
dig.	DESIGNED BY: MT 10/26/23	DRAWN BY: 10/26/23







CITY OF KIRKLAND 123 FIFTH AVENUE KIRKLAND, WA 980

LAKE ST & KIRKLAND AVE PEDESTRIAN IMPROVEMENTS


POLE SCHEDULE PLAN

TS-03 SHEET 28 OF 37

REFERENC

SHEET NO.

DRAFT ELECTRICAL PANEL SCHEDULES

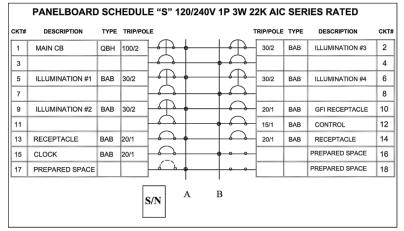



	PANELBOARI	SCHEDULE "T"	120/240V 1P 3W	22K AIC SE	RIES RATED	
СКТ#	DESCRIPTION	TYPE TRIP/POLE	-	TRIP/POLE TYPE	DESCRIPTION	СКТ#
1	MAIN CB	QBH 100/2	→ ••	20/1	ITS	2
3			-	15/1	WAP	4
5	SIGNAL	BAB 50/1	• 6 6		PREPARED SPACE	6
		S/N	A B			


POLARA

iNS-EXTHTRED: Extender for Height Reduction The MUTCD specifies a maximum push button height of 48" with no minimum specified. The recommended height is typically 42" above ground/standing grade, but it can be lower. Sometimes access ports on poles, or large decorative bases on poles, make mounting a push button within this height limit challenging. This extender is designed for these instances and allows an "iN" or "iNS" Navigator PBS, PBF2, or PBF2C to

extend out from the pole approximately 9" and reduce/adjust the button height by up to 15". This extender can be fastened to the pole by either banding (up to 1" wide) or bolted using the two ¼-20 mounting bolts supplied with each extender. It is constructed from welded steel, with a hot dipped galvanize coating.

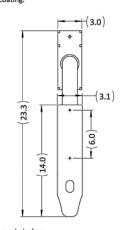

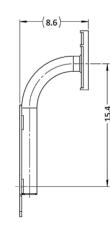

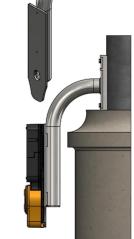

Doc. iNS-EXTHTRED-CutSheet Rev. A-25231 01/07/20

30"

DIAGONAL

CROSSING

3 P.M. - 6 P.M.

R3-2 (MOD)F

24"



(в)






(12" UPPERCÀSE, 9" MIN LOWERCASE LETTERING, WHITE ON GREEN)
PER MUTCD STANDARD





(91" X 18") (12" UPPERCASE, 9" MIN LOWERCASE LETTERING, WHITE ON GREEN)
PER MUTCD STANDARD

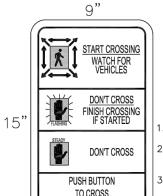


(BLACK) 9 X 15 BACKPLATE.

NO-ARROW BUTTON ASSEMBLY.

MODIFIED R10-3f SIGN PER DETAIL

R10-3f (MOD)(E)

ALL WAYS

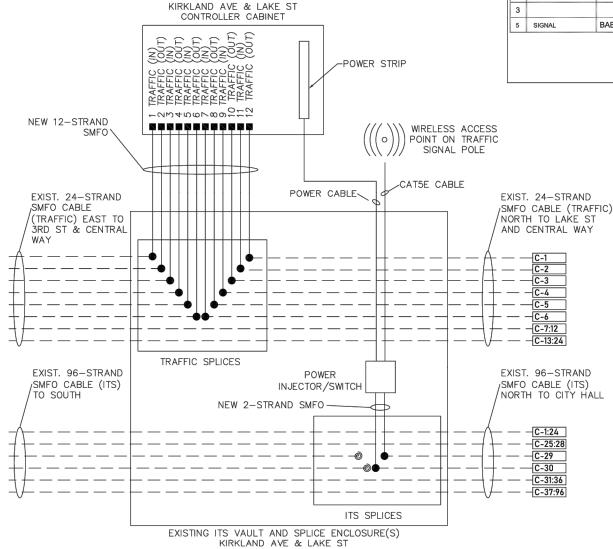

1 BUFFER TUBE-

FANOUT KIT

DATE NO.

REVISION

TERMINAL PANEL

ADAPTER PLATES

L1-SC CONNECTOR PER FIBER

-12CT FIBER OPTIC CABLE

FIBER TERMINATION PANEL DETAIL NOT TO SCALE

(WITH DOOR NOT SHOWN)

TERMINATE ALL 12 FIBERS IN

PANEL ON ADAPTER PLATES



FIBER SPLICE DETAIL

NOT TO SCALE

JPI NO.: FED. AID PROJ. NO. SURVEY NO.: FIELD BOOK(S): HORZ, DATUM: VERT. DATUM: WSPCS, N ZONE, NAD 83/11 NAVD 88 DESIGNED BY: 10/26/23 DRAWN BY: 10/26/23







CITY OF KIRKLAND 123 FIFTH AVENUE KIRKLAND, WA 980

LAKE ST & KIRKLAND AVE PEDESTRIAN IMPROVEMENTS


TRAFFIC SIGNAL DETAILS


TS-04 SHEET 29 OF 37

REFERENC

SHEET NO.

BID DOCUMENT

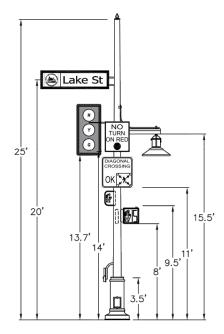

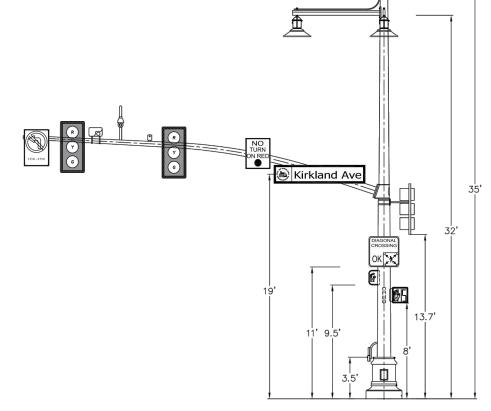

TRAFFIC SIGNAL DETAIL
AS VIEWED FROM EAST
SCALE 1"=4"

GENERAL NOTES:

 EQUIPMENT SHOWN TO SCALE. EQUIPMENT ATTACHMENT POINT AND ANGLE OF ATTACHMENT SIMPLIFIED. REFER TO SIGNAL STANDARD DETAIL CHART FOR MORE INFORMATION REGARDING EQUIPMENT ATTACHMENT POINTS AND ANGLES.


2. MOUNT PEDESTRIAN SIGNAL HEADS USING TYPE "E" SIDEMOUNT CLAMSHELL.

- 3. MOUNT MAST ARM VEHICLE SIGNAL HEAD USING TYPE "M" MOUNT.
- 4. MOUNT POLE MOUNTED VEHICLE SIGNAL USING TYPE "M" MOUNT WITH PELCO ASTRO-BRAC CLAMP KIT AND PLUMBIZER TUBE PER SPECIFICATIONS.
- 5. MOUNT POLE MOUNTED VIDEO DETECTION CAMERA WITH PELCO 2-PIECE EXTENDED TILT AND PAN CAMERA BRACKET PER SPECIFICATIONS.
- 6. MOUNT MAST ARM MOUNTED CCTV CAMERA WITH TKH GOOSENECK MOUNT PER SPECIFICATIONS. CONTRACTOR SHALL OBTAIN ENGINEERS FIELD APPROVAL OF MOUNTING HEIGHT AND ANGLE PRIOR TO DRILLING HOLES IN POLE.
- MOUNT POLE MOUNTED CCTV CAMERA WITH TKH POLE MOUNT PER SPECIFICATIONS.
 CONTRACTOR SHALL OBTAIN ENGINEERS FIELD APPROVAL OF MOUNTING HEIGHT AND
 ANGLE PRIOR TO DRILLING HOLES IN POLE.
- 8. MOUNT MAST ARM MOUNTED STREET NAME SIGNS WITH PELCO ASTRO SIGN-BRAC, STELLAR BAND MOUNT PER SPECIFICATIONS.
- 9. POLE MOUNTED STREET NAME SIGN MOUNTED WITH BRACKET PROVIDED WITH POLE.

10. MOUNT ACCESSIBLE PEDESTRIAN PUSH BUTTON ASSEMBLIES WITH POLARA INS—EXTHITED EXTENDER FOR HEIGHT REDUCTION PER DETAIL ON SHEET TS—04

TRAFFIC SIGNAL DETAIL AS VIEWED FROM SOUTH SCALE 1"=4' TRAFFIC SIGNAL DETAIL
AS VIEWED FROM WEST
SCALE 1"=4"

TRAFFIC SIGNAL DETAIL AS VIEWED FROM NORTH SCALE 1"=4'

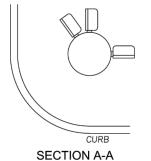


PEDESTRIAN SIGNAL HEAD LAYOUT

DATE NO. REVISION BY

UPI NO.:

SURVEY NO.:

HORZ. DATUM:
WSPCS, N ZONE, NAD 83/11
DESIGNED BY:
10/26/23

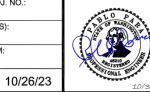

FED. AID PROJ. NO.

FIELD BOOK(S):

VERT. DATUM:

NAVD 88

DRAWN BY:







CITY OF KIRKLAND

BEPARTMENT OF PUBLIC VORKS

123 FIFTH AVENUE KIRKLAND, VA 98033


(425) 587–3800 www.kirklondwa.gov

LAKE ST & KIRKLAND AVE PEDESTRIAN IMPROVEMENTS

TRAFFIC SIGNAL POLE DETAIL

TS-05
SHEET
30
OF
37
SHEETS

SHEET NO.

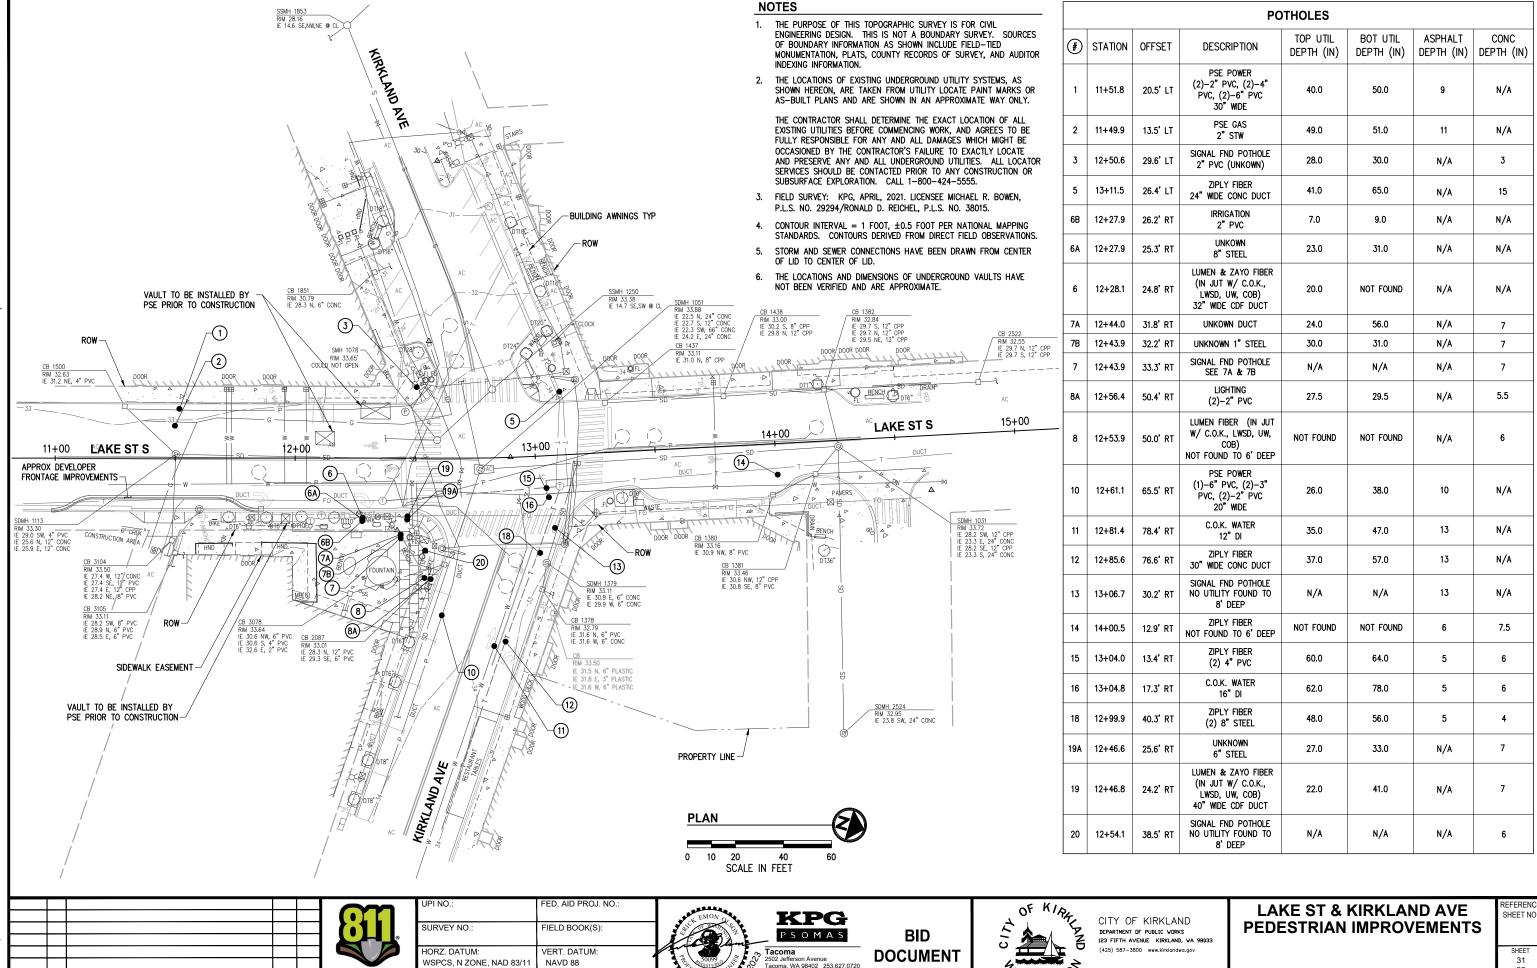

Tacoma, WA 98402 253,627,0720

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REVISION


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4/2023

4/2023

EXISTING CONDITIONS & POTHOLE PLAN



- SEE SPECIAL PROVISIONS SECTIONS 1-07.23, 1-08.0(2), AND 1-10 FOR TRAFFIC CONTROL REQUIREMENTS, WORK HOUR RESTRICTIONS, AND ALLOWABLE INTERSECTION, SIDEWALK, AND CROSSWALK
- 2. ACCESS TO BUSINESSES MUST BE MAINTAINED AT ALL TIMES DURING BUSINESS HOURS.
- IF DEVIATIONS FROM THE TRAFFIC CONTROL AND/OR CONSTRUCTION PHASING SHOWN IN THESE PLANS ARE PROPOSED, THE CONTRACTOR SHALL SUBMIT THEIR OWN TRAFFIC CONTROL AND/OR CONSTRUCTION PHASING PLANS TO THE ENGINEER FOR APPROVAL AT LEAST 14 DAYS PRIOR TO THE START OF ANY CONSTRUCTION PHASE OR PUBLIC NOTIFICATION OF CLOSURE. SEE SPECIAL PROVISIONS.
- 4. CONSTRUCTION ACTIVITIES NOT SPECIFICALLY SEQUENCED SHALL BE CONDUCTED IN A MANNER TO MINIMIZE PUBLIC IMPACT. FULL PROGRESS SCHEDULES IN ACCORDANCE WITH SECTION 1-08.3 OF THE SPECIFICATIONS ARE NECESSARY FOR ITEMS INCLUDING, BUT NOT LIMITED TO STORM DRAINS, WATER SYSTEM, UTILITY TRENCHING AND OTHER ITEMS AFFECTING TRAFFIC OR AGENCY COORDINATION.
- 5. CONFLICTING SIGNS AND CHANNELIZATION SHALL BE COVERED OR
- 6. SEE DETOUR PLAN SHEET 37 FOR DETOUR ROUTES AND SIGNAGE DURING INTERSECTION CLOSURE, AND PCMS BOARDS TO BE IN PLACE
- 7. ABRUPT PAVEMENT EDGES OF 2.5" OR GREATER TRANSVERSE TO THE ROADWAY SHALL BE WEDGED ACCORDING TO THE REQUIREMENTS OF STANDARD SPECIFICATION SECTION 1-07.
- 10. DURING FULL INTERSECTION CLOSURE, CONTRACTOR SHALL INSTALL FOUR "SIDEWALK OPEN, BIKES DISMOUNT" SIGNS AT LOCATIONS APPROVED BY THE ENGINEER. CITY WILL RETAIN OWNERSHIP OF SIGNS UPON COMPLETION OF CONSTRUCTION.
- 11. DURING FULL INTERSECTION CLOSURE, CONTRACTOR SHALL INSTALL FOUR "YES, BUSINESSES ARE OPEN" SIGNS (INCL CITY LOGO) ON BARRICADES WHERE NOTED. SIZE, LETTERING, COLORS, AND LAYOUT SHALL BE AS APPROVED BY THE ENGINEER. CITY WILL RETAIN OWNERSHIP OF SIGNS UPON COMPLETION OF CONSTRUCTION.
- 12. INSTALL "NO PARKING" SIGNS FOR PARKING STALLS ADJACENT TO ACTIVE WORK ZONE, LOCATIONS TO BE APPROVED BY THE ENGINEER.

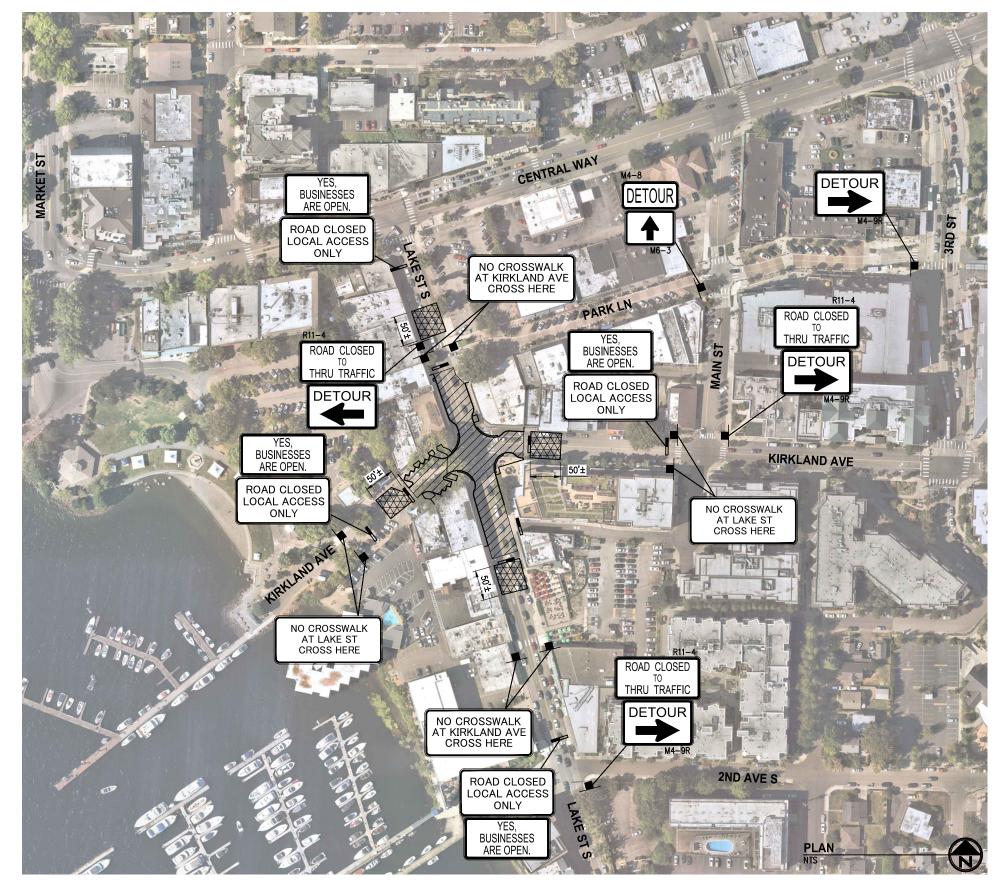TRAFFIC CONTROL LEGEND

WORK ZONE, INSTALL TEMPORARY FENCE PER SPECIAL PROVISIONS SECTION 1-07.23




NO PARKING ZONE/U-TURN AREA, INSTALL TEMPORARY 'NO PARKING' SIGNS AND 4" WHITE TEMP TAPE CROSSHATCH AS APPROVED BY THE ENGINEER



TYPE 3 BARRICADE (SIGN ATTACHED WHERE NOTED)

000					
Know what's below. Call 811 before you di					
Gall 811 before you di	Υ	В	. REVISION	NO.	DATE

SURVEY NO.: HORZ. DATUM: DESIGNED BY:

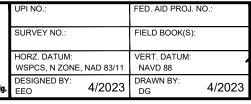



BID DOCUMENT



CITY OF KIRKLAND DEPARTMENT OF PUBLIC WORKS
123 FIFTH AVENUE KIRKLAND, WA 98033

LAKE ST & KIRKLAND AVE PEDESTRIAN IMPROVEMENTS

PHASE 1 - INTERSECTION CLOSURE TRAFFIC CONTROL & DETOUR PLAN 32

- SEE SPECIAL PROVISIONS SECTIONS 1-07.23, 1-08.0(2), AND 1-10 FOR TRAFFIC CONTROL REQUIREMENTS, WORK HOUR RESTRICTIONS, AND ALLOWABLE INTERSECTION, SIDEWALK, AND CROSSWALK
- 2. ACCESS TO BUSINESSES MUST BE MAINTAINED AT ALL TIMES DURING BUSINESS HOURS.
- IF DEVIATIONS FROM THE TRAFFIC CONTROL AND/OR CONSTRUCTION PHASING SHOWN IN THESE PLANS ARE PROPOSED, THE CONTRACTOR SHALL SUBMIT THEIR OWN TRAFFIC CONTROL AND/OR CONSTRUCTION PHASING PLANS TO THE ENGINEER FOR APPROVAL AT LEAST 14 DAYS PRIOR TO THE START OF ANY CONSTRUCTION PHASE OR PUBLIC NOTIFICATION OF CLOSURE. SEE SPECIAL PROVISIONS.
- 4. CONSTRUCTION ACTIVITIES NOT SPECIFICALLY SEQUENCED SHALL BE CONDUCTED IN A MANNER TO MINIMIZE PUBLIC IMPACT. FULL PROGRESS SCHEDULES IN ACCORDANCE WITH SECTION 1-08.3 OF THE SPECIFICATIONS ARE NECESSARY FOR ITEMS INCLUDING, BUT NOT LIMITED TO STORM DRAINS, WATER SYSTEM, UTILITY TRENCHING AND OTHER ITEMS AFFECTING TRAFFIC OR AGENCY COORDINATION.
- 5. CONFLICTING SIGNS AND CHANNELIZATION SHALL BE COVERED OR
- 6. SEE DETOUR PLAN SHEET 37 FOR DETOUR ROUTES AND SIGNAGE DURING INTERSECTION CLOSURE, AND PCMS BOARDS TO BE IN PLACE
- ABRUPT PAVEMENT EDGES OF 2.5" OR GREATER TRANSVERSE TO THE ROADWAY SHALL BE WEDGED ACCORDING TO THE REQUIREMENTS OF STANDARD SPECIFICATION SECTION 1-07.
- 10. DURING FULL INTERSECTION CLOSURE, CONTRACTOR SHALL INSTALL FOUR "SIDEWALK OPEN, BIKES DISMOUNT" SIGNS AT LOCATIONS APPROVED BY THE ENGINEER. CITY WILL RETAIN OWNERSHIP OF SIGNS UPON COMPLETION OF CONSTRUCTION.
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- 12. INSTALL "NO PARKING" SIGNS FOR PARKING STALLS ADJACENT TO ACTIVE WORK ZONE, LOCATIONS TO BE APPROVED BY THE ENGINEER.

TRAFFIC CONTROL LEGEND

WORK ZONE, INSTALL TEMPORARY FENCE PER SPECIAL PROVISIONS SECTION 1-07.23




NO PARKING ZONE/U-TURN AREA, INSTALL TEMPORARY 'NO PARKING' SIGNS AND 4" WHITE TEMP TAPE CROSSHATCH AS APPROVED BY THE ENGINEER



TYPE 3 BARRICADE (SIGN ATTACHED WHERE NOTED)

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CITY OF KIRKLAND DEPARTMENT OF PUBLIC WORKS
123 FIFTH AVENUE KIRKLAND, WA 98033

LAKE ST & KIRKLAND AVE PEDESTRIAN IMPROVEMENTS

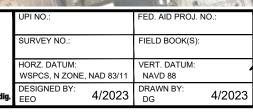PHASE 2 - PEDESTRIAN CONTROL

TRAFFIC CONTROL & DETOUR PLAN

- SEE SPECIAL PROVISIONS SECTIONS 1-07.23, 1-08.0(2), AND 1-10 FOR TRAFFIC CONTROL REQUIREMENTS, WORK HOUR RESTRICTIONS, AND ALLOWABLE INTERSECTION, SIDEWALK, AND CROSSWALK
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- 5. CONFLICTING SIGNS AND CHANNELIZATION SHALL BE COVERED OR
- 6. SEE DETOUR PLAN SHEET 37 FOR DETOUR ROUTES AND SIGNAGE DURING INTERSECTION CLOSURE, AND PCMS BOARDS TO BE IN PLACE
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- 10. DURING FULL INTERSECTION CLOSURE, CONTRACTOR SHALL INSTALL FOUR "SIDEWALK OPEN, BIKES DISMOUNT" SIGNS AT LOCATIONS APPROVED BY THE ENGINEER. CITY WILL RETAIN OWNERSHIP OF SIGNS UPON COMPLETION OF CONSTRUCTION.
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- 12. INSTALL "NO PARKING" SIGNS FOR PARKING STALLS ADJACENT TO ACTIVE WORK ZONE, LOCATIONS TO BE APPROVED BY THE ENGINEER.

TRAFFIC CONTROL LEGEND

WORK ZONE, INSTALL TEMPORARY FENCE PER SPECIAL PROVISIONS SECTION 1-07.23




NO PARKING ZONE/U-TURN AREA, INSTALL TEMPORARY 'NO PARKING' SIGNS AND 4" WHITE TEMP TAPE CROSSHATCH AS APPROVED BY THE ENGINEER



TYPE 3 BARRICADE (SIGN ATTACHED WHERE NOTED)

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CITY OF KIRKLAND DEPARTMENT OF PUBLIC WORKS
123 FIFTH AVENUE KIRKLAND, WA 98033

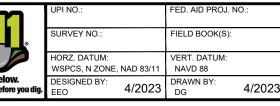LAKE ST & KIRKLAND AVE PEDESTRIAN IMPROVEMENTS

PHASE 3 - PEDESTRIAN CONTROL

TRAFFIC CONTROL & DETOUR PLAN

- SEE SPECIAL PROVISIONS SECTIONS 1-07.23, 1-08.0(2), AND 1-10 FOR TRAFFIC CONTROL REQUIREMENTS, WORK HOUR RESTRICTIONS, AND ALLOWABLE INTERSECTION, SIDEWALK, AND CROSSWALK
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TRAFFIC CONTROL LEGEND

WORK ZONE, INSTALL TEMPORARY FENCE PER SPECIAL PROVISIONS SECTION 1-07.23




NO PARKING ZONE/U-TURN AREA, INSTALL TEMPORARY 'NO PARKING' SIGNS AND 4" WHITE TEMP TAPE CROSSHATCH AS APPROVED BY THE ENGINEER



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CITY OF KIRKLAND DEPARTMENT OF PUBLIC WORKS
123 FIFTH AVENUE KIRKLAND, WA 98033

LAKE ST & KIRKLAND AVE PEDESTRIAN IMPROVEMENTS

PHASE 4 - PEDESTRIAN CONTROL TRAFFIC CONTROL & DETOUR PLAN

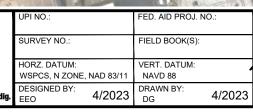- SEE SPECIAL PROVISIONS SECTIONS 1-07.23, 1-08.0(2), AND 1-10 FOR TRAFFIC CONTROL REQUIREMENTS, WORK HOUR RESTRICTIONS, AND ALLOWABLE INTERSECTION, SIDEWALK, AND CROSSWALK
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TRAFFIC CONTROL LEGEND

WORK ZONE, INSTALL TEMPORARY FENCE PER SPECIAL PROVISIONS SECTION 1-07.23



NO PARKING ZONE/U-TURN AREA, INSTALL TEMPORARY 'NO PARKING' SIGNS AND 4" WHITE TEMP TAPE CROSSHATCH AS APPROVED BY THE ENGINEER



TYPE 3 BARRICADE (SIGN ATTACHED WHERE NOTED)

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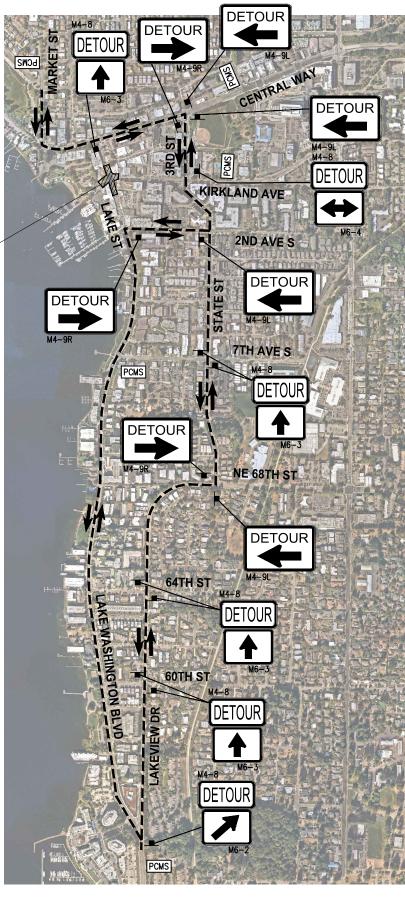
CITY OF KIRKLAND DEPARTMENT OF PUBLIC WORKS
123 FIFTH AVENUE KIRKLAND, WA 98033

LAKE ST & KIRKLAND AVE PEDESTRIAN IMPROVEMENTS

PHASE 5 - PEDESTRIAN CONTROL

TRAFFIC CONTROL & DETOUR PLAN

WORK ZONE, FULL INTERSECTION CLOSURE



LEGEND

PCMS

PORTABLE CHANGEABLE MESSAGE SIGN. SIGNS SHALL BE SOLAR POWERED AND PROGRAMMABLE. PCMS LOCATION AND MESSAGE LANGUAGE SHALL BE AS APPROVED BY THE ENGINEER/OWNER AND ADJUSTED BY THE CONTRACTOR THROUGHOUT CONSTRUCTION AS DIRECTED. PCMS BOARDS SHALL BE IN PLACE AND OPERATING 2 WEEKS PRIOR TO ANY WORK. CONTRACTOR IS RESPONSIBLE FOR PROGRAMMING THE APPROVED MESSAGES INTO THE PCMS BOARDS, SET-UP, PLACEMENT, AND REMOVAL UPON PROJECT COMPLETION.

DATE NO. REVISION BY

Know what's below.

Call 811 before your



FSOMAS BID

Tacoma
2502 Jeffrson Avenue
Tacoma, WA 98402 253.627.0720



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CITY OF KIRKLAND
DEPARTMENT OF PUBLIC VORKS
123 FIFTH AVENUE KIRKLAND, VA 98033
(425) 587-3800 www.kirklandwa.gov

LAKE ST & KIRKLAND AVE PEDESTRIAN IMPROVEMENTS

PHASE 1 - DETOUR
TRAFFIC CONTROL & DETOUR PLAN

SHEET 37 OF 37 SHEETS

REFERENCE SHEET NO.